

# DEVELOPMENT APPLICATION PDPLANPMTD-2025/054882

**PROPOSAL:** Dwelling

**LOCATION:** 62 Mannata Street, Lauderdale

**RELEVANT PLANNING SCHEME:** Tasmanian Planning Scheme - Clarence

**ADVERTISING EXPIRY DATE:** 17 September 2025

The relevant plans and documents can be inspected at the Council offices, 38 Bligh Street, Rosny Park, during normal office hours until 17 September 2025. In addition to legislative requirements, plans and documents can also be viewed at <a href="https://www.ccc.tas.gov.au">www.ccc.tas.gov.au</a> during these times.

Any person may make representations about the application to the Chief Executive Officer, by writing to PO Box 96, Rosny Park, 7018 or by electronic mail to <a href="mailto:clarence@ccc.tas.gov.au">clarence@ccc.tas.gov.au</a>. Representations must be received by Council on or before 17 September 2025.

To enable Council to contact you if necessary, would you please also include a day time contact number in any correspondence you may forward.

Any personal information submitted is covered by Council's privacy policy, available at www.ccc.tas.gov.au or at the Council offices.

# Clarence City Council



## APPLICATION FOR DEVELOPMENT / USE OR SUBDIVISION

The personal information on this form is required by Council for the development of land under the Land Use Planning and Approvals Act 1993. We will only use your personal information for this and other related purposes. If this information is not provided, we may not be able to deal with this matter. You may access and/or amend your personal information at any time. How we use this information is explained in our **Privacy Policy**, which is available at <a href="https://www.ccc.tas.gov.au">www.ccc.tas.gov.au</a> or at Council offices.

Proposal:	New Dwelling		
Location:	Address 62 Mannata Street		
	Suburb/Town Lauderdale	Postcode 7021	
Current Owners/s: Applicant:	Personal I	nformation Rer	moved
Tax Invoice for application fees to be in the name of: (if different from applicant)			
l	· ·		. 000,000
	Is the property on the Tasmanian He	ritage Register? Yo	es No X
	(if yes, we recommend you discuss your exemptions may apply which may save y	proposal with Heritage Tasmani ou time on your proposal)	a prior to lodgement as

If you had pre-applica Officer, please give the	ation discussions with a Council heir name			
Current Use of Site:	Empty Lot			
Does the proposal in	volve land administered or owned	Yes	No	X

#### Declaration:

- I have read the Certificate of Title and Schedule of Easements for the land and am satisfied that this application is not prevented by any restrictions, easements or covenants.
- I authorise the provision of a copy of any documents relating to this application to any person for the purposes of assessment or public consultation. I agree to arrange for the permission of the copyright owner of any part of this application to be obtained. I have arranged permission for Council's representatives to enter the land to assess this application
- I declare that, in accordance with Section 52 of the Land Use Planning and Approvals Act 1993, that I have notified the owner of the intention to make this application. Where the subject property is owned or controlled by Council or the Crown, their signed consent is attached. Where the application is submitted under Section 43A, the owner's consent is attached.
- I declare that the information in this declaration is true and correct.

#### Acknowledgement: •

I acknowledge that the documentation submitted in support of my application will become a public record held by Council and may be reproduced by Council in both electronic and hard copy format in order to facilitate the assessment process; for display purposes during public consultation; and to fulfil its statutory obligations. I further acknowledge that following determination of my application, Council will store documentation relating to my application in electronic format only.

Applicant's Signature:

## **Personal Information Removed**

PLEASE REFER TO THE DEVELOPMENT/USE AND SUBDIVISION CHECKLIST ON THE FOLLOWING PAGES TO DETERMINE WHAT DOCUMENTATION MUST BE SUBMITTED WITH YOUR APPLICATION.

# Clarence City Council



## DEVELOPMENT/USE OR SUBDIVISION CHECKLIST

#### Documentation required:

#### 1. MANDATORY DOCUMENTATION

This information is required for the application to be valid. An application lodged without these items is unable to proceed.
Details of the location of the proposed use or development.
A copy of the current Certificate of Title, Sealed Plan, Plan or Diagram and Schedule of Easements and other restrictions for each parcel of land on which the use or development is proposed.
Full description of the proposed use or development.
Description of the proposed operation.  May include where appropriate: staff/student/customer numbers; operating hours; truck movements; and loading/unloading requirements; waste generation and disposal; equipment used; pollution, including noise, fumes, smoke or vibration and mitigation/management measures.
Declaration the owner has been notified if the applicant is not the owner.
Crown or Council consent (if publically-owned land).
Any reports, plans or other information required by the relevant zone or code.
Fees prescribed by the Council.
Application fees (please phone 03 6217 9550 to determine what fees apply). An invoice will be emailed
upon lodgement.

#### 2. ADDITIONAL DOCUMENTATION

In addition to the mandatory information required above, Council may, to enable it to consider an application, request further information it considers necessary to ensure that the proposed use or development will comply with any relevant standards and purpose statements in the zone, codes or specific area plan, applicable to the use or development.

#### □ Site analysis plan and site plan, including where relevant:

- Existing and proposed use(s) on site.
- Boundaries and dimensions of the site.
- Topography, including contours showing AHD levels and major site features.
- Natural drainage lines, watercourses and wetlands on or adjacent to the site.
- Soil type.
- Vegetation types and distribution, and trees and vegetation to be removed.
- Location and capacity of any existing services or easements on/to the site.
- Existing pedestrian and vehicle access to the site.
- Location of existing and proposed buildings on the site.
- Location of existing adjoining properties, adjacent buildings and their uses.
- Any natural hazards that may affect use or development on the site.
- Proposed roads, driveways, car parking areas and footpaths within the site.
- Any proposed open space, communal space, or facilities on the site.
- Main utility service connection points and easements.
- Proposed subdivision lot boundaries.

# Clarence City Council DEVELOPMENT/USE OR SUBDIVISION CHECKLIST



Where it is proposed to erect buildings, **detailed plan**s with dimensions at a scale of 1:100 or 1:200 showing:


- Internal layout of each building on the site.
- Private open space for each dwelling.
- External storage spaces.
- Car parking space location and layout.
- Major elevations of every building to be erected.
- Shadow diagrams of the proposed buildings and adjacent structures demonstrating the extent of shading of adjacent private open spaces and external windows of buildings on adjacent sites.
- Relationship of the elevations to natural ground level, showing any proposed cut or fill.
- Materials and colours to be used on rooves and external walls.
- ☐ Where it is proposed to erect buildings, a plan of the proposed **landscaping** showing:
  - Planting concepts.
  - Paving materials and drainage treatments and lighting for vehicle areas and footpaths.
  - Plantings proposed for screening from adjacent sites or public places.
- Any additional reports, plans or other information required by the relevant zone or code.

This list is not comprehensive for all possible situations. If you require further information about what may be required as part of your application documentation, please contact Council's Planning Officers on (03) 6217 9550 who will be pleased to assist.



## **RESULT OF SEARCH**

RECORDER OF TITLES

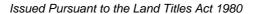



#### SEARCH OF TORRENS TITLE

VOLUME	FOLIO
188404	4
EDITION 2	DATE OF ISSUE 30-Apr-2025

SEARCH DATE : 18-Aug-2025 SEARCH TIME : 09.29 AM

#### DESCRIPTION OF LAND

City of CLARENCE

Lot 4 on Sealed Plan 188404

Derivation: Part of 700 Acres Located to E.S.P. Bedford

Prior CT 15614/22

#### SCHEDULE 1

N248327 TRANSFER to SAM BRETT WILLIAMS and KIRBY ALLANA WILLIAMS Registered 30-Apr-2025 at 12.01 PM

#### SCHEDULE 2

Reservations and conditions in the Crown Grant if any SP188404 EASEMENTS in Schedule of Easements SP188404 FENCING COVENANT in Schedule of Easements SPD 131 FENCING COVENANT in Schedule of Easements

#### UNREGISTERED DEALINGS AND NOTATIONS

No unregistered dealings or other notations




## **FOLIO PLAN**

**RECORDER OF TITLES** 



Issued Pursuant to the Land Titles Act 1980

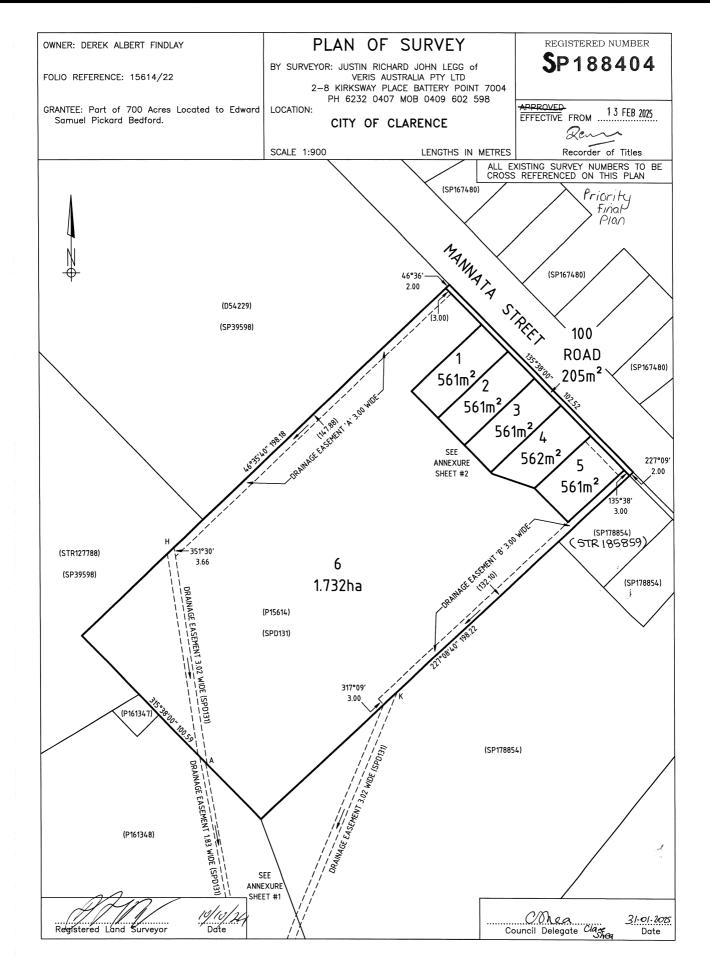

Search Date: 18 Aug 2025

Search Time: 09:29 AM

Volume Number: 188404

Revision Number: 01

Page 1 of 3




## **FOLIO PLAN**

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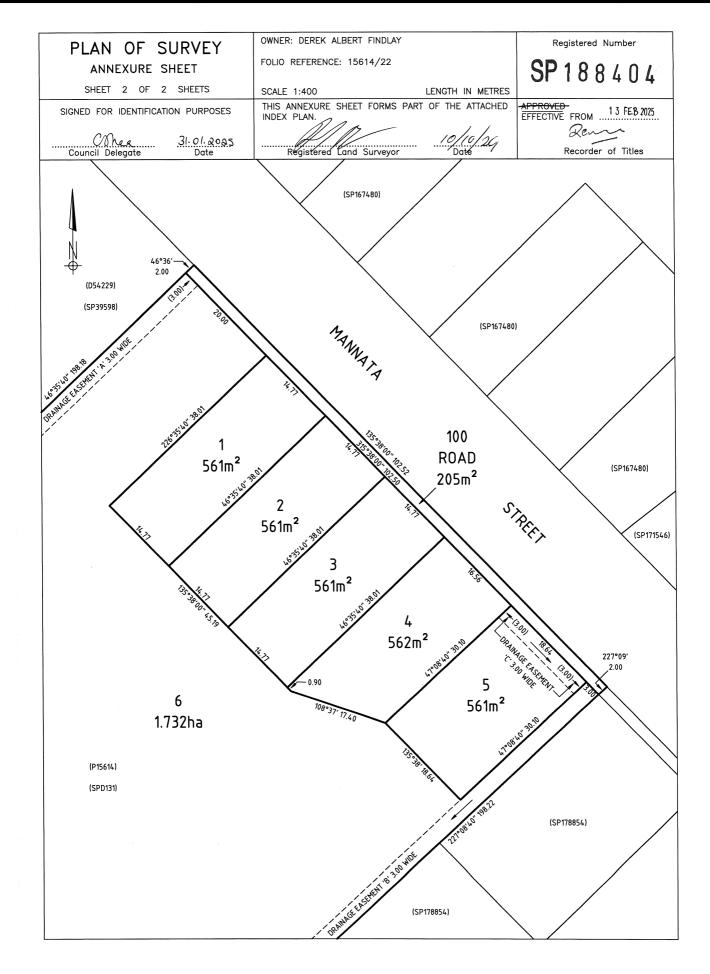


## **FOLIO PLAN**

**RECORDER OF TITLES** 

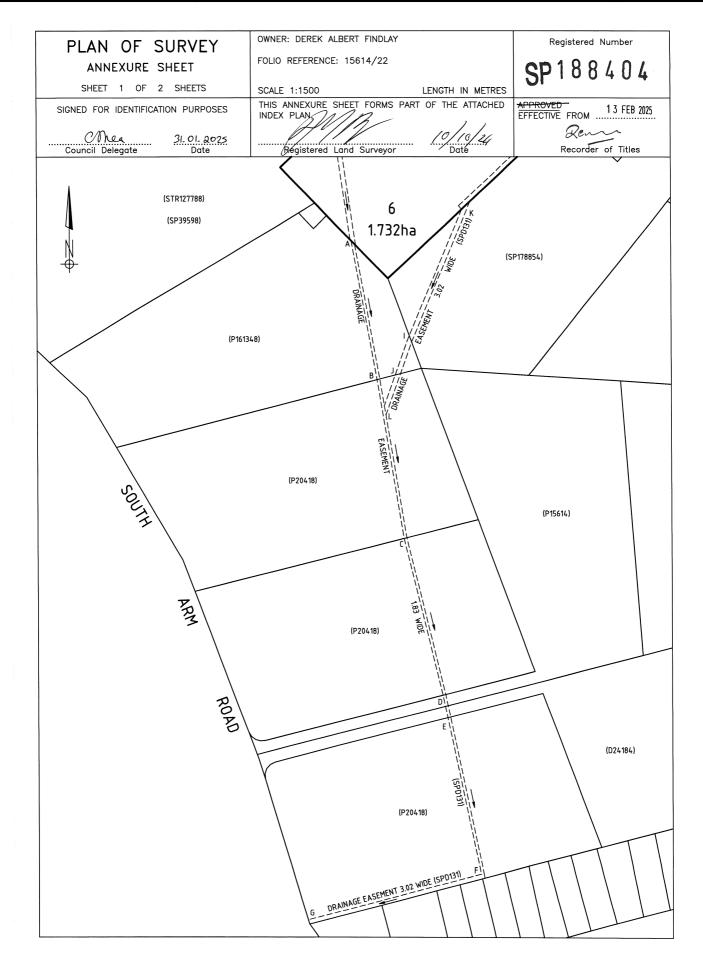

Issued Pursuant to the Land Titles Act 1980





## **SCHEDULE OF EASEMENTS**

RECORDER OF TITLES

Issued Pursuant to the Land Titles Act 1980



#### SCHEDULE OF EASEMENTS

NOTE: THE SCHEDULE MUST BE SIGNED BY THE OWNERS

& MORTGAGEES OF THE LAND AFFECTED.

SIGNATURES MUST BE ATTESTED.

Registered Number

SP188404

PAGE 1 OF 2 PAGES

#### **EASEMENTS AND PROFITS**

Each lot on the plan is together with:-

- (1) such rights of drainage over the drainage easements shown on the plan (if any) as may be necessary to drain the stormwater and other surplus water from such lot; and
- (2) any easements or profits a prendre described hereunder.

Each lot on the plan is subject to:-

- such rights of drainage over the drainage easements shown on the plan (if any) as passing through such lot as may be necessary to drain the stormwater and other surplus water from any other lot on the plan; and
- (2) any easements or profits a prendre described hereunder.

  The direction of the flow of water through the drainage easements shown on the plan is indicated by arrows.

Lot 5 on the Plan is SUBJECT TO a right of drainage in gross in favour of Clarence City Council over the land marked 'DRAINAGE EASEMENT 'C' 3.00 WIDE' on the Plan.

Lot 6 on the Plan is SUBJECT TO a right of drainage (appurtenant to Lots 20 and 21 on S.P.D No. 131) over the land marked 'DRAINAGE EASEMENT 3.02 WIDE (SPD131) H.A.' on the Plan.

Lot 6 on the Plan is SUBJECT TO a right of drainage in gross in favour of The Warden of Councillors and Electors of the Municipality of Clarence over the land marked 'DRAINAGE EASEMENT 3.02 WIDE (SPD131) H.A.' on the Plan.

Lot 6 on the Plan is SUBJECT TO a right of drainage in gross in favour of Clarence City Council over the land marked 'DRAINAGE EASEMENT 'A' 3.00 WIDE' on the Plan.

Lot 6 on the Plan is SUBJECT TO a right of drainage in gross in favour of Clarence City Council over the land marked 'DRAINAGE EASEMENT 'B' 3.00 WIDE' on the Plan.

Lots 1 – 6 (inclusive) and 100 on the Plan are TOGETHER WITH a right of drainage over the land marked 'A.B.C.D.E.F.G.' and 'K.I.J.L.' on Plan no. 15614 DRAINAGE EASEMENT 1.83 WIDE ABCDEF,

DRAINAGE EASEMENT 3.02 WIDE FG & DRAINAGE EASEMENT 3.02 WIDE KIJL on the Plan.

FENCING PROVISION COVENANT

CUT 13/42 CAITUN TOUSSAINT SOUCITOR FOR THE DEVEZOPER

The owner of each Lot on the Plan covenants with Derek Albert Findlay (the Vendor) that the Vendor shall not be required to fence.

(USE ANNEXURE PAGES FOR CONTINUATION)

SUBDIVIDER: DEREK ALBERT FINDLAY

FOLIO REF: C/T 15614/22

SOLICITOR: BUTLER McINTYRE & BUTLER (CKT241968)

PLAN SEALED BY: CLARENCE CITY COUNCIL

DATE: 31st January 2025

PDPUANPMTD - 2021 Concil Delegate See

NOTE: The Council Delegate must sign the Certificate for the purposes of identification.

Search Date: 19 Mar 2025 Search Time: 02:10 PM Volume Number: 188404 Revision Number: 01 Page 1 of 2



## **SCHEDULE OF EASEMENTS**

RECORDER OF TITLES



Issued Pursuant to the Land Titles Act 1980

# ANNEXURE TO SCHEDULE OF EASEMENTS

PAGE 2 OF 2 PAGES

Registered Number

SP 188404

SUBDIVIDER: DEREK ALBERT FINDLAY FOLIO REFERENCE: C/T 15614/22

SIGNED by DEREK ALBERT FINDLAY the registered proprietor of the land contained in Certificate of Title Volume 15614 Folio 22 in the presence of:

DEREK ALBERT FINDLAY

Witness(Signature): ....../١/

(Print Full Name): MICHAEL F

(Full Postal Address): 506 Sewin Arm Rond

LANDARDALL TAS TOOL

**NOTE:** Every annexed page must be signed by the parties to the dealing or where the party is a corporate body be signed by the persons who have attested the affixing of the seal of that body to the dealing.

 $c_{1}$ 

# PINNACLE





Note: The images provided are artistic representations only and should not be used as references for final colours, finishes, or external/internal features.

## 62 Mannata Street, Lauderdale 7021

Owner(s) or Clients

**Building Classification** 

Designer

Total Floor Area (Combined)

Alpine Area

Other Hazards

(e.g.. High wind, earthquake, flooding, landslip, dispersive soils, sand dunes, mine subsidence, landfill, snow & ice, or other relevant factors)

Sam & Kirby Williams

1a

Jason Nickerson CC6073Y

238.62m<sup>2</sup>

Design Wind Speed Deck 20.62m<sup>2</sup>

N/A

Flood Prone Area, Coastal Inundation Area, Airport Obstacle Limitation Area

Title Reference

Zoning

Land Size

Soil Classification

Climate Zone

Corrosion Environment

Bushfire Attack Level (BAL)

188404/4

General Residential

562m<sup>2</sup>

N2

Р

Medium

Low

Changes List				
Issue	Description of change	Date	Designer	
issue	Description of change	Date	Designi	

ID	Sheet Name	Issue
A.01	Site Plan	DA - 01
A.02	Floor Plan	DA - 01
A.03	Elevations	DA - 01
A.04	Elevations	DA - 01
A.05	Roof Plan	DA - 01
A.06	Electrical Plan	DA - 01
A.07	Door & Window Schedule	DA - 01

#### Survey Notes from Surveyor <u>Legend</u> "This plan and associated digital model is prepared for pinnacle drafting from a combination of field survey and existing records for the purpose of designing - Flectrical Connection new constructions on the land and should not be used for any other purpose. Flectrical Turret The title boundaries as shown on this plan were not marked at the time of the survey and have been determined by plan dimensions only and not by field survey. No measurements or offsets are to be derived between the features on this plan and the boundary layer. The relationship between the features in Sewer Connection this model and the boundary layers cannot be used for any set out purposes or to confirm the position of the title boundaries on site. - Stormwater Connection Due to the nature of the title boundary information, if any structures are designed on or near a boundary we would recommend a re-mark survey be - Telstra Connection completed and lodged with the land titles office to support the boundary definition. - Telstra Pit Services shown have been located where visible by field survey. Services denoted as being "per dbyd only" are approximate and for illustrative purposes only. Prior to any demolition, excavation or construction on the site, the relevant authority should be contacted for possible location of further underground - Water Meter services and detailed locations of all services. - Water Stop Valve If subsequent design is intended for construction setout, future surveying setout costs are increased if the digital data provided is rotated, scaled or moved. - Fire Hydrant This note forms an integral part of the plan/data. Any reproduction of this plan/model without this note attached will render the information shown invalid. Surface Water Drainage Ground to fall away from building in all directions in compliance with AS2870 & N.C.C 2022 3.3.3. STORMWATERLINE @ 1:100 TO EXISTING FALL GROUND AWAY FROM STORMWATERCONNECTION, WORKS BY REGISTERED Surface water must be diverted away from a Class HOUSE A MINIMUM OF 50mm PLUMBER 1 building as follows: OVER FIRST 1000mm IN (a)Slab-on-ground - finished ground level adjacent ACCORDANCE WITH AS2870, to a building: the external finished surface NCC 2022 PART 3.3.3 & FIGURE surrounding the slab must be drained to move 3.3.3a 38.01 EXISTING SW MANHOLE 1025Ø surface water away from the building and graded to give a slope of not less than R.L: 2,480 (i)25mm over the first 1m from the building INV: 1,560 (A)in low rainfall intensity areas for surfaces that are reasonably impermeable (such as concrete or 4 claypaving); or 1,803 562m<sup>2</sup> (B)for any reasonably impermeable surface that forms part of an access path or ramp ORG WITH TAP OVER, TOP OF ORG TO BE A MINIMUM provided for the purposes of Clauses 1.1 DECK OF 150mm BELOW LOWEST SANITARY FIXTURE (2) or (4)(c) of the ABCB Standard for Livable Housing Design; or (ii) 50 mm over the first 1 m from the building in MANNA any other case. P2 (b)Slab-on-ground - finished slab heights: the height of the slab-on-ground above external PROPOSED DWELLING finished surfaces mustbe not less than (i)100 mm above the finished ground level in FFI: 3.200 low rainfall intensity areas or sandy, welldrained areas: or \L (ii)50 mm above impermeable (paved or concrete) areas that slope away from the CONCRETE S building in accordance with(a); or DRIVEWAY GARAGE FFL: 2,820 (iii) 150 mm in any other case. 72.10 m<sup>2</sup> (c)The ground beneath suspended floors must be ヹ graded so that the area beneath the building is above the adjacent external finished ground - (HWC) $\Box$ level and surface water is prevented from 2,981 ponding under the building. 30.10 EXTERNAL WALL TO HAVE A Subsoil Drainage MIN FRI OF 60/60/60 WITHIN EXISTING SW MANHOLE 1025Ø is to comply with AS2870, AS3500 & N.C.C 2022 900mm OF THE BOUNDARY IN R.L: 2,320 ACCORDANCE WITH INV: 1,340 PART 9.2.3 OF NCC 2022 VOL II Where a subsoil drainage system is installed to divert subsurface water away from the area beneath a building, the subsoil drain must-(a) be graded with a uniform fall of not less than (b) discharge into an external silt pit or sump (i) the level of discharge from the silt pit or sump into an impervious drainage line not less than 50 mm below the invert level of the inlet; and provision for cleaning and maintenance. <u>Note</u> Site Areas All driveway pits and grate drains to be Class B. Site Area 562 m<sup>2</sup> 259.26m<sup>2</sup> **Building Footprint** Stormwater pits are indicative. Location may vary Total Site Coverage 46.13% depending on site conditions. PINNACLE DRAFTING & DESIGN Date: 03/07/2025 Site Plan Scale: Proposal: New Dwelling 7/3 Abernant Way, Cambridge 7170 Drawn by: JD 1:200 @ A3 PINNACLE 03 6248 4218 Client: Sam & Kirby Williams bdaa Job No: Pinn 023-2025 admin@pinnacledrafting.com.au Pg. No: Address: 62 Mannata Street, Lauderdale 7021 DA - 01 Engineer: TBA Revision: www.pinnacledrafting.com.au A.01 Building Surveyor: TBA Approved by: JD Licence: CC6073Y



Articulation Joint



#### Construction of sanitary

#### compartments 10.4.2 of NCC 2022

The door to a fully enclosed sanitary compartment must -

- open outwards; or
- slide: or
- be readily removable from the outside of the compartment.

unless there is a clear space of at least 1.2 m, measured in accordance with Figure 10.4.2 of NCC 2022 Vol II, between the closet pan within the sanitary compartment and the doorway.

#### Note: Safe Movement & Egress

Openable windows greater than 4m above the surface below are to be fitted with a device to limit opening or a suitable screen so a 125mm sphere cannot pass through. Except for Bedrooms, where the requirement is for heights above 2m. Refer to clauses 11.3.7 and 11.3.8 of NCC 2022 for further information on suitable protective devices.

#### Note: Paved Areas

All paths and patios to fall away from dwelling.

#### Note: Stair Construction

All stairs to be constructed in accordance with NCC Vol II 2022 Part 11.2.2:

Riser: Min 115mm - Max 190mm

Going: Min 240mm - Max 355mm Slope (2R+G): Max 550 - Min 700

For stairways serving non-habitable room used

infrequently, refer to table 11.2.2(b).

Landings to comply with Clause 11.2.5 and be a minimum of 750mm deep measured 500mm from the inside edge of the landing.

Slip resistance of treads, nosings and ramps to comply with Clause 11.2.4.

#### Heights of rooms & other spaces 10.3.1 of NCC 2022

Heights of rooms and other spaces must not be less


(a)in a habitable room excluding a kitchen - 2.4 m; and (b)in a kitchen - 2.1 m; and (c)in a corridor, passageway or the like - 2.1 m; and

(d)in a bathroom, shower room, laundry, sanitary compartment, airlock, pantry, storeroom, garage, car parking area or the like - 2.1 m; and (e)in a room or space with a sloping ceiling or

projections below the ceiling line within- See NCC directly for these items

(f)in a stairway, ramp, landing, or the like - 2.0 m measured vertically above the nosing line of stairway treads or the floor surface of a ramp, landing or the like.

If required onsite, the builder may work within the tolerances of the above as specified within the NCC 2022 Vol II. Builder to contact Pinnacle before undertaking works.

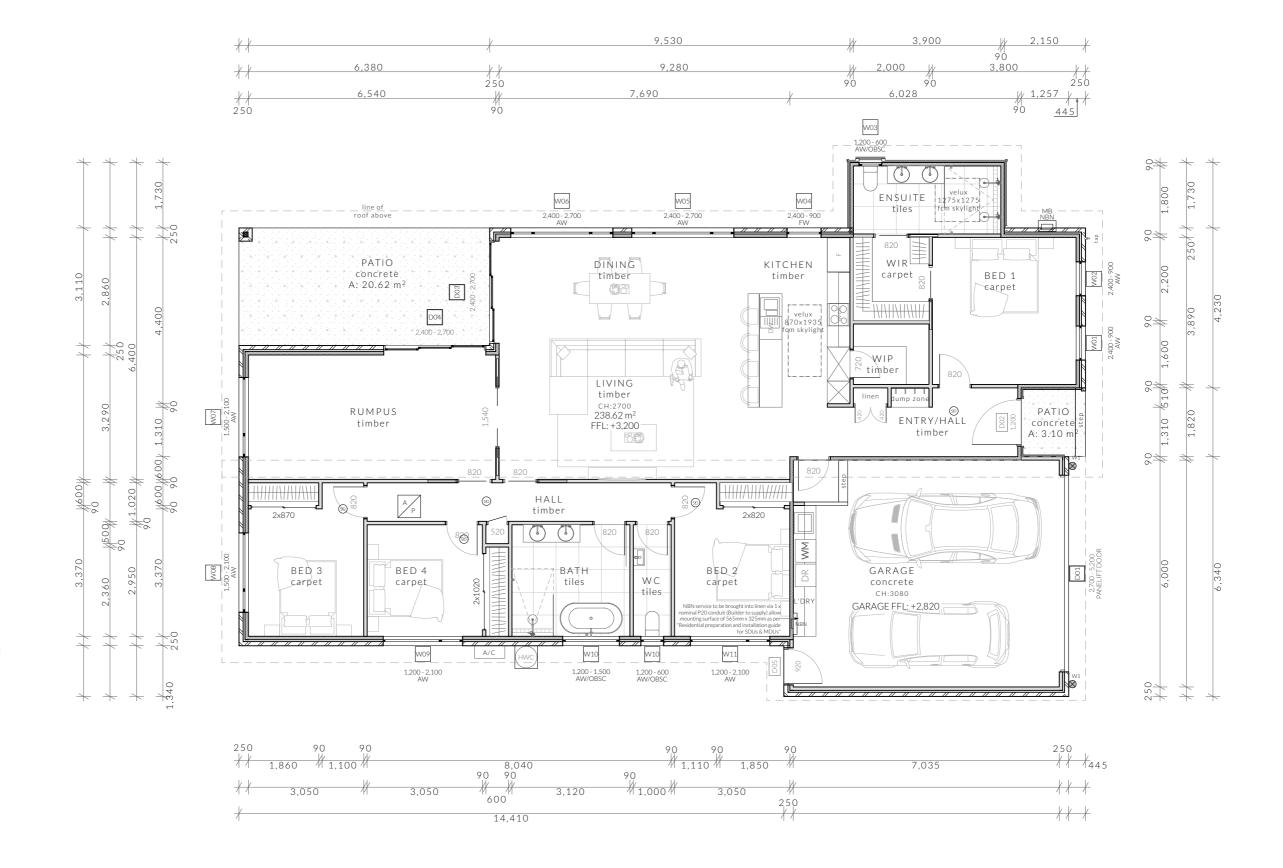

#### **Floor Areas**

Total Floor Area 238.62m<sup>2</sup>

20.62m<sup>2</sup> PINNACLE

PINNACLE DRAFTING & DESIGN 7/3 Abernant Way, Cambridge 7170 03 6248 4218 admin@pinnacledrafting.com.au www.pinnacledrafting.com.au

Licence: CC6073Y

Floor Plan

Approved by:

Revision:

DA - 01

JD

Scale: 1:100 @ A3 Pg. No: A.02


Proposal: New Dwelling Client: Sam & Kirby Williams

Address: 62 Mannata Street, Lauderdale 7021

Drawn by: JD Job No: Pinn 023-2025 Engineer: TBA Building Surveyor: TBA





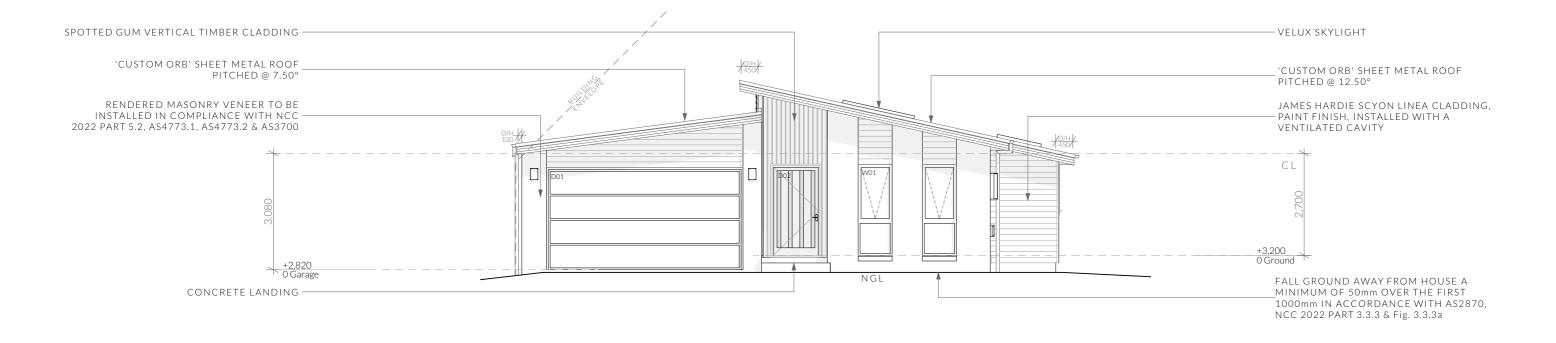

East Elevation 1:100



North Elevation

1:100

Clearances between cladding and ground shall comply with Clause 7.5.7 of the NCC 2022 and shall be a minimum clearance of:

100mm in low rainfall intensity areas or sandy, well-drained areas; or 50mm above impermeable areas that slope away from the building; or 150mm in any other case.

Wall cladding must extend a minimum of 50 mm below the bearer or lowest horizontal part of the suspended floor framing.

U.N.O in builders specifications or located in saline environments or if using a glazed finish brick, brickwork is to be installed in stretcher bond pattern with raked joints.

PINNACLE

Openable windows greater than 4m above ground level are to be fitted with a device to limit the opening or a suitable screen so a 125mm sphere cannot pass through, and withstand a force of 250N. Except for bedrooms, where the requirement is for heights above 2m.

Revision:

All stairs to be constructed in accordance with NCC 2022 Vol II Part 11.2.2 Riser: Min 115mm - Max 190mm Going: Min 240mm - Max 355mm

PINNACLE DRAFTING & DESIGN 7/3 Abernant Way, Cambridge 7170

03 6248 4218 admin@pinnacledrafting.com.au www.pinnacledrafting.com.au Licence: CC6073Y

Approved by:

Slope (2R+G): Max 550 - Min 700 Elevations

DA - 01

JD

1:100 @ A3 Pg. No: A.03

Scale:

Proposal: New Dwelling Client: Sam & Kirby Williams Address: 62 Mannata Street, Lauderdale 7021

Date: 03/07/2025 Drawn by: JD

Job No: Pinn 023-2025 Engineer: TBA Building Surveyor: TBA


commencing any orders, works or requesting producing snop drawings.

ANY AND ALL DISCREPANCIES DISCOVERED BY OUTSIDE PARTIES ARE TO I

BROUGHT TO THE ATTENTION OF PINNACLE DRAFTING & DESIGN PTY LTC


AS SOON AS PRACTICABLE. This document must be printed in colour. Pinnacle

bdaa

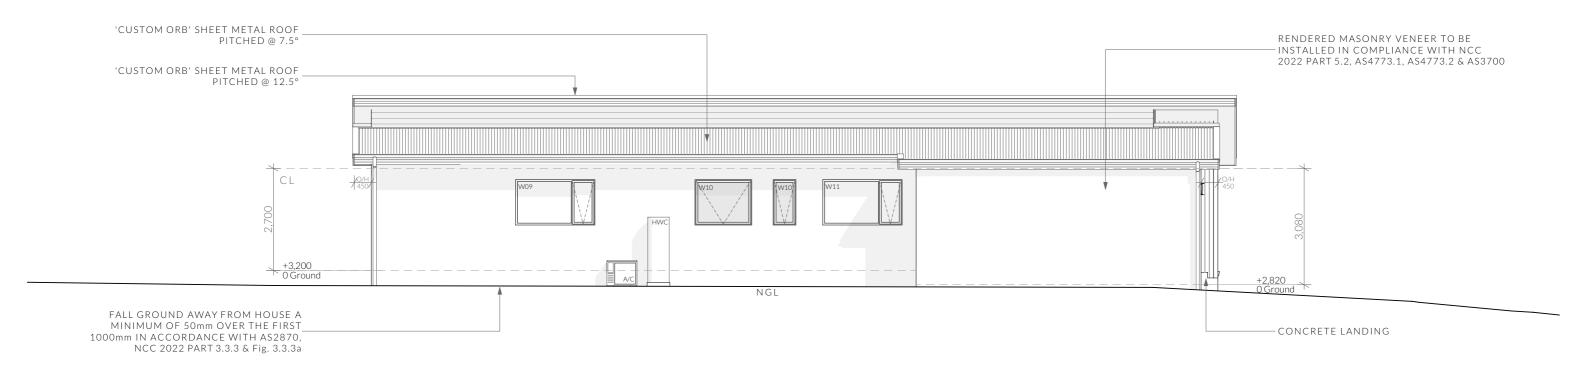

South Elevation

1:100

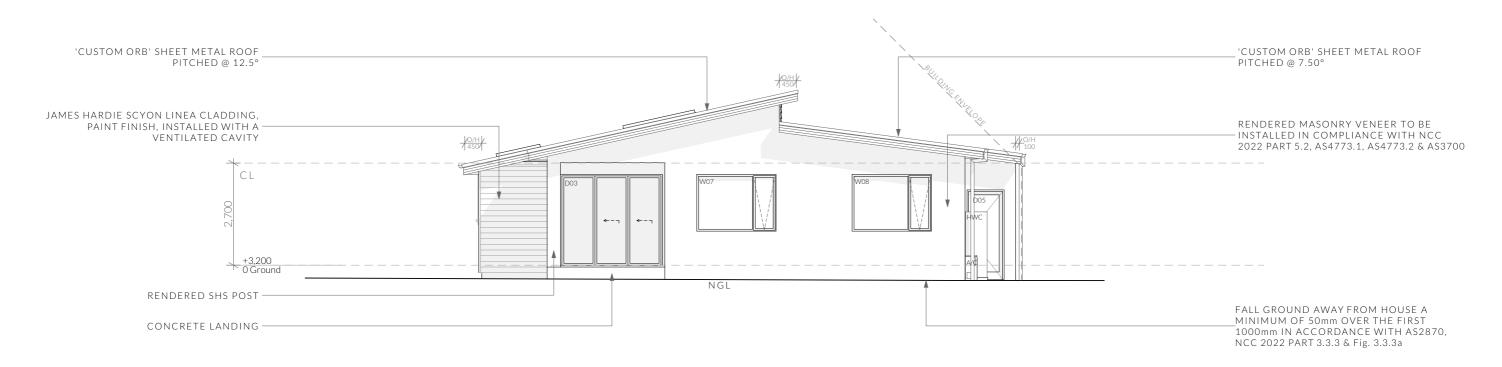

West Elevation

1:100

Clearances between cladding and ground shall comply with Clause 7.5.7 of the NCC 2022 and shall be a minimum clearance of:

100mm in low rainfall intensity areas or sandy, well-drained areas; or 50mm above impermeable areas that slope away from the building; or 150mm in any other case.

Wall cladding must extend a minimum of 50 mm below the bearer or lowest horizontal part of the suspended floor framing.

U.N.O in builders specifications or located in saline environments or if using a glazed finish brick, brickwork is to be installed in stretcher bond pattern with raked joints.

PINNACLE

Openable windows greater than 4m above ground level are to be fitted with a device to limit the opening or a suitable screen so a 125mm sphere cannot pass through, and withstand a force of 250N. Except for bedrooms, where the requirement is for heights above 2m.

All stairs to be constructed in accordance with NCC 2022 Vol II Part 11.2.2 Riser: Min 115mm - Max 190mm

Going: Min 240mm - Max 355mm PINNACLE DRAFTING & DESIGN

7/3 Abernant Way, Cambridge 7170

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Elevations Revision:

Approved by:

DA - 01 JD

Slope (2R+G): Max 550 - Min 700

Scale:

1:100 @ A3 Pg. No: Address: 62 Mannata Street, Lauderdale 7021 A.04

Proposal: New Dwelling Client: Sam & Kirby Williams Drawn by: JD Job No: Pinn 023-2025

Engineer: TBA Building Surveyor: TBA

commencing any orders, works or requesting producing snop drawings.

ANY AND ALL DISCREPANCIES DISCOVERED BY OUTSIDE PARTIES ARE TO I

BROUGHT TO THE ATTENTION OF PINNACLE DRAFTING & DESIGN PTY LTC

AS SOON AS PRACTICABLE. This document must be printed in colour. Pinnacle



# Ventilation of roof spaces NCC 2022 Part 10.8.3

A roof must have a roof space that-

(a)is located-

(i)immediately above the primary insulation layer; or

(ii)immediately above sarking with a vapour permeance of not less than 1.14 µg/N.s, which is immediately above the primary insulation layer; or

(iii)immediately above ceiling insulation; and (b)has a height of not less than 20 mm; and (c)is either-

(i)ventilated to outdoor air through evenly distributed openings in accordance with Table 10.8.3; or

(ii)located immediately underneath the roof tiles of an unsarked tiled roof.

#### **Stormwater Notes**

All gutters, downpipes and rain heads to be designed and installed in compliance with AS3500.3 & NCC 2022 Volume II Part 7.4.

#### **Roofing Cladding**

Roof cladding, flashings, cappings, roof sheeting and fixings are to be installed in accordance with NCC 2022 Volume II Part 7.2 for sheet roofing and Part 7.3 for tiled and shingle roofing.

#### **Eaves & Soffit Linings**

To comply with NCC 2022 Vol II Part 7.5.5 and where provided, external fibre-cement sheets and linings used as eaves and soffit linings must-

(a)comply with AS/NZS 2908.2 or ISO 8336; and (b)be fixed in accordance with Table 7.5.5 and Figure 7.5.5 using-

(i)  $2.8 \times 30$  mm fibre-cement nails; or (ii) No. 8 wafer head screws (for 4.5 mm and 6 mm sheets only); or


(iii) No. 8 self embedding head screws (for 6 mm

Refer to table 7.5.5 for trimmer and fastener spacings.

ROOF PITCH	VENTILATION OF OPENINGS (TABLE 10.8.3)
<10°	25,000 mm2/m provided at each of two opposing ends
>10° AND <15°	25.000 mm2/m provided at the eaves and 5.000 mm2/m at high level

(1)Ventilation openings are specified as a minimum free open area per metre length of the longest horizontal dimension of the roof.

(2)For the purposes of this Table, high level openings are openings provided at the ridge or not more than 900 mm below the ridge or highest point of the roof space, measured vertically.

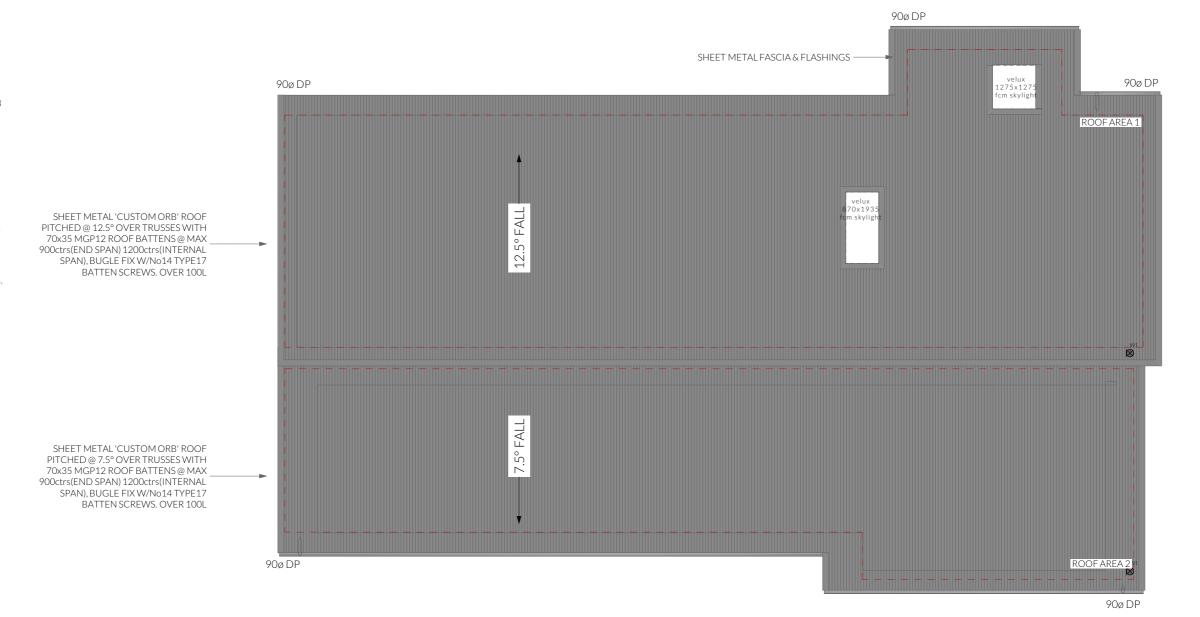

# NOT FOR CONSTRUCTION

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03 6248 4218 admin@pinnacledrafting.com.au www.pinnacledrafting.com.au Licence: CC6073Y Roof Plan

Revision:

Approved by:

DA - 01

JD

Scale: 1:100 @ A3 Pg. No: A.05

Proposal: New Dwelling
Client: Sam & Kirby Williams

Address: 62 Mannata Street, Lauderdale 7021

Date: 03/07/2025

Drawn by: JD

Job No: Pinn 023-2025 Engineer: TBA Building Surveyor: TBA



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#### ELECTRICAL LEGEND - Lower Floor

Symbol	Description	Allowance	Quantity
1,500H ∇ <sup>D</sup>	DATA - CAT 6 (RJ45) - 1 GANG		1
1,500H <b>Џ</b> ™	DATA-TV CONNECTION		3
	FAN - 3 IN 1 (4 LAMP)	10W (LIGHT)	2
0	FAN - CEILING - EXHAUST		4
1,800H	GPO - (1) SINGLE		1
30DH 2	GPO - (2) DOUBLE		32
2 2	GPO - (2) DOUBLE (WITH COOKTOP ISOLATOR SWITCH)		1
300H JW/PROOF	GPO - WEATHER PROOF DOUBLE		1
$\bigotimes_{R}$	LIGHT - CEILING - DOWNLIGHT RECESSED	10W	38
•	LIGHT - CEILING - PENDANT - LED STRIP 2000L	20W (LM)	1
占	SWITCH-LIGHT 1 GANG		9
2 ፟	SWITCH-LIGHT 2 GANG		5
3 🗖	SWITCH-LIGHT 3 GANG		1

#### Note: Lighting

Lighting layout may change, owner to confirm with builder prior to purchase/installation of exact quantity and location of electrical services provided that installation is compliant with AS3000 and artificial lighting allowances do not exceed:

5W/m<sup>2</sup> in class 1a dwellings

4W/m² to veranda, balcony or the like

3W/m<sup>2</sup> in a class 10a dwelling associated with the class 1a dwelling

U.N.O - All downlights are to be Insulation Contact (IC) rated.

#### Preparation for future Solar Installation:

Should the solar design be required for future installation, 2/25mm solarflex (or similar) conduits marked "solar" are to be installed from the meter box to the roof space - See electrical

#### Smoke Alarms Part 9.5 of NCC 2022

Smoke alarms must-(a)be located in-

(i)a Class 1a building in accordance with 9.5.2 and 9.5.4;

(ii)a Class 1b building in accordance with 9.5.3 and 9.5.4; and

(b)comply with AS 3786, except that in a Class 10a private garage where the use of the area is likely to result in smoke alarms causing spurious signals, any other alarm deemed suitable in accordance with AS 1670.1 may be installed provided that smoke alarms complying with AS 3786 are installed elsewhere in the Class 1 building; and

(c)be powered from the consumer mains source where a consumer mains source is supplied to the building; and be interconnected where there is more than one alarm.

In a Class 1a building, smoke alarms must be located in(a)any storey containing bedrooms, every corridor or hallway associated with a bedroom, or if there is no corridor or hallway, in an area between the bedrooms and the remainder of the building; and (b) each other storey not containing bedrooms.

Smoke alarms required by 9.5.2 and 9.5.3 must be installed on or near the ceiling, in accordance with the following:

(a)Where a smoke alarm is located on the ceiling it must

(i)a minimum of 300 mm away from the corner junction of the wall and ceiling; and

(ii)between 500 mm and 1500 mm away from the high point and apexes of the ceiling, if the room has a sloping ceiling.

(b) Where (a) is not possible, the smoke alarm may be installed on the wall, and located a minimum of 300 mm and a maximum of 500 mm off the ceiling at the junction with the wall.

## Note: Exhaust Fans

Exhaust fans to comply with NCC 2022 Vol 2 Part 10.8.2 and have;


-An exhaust system installed in a kitchen, bathroom, sanitary compartment or laundry must have a minimum flow rate of-(a)25 L/s for a bathroom or sanitary compartment; and (b)40 L/s for a kitchen or laundry.

 -Exhaust from a kitchen, kitchen range hood, bathroom, sanitary compartment or laundry must discharge directly or via a shaft or duct to outdoor air.


 -Where a venting clothes dryer is installed, it must discharge directly or via a shaft or duct to outdoor air.

-An exhaust system that is not run continuously and is serving a bathroom or sanitary compartment that is not ventilated in accordance with 10.6.2(a) must-

(a)be interlocked with the room's light switch; and (b)include a run-on timer so that the exhaust system continues to operate for 10 minutes after the light switch is turned off.

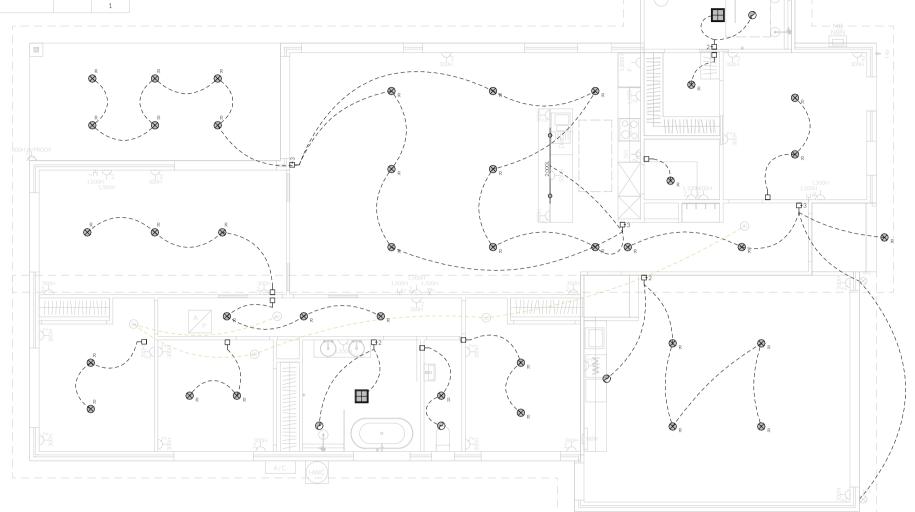

Electrical Plan - Light/Reflected Ceiling

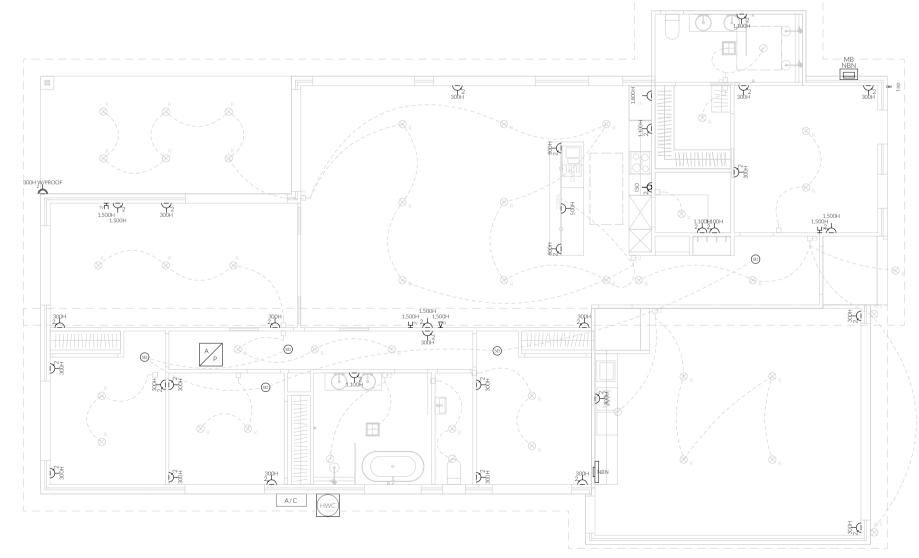

# T Electrical Plans Powers T R II C T I O N

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DA-01

JD

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Electrical Plan Scale: @ A3

Pg. No: A.06 Proposal: New Dwelling

Client: Sam & Kirby Williams
Address: 62 Mannata Street, Lauderdale 7021

Date: 03/07/2025 Drawn by: JD Job No: Pinn 023-2025

Building Surveyor: TBA


Engineer: TBA


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#### **Glazing**

All glazing must comply with Section 8 of NCC Vol II 2022.

Windows must be installed in accordance with the following:

- (a)Structural building loads must not be transferred to the window assembly.
- (b)A minimum 10 mm gap must be provided between the top of the window assembly and any loadbearing framing or masonry wall
- (c)The requirements of (b) may be increased where necessary to allow for frame settlement over wide openings.
- (d)Packing, if provided between each window assembly and the frame, must be-
- (i)located along each side and bottom; and
- (ii)fixed to ensure the sides and bottom of the window assembly remain straight; and
- (iii) clear of any flashing material.

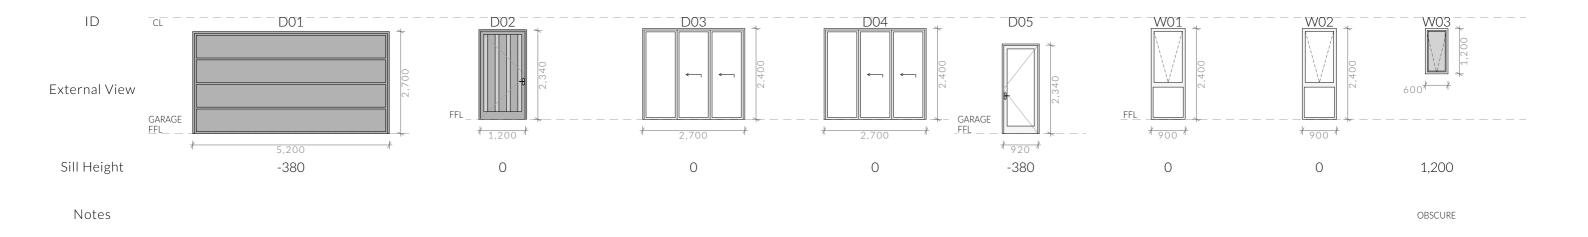If a door, side panel or panel is capable of being mistaken for a doorway or opening, the glass must be marked to make it readily visible with an opaque band not less than 20 mm in height located so that-

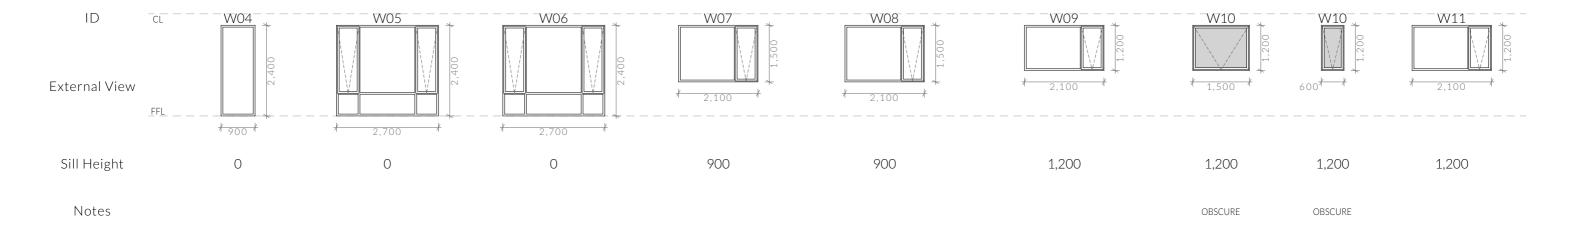(a) the upper edge is not less than 700 mm above the floor; and

Refer to Part 8.4.7 for exemptions.

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Glazing - 52mm Double Glazed (clear)

U-Value

4.1

3.2

U-Value is reduced by 0.1 across all products.

All windows & doors to be glazed with the minimum following values:

Values based on products from Clark Windows. Where Argon Gas is specified the

SHGC

0.57

0.67

**Important Note** 



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(b) the lower edge is not more than 1.2 m above the floor.

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Door & Window Schedule

Revision:

Approved by:

Pg. No: A.07

Scale:

Proposal: New Dwelling Client: Sam & Kirby Williams

Window Type

Awning

Fixed

Address: 62 Mannata Street, Lauderdale 7021

Date: 03/07/2025 Drawn by: JD

Job No: Pinn 023-2025 Engineer: TBA Building Surveyor: TBA

- Glazing to be Reduced- or low-reflectivity glass (0–10% reflectivity)

Section 4.2.3 Bird-friendly applications: micro scale of the Minimizing

• installing internal screens as close to the glass as possible so as to

• attaching external screens to operable windows; (applicable in

• attaching exterior decorative grilles, provided the sections are less

wherever possible. Alternative options are set out in

maximise the noise projected through the window

reduced or low-reflectivity glass option.

than 28 cm wide (10 cm/handprint width

Some of these examples are:

bushfire prone areas)

being optimal)

the Swift Parrot Collision Threat where unable to meet the