

DEVELOPMENT APPLICATION PDPLANPMTD-2025/054515

PROPOSAL: Three Multiple Dwellings

LOCATION: 116 Dolina Drive, Rokeby

RELEVANT PLANNING SCHEME: Tasmanian Planning Scheme - Clarence

ADVERTISING EXPIRY DATE: 06 November 2025

The relevant plans and documents can be inspected at the Council offices, 38 Bligh Street, Rosny Park, during normal office hours until 06 November 2025. In addition to legislative requirements, plans and documents can also be viewed at www.ccc.tas.gov.au during these times.

Any person may make representations about the application to the Chief Executive Officer, by writing to PO Box 96, Rosny Park, 7018 or by electronic mail to clarence@ccc.tas.gov.au. Representations must be received by Council on or before 06 November 2025.

To enable Council to contact you if necessary, would you please also include a day time contact number in any correspondence you may forward.

Any personal information submitted is covered by Council's privacy policy, available at www.ccc.tas.gov.au or at the Council offices.

Clarence City Council



APPLICATION FOR DEVELOPMENT / USE OR SUBDIVISION

The personal information on this form is required by Council for the development of land under the Land Use Planning and Approvals Act 1993. We will only use your personal information for this and other related purposes. If this information is not provided, we may not be able to deal with this matter. You may access and/or amend your personal information at any time. How we use this information is explained in our **Privacy Policy**, which is available at www.ccc.tas.gov.au or at Council offices.

| Proposal: | Multiple dwellings |
|--|---|
| Location: | Address 116 Dolina Drive Suburb/Town Rokeby Postcode 7019 |
| Current Owners/s: Applicant: | Personal Information Removed |
| Tax Invoice for application fees to be in the name of: (if different from applicant) | Is the property on the Tasmanian Heritage Register? Yes No |
| | (if yes, we recommend you discuss your proposal with Heritage Tasmania prior to lodgement as exemptions may apply which may save you time on your proposal) |

38 Bligh Street, Rosny Park, Tasmania • Address correspondence to: General Manager, PO Box 96, Rosny Park 7018 • Dx: 70402 Telephone (03) 6217 9550 • Email cityplanning@ccc.tas.gov.au • Website www.ccc.tas.gov.au

| If you had pre-applica Officer, please give the | ation discussions with a Council heir name | | | |
|--|---|-----|----|---|
| Current Use of Site: | Vacant land | | | |
| Does the proposal in | volve land administered or owned | Yes | No | × |

Declaration:

- I have read the Certificate of Title and Schedule of Easements for the land and am satisfied that this application is not prevented by any restrictions, easements or covenants.
- I authorise the provision of a copy of any documents relating to this application to any person for the purposes of assessment or public consultation. I agree to arrange for the permission of the copyright owner of any part of this application to be obtained. I have arranged permission for Council's representatives to enter the land to assess this application
- I declare that, in accordance with Section 52 of the Land Use Planning and Approvals Act 1993, that I have notified the owner of the intention to make this application. Where the subject property is owned or controlled by Council or the Crown, their signed consent is attached. Where the application is submitted under Section 43A, the owner's consent is attached.
- I declare that the information in this declaration is true and correct.

Acknowledgement: •

I acknowledge that the documentation submitted in support of my application will become a public record held by Council and may be reproduced by Council in both electronic and hard copy format in order to facilitate the assessment process; for display purposes during public consultation; and to fulfil its statutory obligations. I further acknowledge that following determination of my application, Council will store documentation relating to my application in electronic format only.

Applicant's Signature:

Personal Information Removed

PLEASE REFER TO THE DEVELOPMENT/USE AND SUBDIVISION CHECKLIST ON THE FOLLOWING PAGES TO DETERMINE WHAT DOCUMENTATION MUST BE SUBMITTED WITH YOUR APPLICATION.

Clarence City Council



DEVELOPMENT/USE OR SUBDIVISION CHECKLIST

Documentation required:

1. MANDATORY DOCUMENTATION This information is required for the application to be valid. An application lodged without these items is unable to proceed. Details of the location of the proposed use or development. A copy of the current Certificate of Title, Sealed Plan, Plan or Diagram and Schedule of Easements and other restrictions for each parcel of land on which the use or development is proposed. Full description of the proposed use or development. Description of the proposed operation. May include where appropriate: staff/student/customer numbers; operating hours; truck movements; and loading/unloading requirements: waste generation and disposal; equipment used; pollution, including noise, fumes, smoke or vibration and mitigation/management measures. Declaration the owner has been notified if the applicant is not the owner. Crown or Council consent (if publically-owned land). Any reports, plans or other information required by the relevant zone or code. Fees prescribed by the Council.

2. ADDITIONAL DOCUMENTATION

upon lodgement.

In addition to the mandatory information required above, Council may, to enable it to consider an application, request further information it considers necessary to ensure that the proposed use or development will comply with any relevant standards and purpose statements in the zone, codes or specific area plan, applicable to the use or development.

Application fees (please phone 03 6217 9550 to determine what fees apply). An invoice will be emailed

Site analysis plan and site plan, including where relevant:

- Existing and proposed use(s) on site.
- Boundaries and dimensions of the site.
- Topography, including contours showing AHD levels and major site features.
- Natural drainage lines, watercourses and wetlands on or adjacent to the site.
- Soil type.
- Vegetation types and distribution, and trees and vegetation to be removed.
- Location and capacity of any existing services or easements on/to the site.
- Existing pedestrian and vehicle access to the site.
- Location of existing and proposed buildings on the site.
- Location of existing adjoining properties, adjacent buildings and their uses.
- Any natural hazards that may affect use or development on the site.
- Proposed roads, driveways, car parking areas and footpaths within the site.
- Any proposed open space, communal space, or facilities on the site.
- Main utility service connection points and easements.
- Proposed subdivision lot boundaries.

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Clarence City Council DEVELOPMENT/USE OR SUBDIVISION CHECKLIST



| Where it is proposed to erect buildings, | detailed plans with | dimensions at | a scale of | 1:100 or |
|--|---------------------|---------------|------------|----------|
| 1:200 showing: | | | | |

- Internal layout of each building on the site.
- Private open space for each dwelling.
- External storage spaces.
- Car parking space location and layout.
- Major elevations of every building to be erected.
- Shadow diagrams of the proposed buildings and adjacent structures demonstrating the extent of shading of adjacent private open spaces and external windows of buildings on adjacent sites.
- Relationship of the elevations to natural ground level, showing any proposed cut or fill.
- Materials and colours to be used on rooves and external walls.
- ☐ Where it is proposed to erect buildings, a plan of the proposed **landscaping** showing:
 - Planting concepts.
 - Paving materials and drainage treatments and lighting for vehicle areas and footpaths.
 - Plantings proposed for screening from adjacent sites or public places.
- Any additional reports, plans or other information required by the relevant zone or code.

This list is not comprehensive for all possible situations. If you require further information about what may be required as part of your application documentation, please contact Council's Planning Officers on (03) 6217 9550 who will be pleased to assist.



RESULT OF SEARCH

RECORDER OF TITLES



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SEARCH OF TORRENS TITLE

| VOLUME | FOLIO |
|---------|---------------|
| 188393 | 162 |
| EDITION | DATE OF ISSUE |
| 1 | 24-Apr-2025 |

SEARCH DATE : 19-Jun-2025 SEARCH TIME : 10.03 AM

DESCRIPTION OF LAND

City of CLARENCE

Lot 162 on Sealed Plan 188393

Derivation: Part of Lot 37617, 56.81ha Gtd. to The

Director-General of Housing & Construction

Prior CT 186365/507

SCHEDULE 1

M535627 TRANSFER to DAESUNGTAS PTY LTD Registered 03-Nov-2015 at noon

SCHEDULE 2

Reservations and conditions in the Crown Grant if any

SP188393 EASEMENTS in Schedule of Easements

SP188393 COVENANTS in Schedule of Easements

SP188393 FENCING PROVISION in Schedule of Easements

SP142549 & SP184319 COVENANTS in Schedule of Easements

SP184319 FENCING PROVISION in Schedule of Easements

SP142549 FENCING COVENANT in Schedule of Easements

SP142549 WATER SUPPLY RESTRICTION

SP142549 SEWERAGE AND/OR DRAINAGE RESTRICTION

N111707 MORTGAGE to Butler McIntyre Investments Ltd

Registered 06-Apr-2023 at 12.05 PM

UNREGISTERED DEALINGS AND NOTATIONS


No unregistered dealings or other notations



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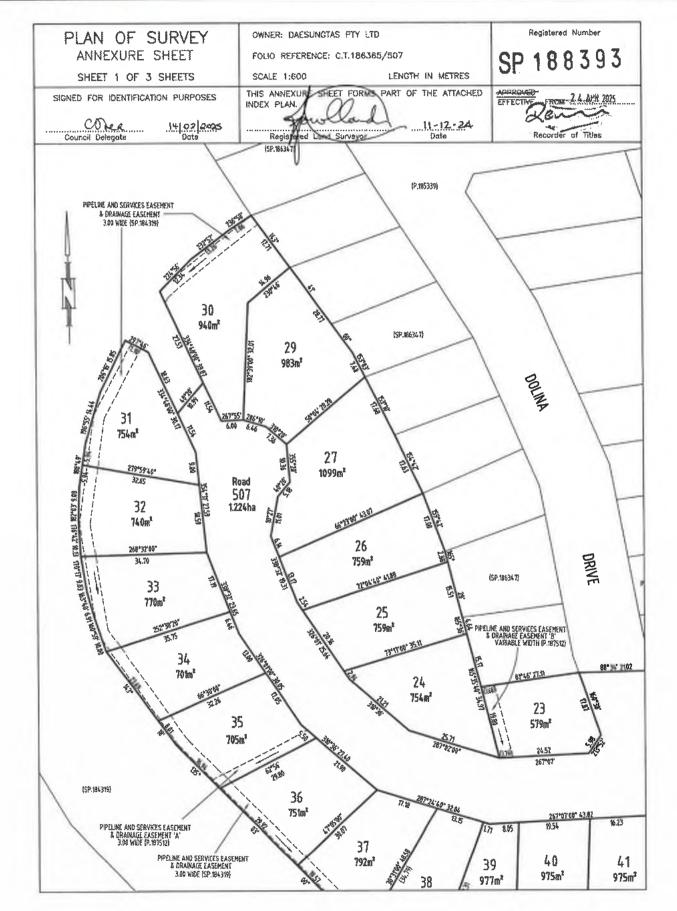
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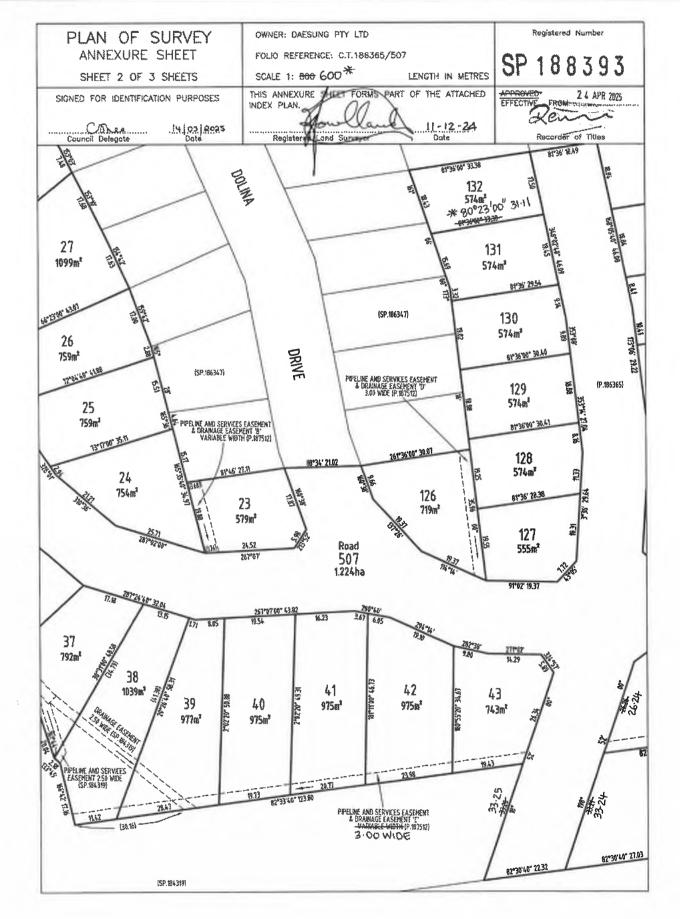




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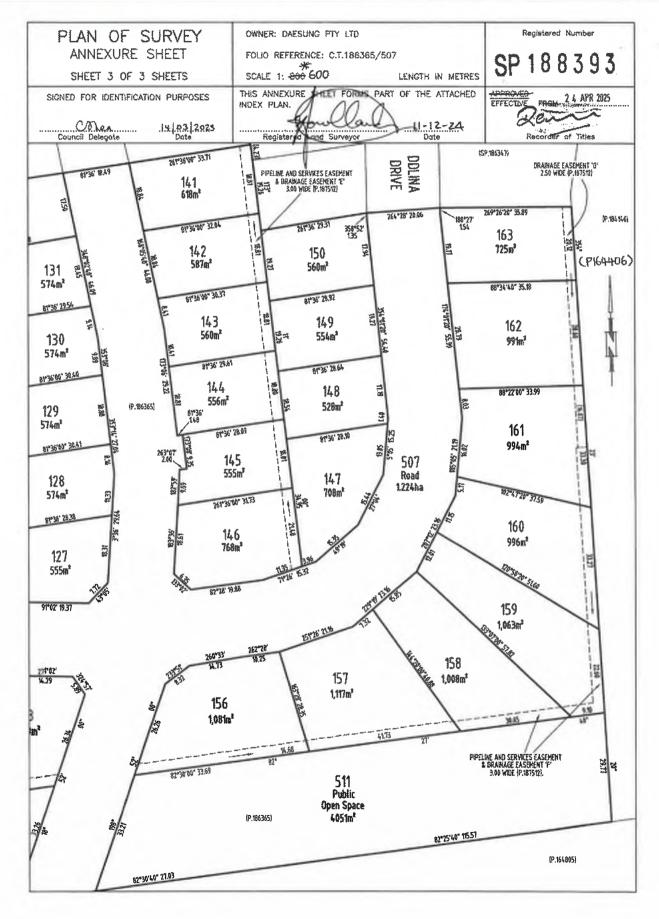


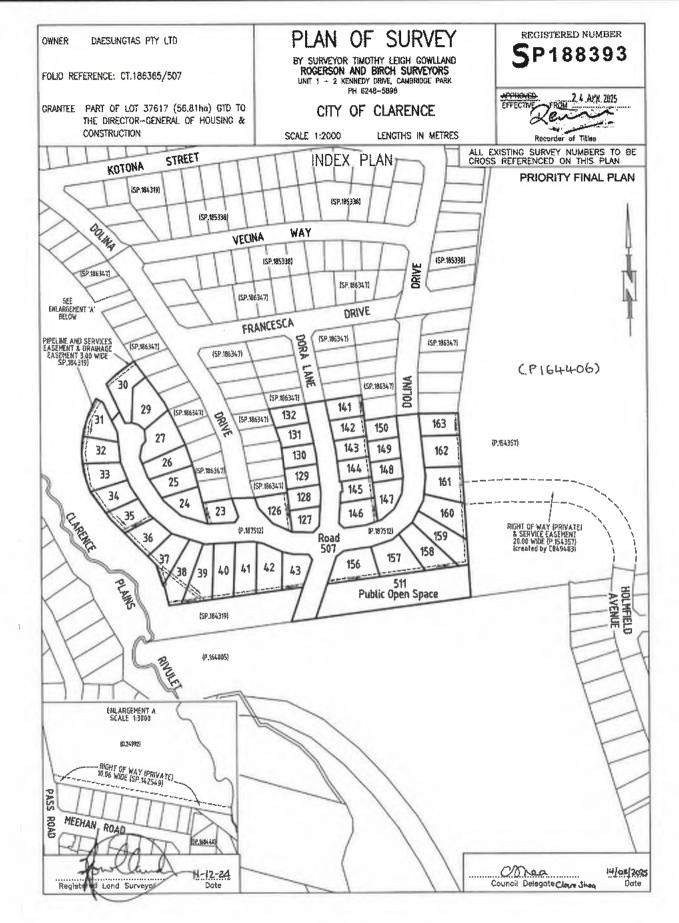

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RECORDER OF TITLES





SCHEDULE OF EASEMENTS

NOTE: THE SCHEDULE MUST BE SIGNED BY THE OWNERS &

MORTGAGEES OF THE LAND AFFECTED.
SIGNATURES MUST BE ATTESTED.

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EASEMENTS AND PROFITS

Each lot on the plan is together with:

- such rights of drainage over the drainage easements shown on the plan (if any) as may be necessary to drain the stormwater and other surplus water from such lot; and
- any casements or profits a prendre described hereunder.

Each lot on the plan is subject to:

- such rights of drainage over the drainage easements shown on the plan (if any) as passing through such lot as may be necessary to drain the stormwater and other surplus water from any other lot on the plan; and
- (2) any easements or profits a prendre described hereunder.

The direction of the flow of water through the drainage easements shown on the plan is indicated by arrows.

EASEMENTS

Lots 30 to 37 (inclusive) on the Plan ("the Lots") are subject to a PIPELINE AND SERVICES EASEMENT (as defined herein) in gross in favour of TasWater over the land marked PIPELINE AND SERVICES EASEMENT & DRAINAGE EASEMENT 3.00 WIDE (SP.184319) shown on the Plan ("the Easement Land").

Lots 30 to 37 (inclusive) on the Plan are subject to a Drainage Easement (as defined herein) in gross in favour of the Clarence City Council over the land marked PIPELINE AND SERVICES EASEMENT & DRAINAGE EASEMENT 3.00 WIDE (SP.184319) on the Plan.

Lot 35 on the Plan ("the Lot") is subject to a PIPELINE AND SERVICES EASEMENT (as defined herein) in gross in favour of TasWater over the land marked PIPELINE AND SERVICES EASEMENT & DRAINAGE EASEMENT 'A' 3.00 WIDE (P.187512) shown on the Plan ("the Easement Land").

Lot 35 on the Plan is subject to a Drainage Easement (as defined herein) in gross in favour of the Clarence City Council over the land marked PIPELINE AND SERVICES EASEMENT & DRAINAGE EASEMENT 'A' 3,00 WIDE (P.187512) on the Plan.

Director

Director/Secretary

(USE ANNEXURE PAGES FOR CONTINUATION)

SUBDIVIDER: DAESUNGTAS PTY LTD FOLIO REF: 186365/507

SOLICITOR

& REFERENCE: Page Seager (DAS 221111)

PLAN SEALED BY: Clarence City Council

DATE: 14th March 2005

REF NO. SD-2016/31

Clare Shee

NOTE: The Council Delegate must sign the Certificate for the purposes of identification.

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Lot 23 on the Plan ("the Lot") is subject to a PIPELINE AND SERVICES EASEMENT (as defined herein) in gross in favour of TasWater over the land marked PIPELINE AND SERVICES EASEMENT & DRAINAGE EASEMENT 'B' VARIABLE WIDTH (P.187512) show on the Plan ("the Easement Land").

Lot 23 on the Plan is subject to a Drainage Easement (as defined herein) in gross in favour of the Clarence City Council over the land marked PIPELINE AND SERVICES EASEMENT & DRAINAGE EASEMENT 'B' VARIABLE WIDTH (P.187512) on the Plan.

Lots 38 to 43 (inclusive) on the Plan ("the Lots") are subject to a PIPELINE AND SERVICES EASEMENT (as defined herein) in gross in favour of TasWater over the land marked PIPELINE AND SERVICES EASEMENT & DRAINAGE EASEMENT 'C' VARIABLE WIDTH P.187512) shown on the Plan 3.00 WIDE ("the Easement Land").

Lots 38 to 43 (inclusive) on the Plan are subject to a Drainage Easement (as defined herein) in gross in favour of the Clarence City Council over the land marked PIPELINE ANL SERVICES EASEMENT & DRAINAGE EASEMENT 'C' WARIABLE WIDTH (P.187512) on the P.an. 3.00 WIDE

Lot 126 on the Plan ("the Lot") is subject to a PIPELINE AND SERVICES EASEMENT (as defined herein) in gross in favour of TasWater over the land marked PIPELINE AND SERVICES EASEMENT & DRAINAGE EASEMENT 'D' 3.00 WIDE (P.187512) shown on the Plan ("the Easement Land").

Lot 126 on the Plan is subject to a Drainage Easement (as defined herein) in gross in favour of the Clarence City Council over the land marked PIPELINE AND SERVICES EASEMENT & DRAINAGE EASEMENT 'D' 3.00 WIDE (P.187512) on the Plan.

Director

Director/Segretary

NOTE: Every annexed page must be signed by the parties to the dealing ... where the party is a corporate body be signed by the persons who have attested the affixing of the seal of that body to the dealing.

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Department of Natural Resources and Environment Tasmania Document Set ID: 5651415 Version: 1, Version Date: 04/08/2025

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Lots 141 to 146 (inclusive) on the Plan ("the Lots") are subject to a PIPELINE AND SERVICES EASEMENT (as defined herein) in gross in favour of TasWater over the and marked PIPELINE AND SERVICES EASEMENT & DRAINAGE EASEMENT 'E' 3.00 WIDE (P.187512) shown on the Plan ("the Easement Land").

Lots 141 to 146 (inclusive) on the Plan are subject to a Drainage Easemen. (as defined herein) in gross in favour of the Clarence City Council over the land marked PIPELINE AND SERVICES EASEMENT & DRAINAGE EASEMENT 'E' 3.00 WIDE (P.187512) on the Plan.

Lots 156 to 161 (inclusive) on the Plan ("the Lots") are subject to a PIPELINE AND SERVICES EASEMENT (as defined herein) in gross in favour of TasWater over the land marked PIPELINE AND SERVICES EASEMENT & DRAINAGE EASEMENT 'F' 3.00 WIDE (P.187512) shown on the Plan ("the Easement Land").

Lots 156 to 161 (inclusive) on the Plan are subject to a Drainage Easement (as defined herein) in gross in favour of the Clarence City Council over the land marked PIPELINE AND SERVICES EASEMENT & DRAINAGE EASEMENT 'F' 3.00 WIDE (P.187512) on the Plan.

Lots 161 to 163 (inclusive) on the Plan are subject to a Drainage Easement (as defined herein) in gross in favour of the Clarence City Council over the land marked DRAINAGE EASEMENT 'G' 2.50 WIDE (P.187512) on the Plan.

Lots 37 and 38 on the Plan ("the Lots") are subject to a PIPELINE AND SERVICES EASEMENT (as defined herein) in gross in favour of TasWater over the land marked PIPELINE AND SERVICES EASEMENT 2.50 WIDE (SP.184319) shown on the Plan ("the Easement Land").

Lots 37, 38 and 39 on the Plan are subject to a Drainage Easement (as defined herein) in gross in favour of the Clarence City Council over the land marked **DRAINAGE EASEMENT 2.50 WIDE (SP.184319)** on the Plan.

Director

Director/Secretary

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Each lot on the Plan is together with a right of way created by and fully described in the Schedule of Easements to SP 142549 over the land marked RIGHT OF WAY (PRIVADE) 10,06 WIDE (SP.142549) on the Plan.

Each lot on the Plan is together with a right of carriageway and service easement created by and fully described in C849483 over the land marked RIGHT OF WAY (PRIVATE) & SERVICE EASEMENT 20.00 WIDE (P.154357) (created by C849483) on the Plan.

COVENANTS

The owner of each Lot on the Plan covenants with the Vendor (Daesung as Pty Ltd) and the Owner or Owners for the time being of every other Lot shown on the Plan to the ment that the burden of these covenants may run with and bind the covenantor's Lot and every part thereof and that the benefit thereof shall be annexed to and devolve with each and every part of every other Le: shown on the plan to observe the following stipulations:

- Not to subdivide that Lot at any time without the prior consent in writing of the Corporation. 1.
- Not to erect on that Lot more than a single residence, which may include an ancillary apartment together with usual outbuildings as may be permitted by the Corporation, without the consent of the Corporation.
- Not to use the land for any purpose except as a residence or the for the purpose of house occupation without the prior consent of the Corporation in writing.
- Not to use any engine or machinery in any trade of business, nor erect or use or permit to be used on 4. any part of any lot shown on the Plan nor to conduct or permit to be conducted any trade or business on or from any part of the same, including but not limited to mining, quarrying, or market gardening. The leasing of the property for private residential purposes is not seemed to be a breach of this covenant.
- Not to keep any animals other than domestic pets on any lot shown on the Plan and not to make any 5. application for a kennel licence in respect of any lot shown on the Plan nor to keep or establish or

Director

Director/Secretary

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> permit to be kept or established any licensed kennel upon any lot or any part of any lot shown on the Plan nor to keep at one time more than two adult canines on any lot shown on the Plan.

The Vendor may, at the Vendor's absolute discretion, waive the burden of any covenant contained in this Schedule of Easements in favour of any lot by notice in writing to the registered proprietor of that OI.

FENCING PROVISION

In respect of the Lots shown on the Plan, the Vendor (Daesungtas Pty Ltd) shall not be required to fence.

DEFINITIONS

"Corporation" means the Warden Councillors and Electors of the City of Carence.

"Drainage Easement" means a right of drainage (including the right of construction of drains) for Clarence City Council with which the right shall be capable of enjoyment for the purpose of carrying away stormwater and other surplus water from any land over or under the land herein indicated as the land over which the right is to subsist, and through all sewers and drains which may hereafter be made or passing under, through, and along the last-mentioned land and the right for Clarence City Council and its employees, agents and contractors from time to time and at all times hereafter if it or they should think fit to enter into and upon the last-mentioned land and to inspect, repair, cleanse, and amend any such sewer or drain without doing unnecessary damage to the said land.

"Pipeline and Services Easement" is defined as follows:-

FIRSTLY, THE FULL AND FREE RIGHT AND LIBERTY for TasWater and its employees, contractors, agents and all other persons duly authorised by it, at all times to

Director

Director/Secretary

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- enter and remain upon the Easement Land with or without nunchinery, vehicles, plant and (1) equipment;
- investigate, take soil, rock and other samples, survey, open and breast up and excavate the Easement (2) Land for any purpose or activity that TasWater is authorised to do or undertake;
- install, retain, operate, modify, relocate, maintain, inspect, cleanse, repair, remove and replace the (3) Infrastructure;
- run and pass sewage, water and electricity through and along the Infr-structure; (4)
- do all works reasonably required in connection with such activities or as may be authorised or (5) required by any law:
 - without doing unnecessary damage to the Easement Land; and
 - leaving the Easement Land in a clean and tidy condition; (b)
- if the Easement Land is not directly accessible from a highway, then for the purpose of undertaking (6) any of the preceding activities TasWater may with or without employees, contractors, agents and any other persons authorised by it, and with or without machinery vehicles, plant and equipment enter the Lot from the highway at any vehicle entry and cross the Lot to the Easement Land; and
- use the Easement Land as a right of carriageway for the purpose of undertaking any of the preceding (7)purposes on other land, TasWater reinstating any damage that it causes in doing so to any boundary fence of the Lot.

SECONDLY, the benefit of a covenant in gross for TasWater with the registered proprietor/s of the Easement Land and their successors and assigns not to erect any building, or place any structures, objects, vegetation, or remove any thing that supports, protects or covers any Infra unicture on or in the Easement Land, without the prior written consent of TasWater to the intent that the harden of the covenant may run with and bind the servient land and every part thereof and that the benefit thereof may be annexed to the easement herein described.

Interpretation:

Director

Director/Secretary

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"Infrastructure" means infrastructure owned or for which TasWater is responsible and includes but is not limited to:

- (a) sewer pipes and water pipes and associated valves;
- (b) telemetry and monitoring devices;
- (c) inspection and access pits;
- (d) electricity assets and other conducting media (excluding telemetry and monitoring devices);
- (e) markers or signs indicating the location of the Easement Land or any other Infrastructure or any warnings or restrictions with respect to the Easement Land or any other infrastructure;
- anything reasonably required to support, protect or cover any other infrastructure;
- (g) any other infrastructure whether of a similar nature or not to the preceding which is reasonably required for the piping of sewage or water, or the running of electric ty, through the Easement Land or monitoring or managing that activity; and
- (h) where the context permits, any part of the Infrastructure.

"TasWater" means Tasmanian Water & Sewerage Corporation Pty Ltd (ACN 162 220 653), its successors and assigns.

Director

yn Ja

Director/Secretary

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| EXECUTED by DAESUNGTAS PTV LTD (ACN 607 |) |
|--|---|
| 472 131) as registered proprietor of the land comprised in |) |
| Folio of the Register Volume 186365/507 Folio 507 in |) |
| accordance with section 127 of the Corporations Act 2001 |) |
| |) |
| (Cth) by: | , |
| | |
| Director Signature | |
| 0 | |
| You's Jung | |
| Director Full Name (print) | |
| Successive Characteristics | |
| ~ | |
| *Director/*Secretary Signature | |
| | |
| DONG KEYD YOOD *BS | |
| *Director/Secretary Full Name (print) | |
| | |
| (*please strike out inapplicable) | |
| | |
| *Bailce Saward | |
| Representative for Transferor | |
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Director/Segretary

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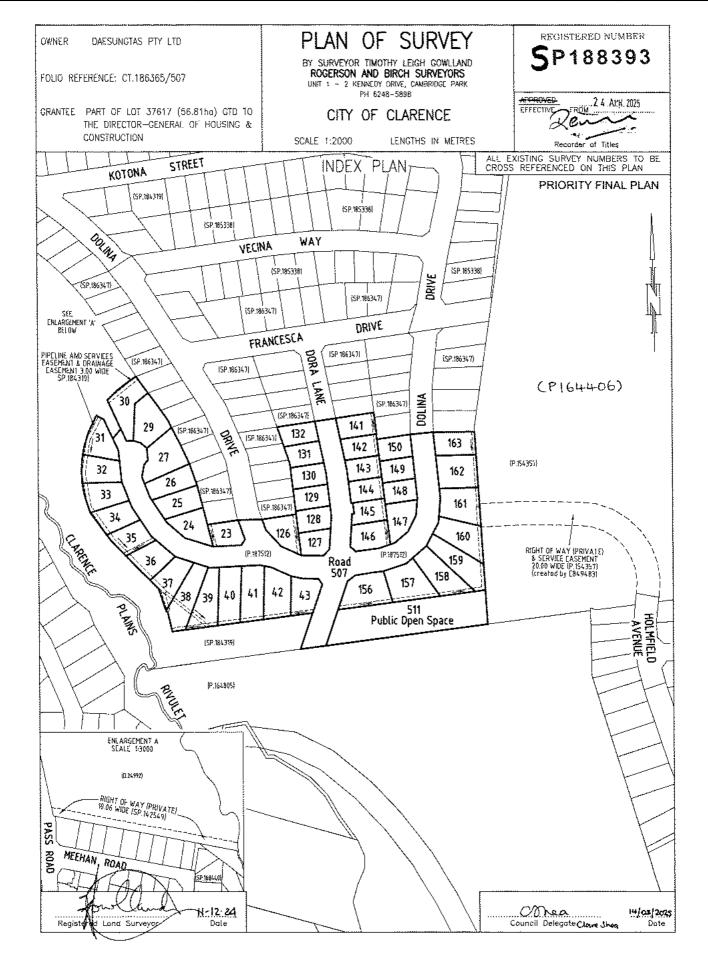
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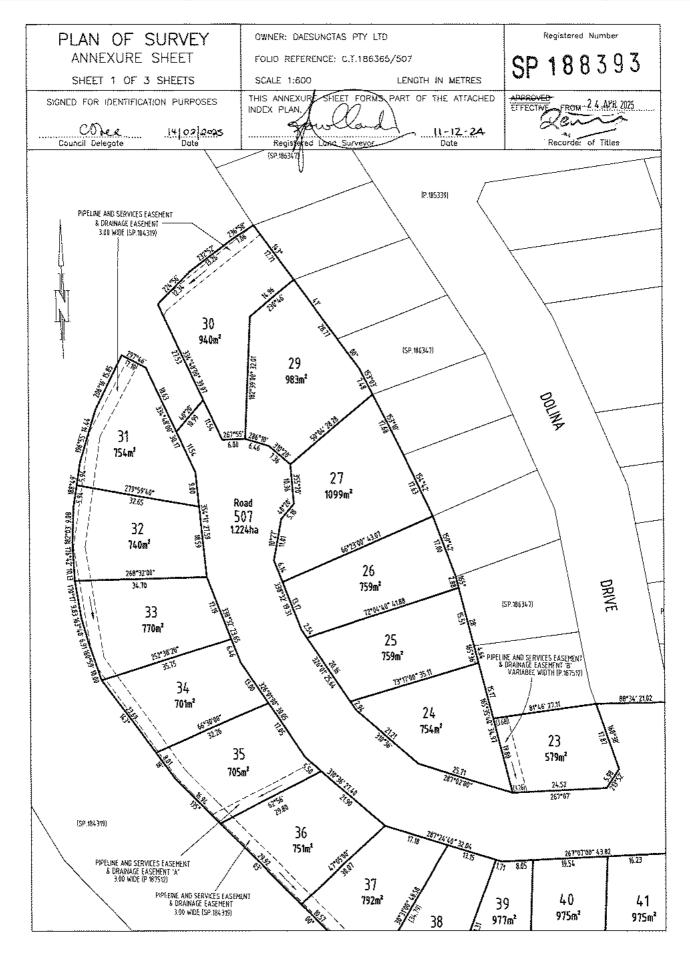
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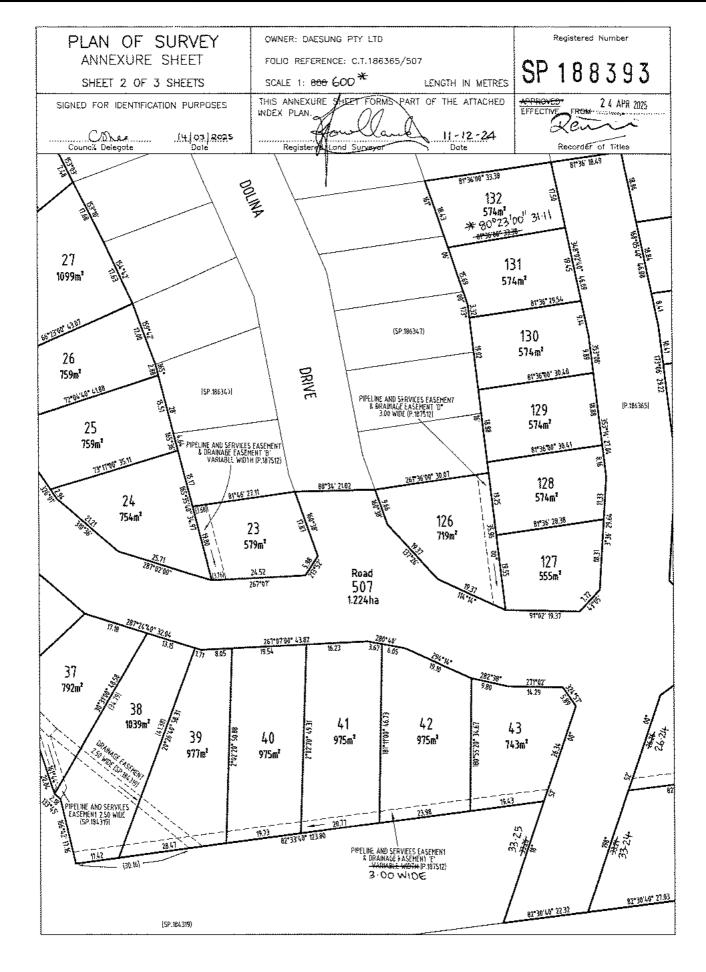
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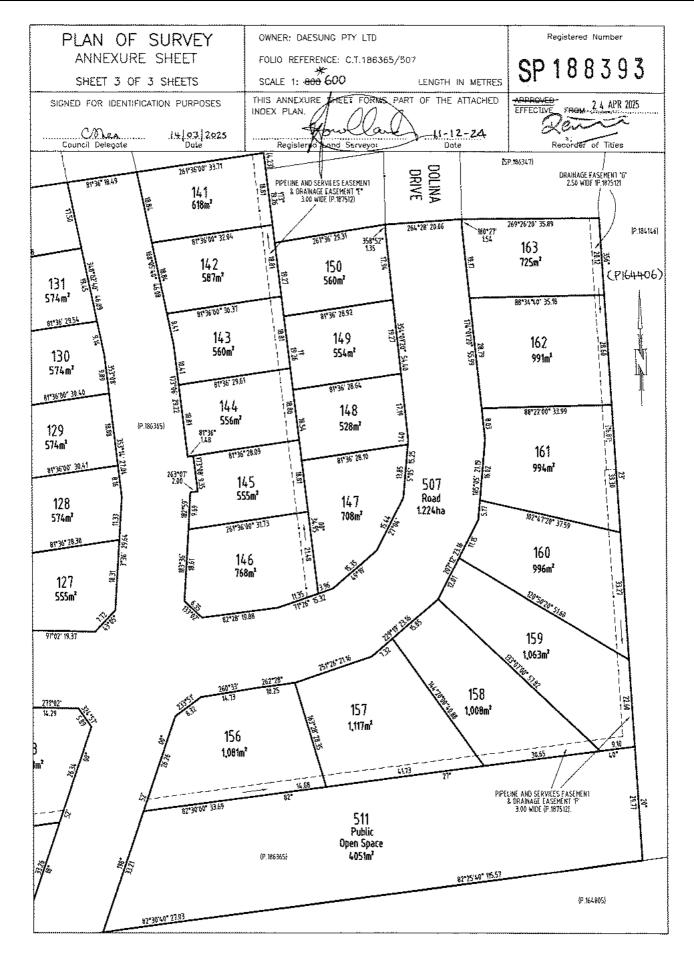
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SCHEDULE OF EASEMENTS

NOTE: THE SCHEDULE MUST BE SIGNED BY THE OWNERS &

MORTGAGEES OF THE LAND AFFECTED. SIGNATURES MUST BE ATTESTED.

Registered Number

SP 188393

PAGE 1 OF 8 PAGES

EASEMENTS AND PROFITS

Each lot on the plan is together with:

- (1) such rights of drainage over the drainage ensements shown on the plan (if any) as may be necessary to drain the stormwater and other surplus water from such lot; and
- (2) any casements or profits a prendre described hereunder.

Each for on the plan is subject to:

- (1) such rights of drainage over the drainage easements shown on the plan (if any) as passing through such tot as may be necessary to drain the stormwater and other surplus water from any other lot on the plan; and
- (2) any easements or profits a prendre described hereunder.

The direction of the flow of water through the drainage casements shown on the plan is indicated by arrows.

EASEMENTS

Lors 30 to 37 (inclusive) on the Plan ("the Lots") are subject to a PIPELINE AND SERVICES EASEMENT (as defined herein) in gross in favour of TasWater over the land marked PIPELINE AND SERVICES EASEMENT & DRAINAGE EASEMENT 3.00 WIDE (SP.184319) shourn on the Plan ("the Easement Land").

Lots 30 to 37 (inclusive) on the Plan are subject to a Drainage Easement (as defined herein) in gross in favour of the Clarence City Council over the land marked PIPELINE AND SERVICES EASEMENT & DRAINAGE EASEMENT 3.00 WIDE (SP.184319) on the Plan.

Lot 35 on the Plan ("the Lot") is subject to a PIPELINE AND SERVICES EASEMENT (as defined herein) in gross in favour of TasWater over the land marked PIPELINE AND SERVICES EASEMENT & DRAINAGE EASEMENT 'A' 3.00 WIDE (P.187512) shown on the Plan ("the Easement Land").

Lot 35 on the Plan is subject to a Drainage Easement (as defined herein) in gross in favour of the Clarence City Council over the land marked PIPELINE AND SERVICES EASEMENT & DRAINAGE EASEMENT 'A' 3.00 WIDE (P.187512) on the Plan.

Director E

Director/Secretary

(USE ANNEXURE PAGES FOR CONTINUATION)

SUBDIVIDER: DAESUNGTAS PTY LTD

FOLIO REF: 186365/507

SOLICITOR

& REFERENCE: Page Scager (DAS 221111)

PLAN SEALED BY: Clarence City Council

DATE 14th March 2025

ATEL AREMIER AND ALL MARKET

REF NO. SD-2016/3 Council

Clare Shee

NOTE: The Council Delegate must sign the Certificate for the purposes of Leatification.

Search Date: 10 Jul 2025 Search Time: 01:09 PM Volume Number: 188393 Revision Number: 01 Page 1 of 8



RECORDER OF TITLES

Issued Pursuant to the Land Titles Act 1980



ANNEXURE TO SCHEDULE OF EASEMENTS

PAGE 2 OF 8 PAGES

Registered Number

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SUBDIVIDER: DAESUNGTAS PTY LTD FOLIO REFERENCE: 186365/507

Lot 23 on the Plan ("the Lot") is subject to a PIPELINE AND SERVICES EASEMENT (as defined herein) in gross in favour of TasWater over the land marked PIPELINE AND SERVICES EASEMENT & DRAINAGE EASEMENT 'B' VARIABLE WIDTH (P.187512) show: on the Plan ("the Easement Land").

Lot 23 on the Plan is subject to a Drainage Easement (as defined herein) in gross in favour of the Clarence City Council over the land marked PIPELINE AND SERVICES EASEMENT & DRAINAGE EASEMENT 'B' VARIABLE WIDTH (P.187512) on the Plan.

Lots 38 to 43 (inclusive) on the Plan ("the Lots") are subject to a PIPELINE AND SERVICES EASEMENT (as defined herein) in gross in favour of TasWater over the land marked PIPELINE AND SERVICES EASEMENT & DRAINAGE EASEMENT 'C' VARIABLE WIDTH (P.187512) shown on the Plan 3-00 WIDE ("the Easement Land").

Lot 126 on the Plan ("the Lot") is subject to a PIPELINE AND SERVICES EASEMENT (as defined herein) in gross in favour of TasWater over the land marked PIPELINE AND SERVICES EASEMENT & DRAINAGE EASEMENT 'D' 3.00 WIDE (P.187512) shown on the Plan ("the Easement Land").

Lot 126 on the Plan is subject to a Drainage Easement (as defined herein) in gross in favour of the Clarence City Council over the land marked PIPELINE AND SERVICES EASEMENT & DRAINAGE EASEMENT 'D' 3.00 WIDE (P.187512) on the Plan.

Director

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Director/Secretary

NOTE: Every annexed page must be signed by the parties to the dealing or where the party is a corporate body be signed by the persons who have attested the affixing of the seal of that body to the dealing.

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Search Date: 10 Jul 2025 Search Time: 01:09 PM Volume Number: 188393 Revision Number: 01 Page 2 of 8



RECORDER OF TITLES

Issued Pursuant to the Land Titles Act 1980



ANNEXURE TO SCHEDULE OF EASEMENTS

PAGE 2 OF 8 PAGES

Registered Number

SP 188393

SUBDIVIDER: DAESUNGTAS PTY LTD FOLIO REFERENCE: 186365/307

Lots 141 to 146 (inclusive) on the Plan ("the Lots") are subject to a PIPELINE AND SERVICES EASEMENT (as defined herein) in gross in favour of TasWater over the and marked PIPELINE AND SERVICES EASEMENT & DRAINAGE EASEMENT 'E' 3.00 WIDE (P.187512) shown on the Plan ("the Easement Land").

Lots 141 to 146 (inclusive) on the Plan are subject to a Drainage Easement (as defined herein) in gross in favour of the Clarence City Council over the land marked PIPELINE AND SERVICES EASEMENT & DRAINAGE EASEMENT 'E' 3.00 WIDE (P.187512) on the Plan.

Lots 156 to 161 (inclusive) on the Plan ("the Lots") are subject to a PIPELINE AND SERVICES EASEMENT (as defined herein) in gross in favour of TasWater over the land marked PIPELINE AND SERVICES EASEMENT & DRAINAGE EASEMENT 'F' 3.00 WIDE (P.187512) shown on the Plan ("the Easement Land").

Lots 156 to 161 (inclusive) on the Plan are subject to a Drainage Easement (as defined herein) in gross in favour of the Clarence City Council over the land marked PIPELINE AND SERVICES EASEMENT & DRAINAGE EASEMENT 'F' 3.00 WIDE (P.187512) on the Plan.

Lots 161 to 163 (inclusive) on the Plan are subject to a Drainage Easement (as defined herein) in gross in favour of the Clarence City Council over the land marked DRAINAGE EASEMENT 'G' 2.50 WIDE (P.1875)2) on the Plan.

Lots 37 and 38 on the Plan ("the Lots") are subject to a PIPELINE AND SERVICES EASEMENT (as defined herein) in gross in Givour of TasWater over the land marked PIPELINE AND SERVICES EASEMENT 2.50 WIDE (SP.184319) shown on the Plan ("the Easement Land").

Lots 37, 38 and 39 on the Plan are subject to a Drainage Easement (as defined herein) in gross in favour of the Clarence City Council over the land marked DRAINAGE EASEMENT 2.50 WIDE (SP.184319) on the Plan.

Director

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Director/Secretary

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Search Date: 10 Jul 2025 Search Time: 01:09 PM Volume Number: 188393 Revision Number: 01 Page 3 of 8



RECORDER OF TITLES

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ANNEXURE TO SCHEDULE OF EASEMENTS

PAGE 4 OF 8 PAGES

Registered Number

SP 188393

SUBDIVIDER: DAESUNGTAS PTY LTD FOLIO REFERENCE: 186365/507

Each lot on the Plan is together with a right of way created by and fully described in the Schedule of Easements to SP 142549 over the land marked RIGHT OF WAY (PRIVATE) 10.06 WIDE (SP.142549) on the Plan.

Each lot on the Plan is together with a right of carriageway and service easement created by and fully described in C849483 over the land marked RIGHT OF WAY (PRIVATA) & SERVICE EASEMENT 20.00 WIDE (P.154357) (created by C849483) on the Plan.

COVENANTS

The owner of each Lot on the Plan covenants with the Vendor (Daesung as Pty Ltd) and the Owner or Owners for the time being of every other Lot shown on the Plan to the atent that the burden of these covenants may run with and bind the covenantor's Lot and every part thereof and that the benefit thereof shall be annexed to and devolve with each and every part of every other Lot shown on the plan to observe the following stipulations:

- 1. Not to subdivide that Lot at any time without the prior consent in writing of the Corporation.
- 2. Not to erect on that Lot more than a single residence, which may include an ancillary apartment together with usual outbuildings as may be permitted by the Corporation, without the consent of the Corporation.
- 3. Not to use the land for any purpose except as a residence or the for the purpose of house occupation without the prior consent of the Corporation in writing.
- 4. Not to use any engine or machinery in any trade of business, nor erect or use or permit to be used on any part of any lot shown on the Plan nor to conduct or permit to be conducted any trade or business on or from any part of the same, including but not limited to mining, quarrying, or market gardening. The leasing of the property for private residential purposes is not therefore to be a breach of this covenant.
- 5. Not to keep any animals other than domestic pets on any lot shown on the Plan and not to make any application for a kennel licence in respect of any lot shown on the Plan nor to keep or establish or

Director

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Director/Secretary

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Search Date: 10 Jul 2025 Search Time: 01:09 PM Volume Number: 188393 Revision Number: 01 Page 4 of 8



RECORDER OF TITLES

Issued Pursuant to the Land Titles Act 1980



ANNEXURE TO SCHEDULE OF EASEMENTS

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Registered Number

SP

188393

SUBDIVIDER: DAESUNGTAS PTY LTD FOLIO REFERENCE: 186365/507____

permit to be kept or established any licensed kennel upon any lot or any part of any lot shown on the Plan nor to keep at one time more than two adult canines on any lot shown on the Plan.

6. The Vendor may, at the Vendor's absolute discretion, waive the burden of any covenant contained in this Schedule of Easements in favour of any lot by notice in writing to the registered proprietor of that lot.

FENCING PROVISION

In respect of the Lots shown on the Plan, the Vendor (Daesungtas Pty Ltd) shall not be required to fence.

DEFINITIONS

"Corporation" means the Warden Councillors and Electors of the City of Clarence.

"Drainage Easement" means a right of drainage (including the right of construction of drains) for Clarence City Council with which the right shall be capable of enjoyment for the purpose of carrying away stormwater and other surplus water from any land over or under the land herein indicated as the land over which the right is to subsist, and through all sewers and drains which may hereafter be made or passing under, through, and along the last-mentioned land and the right for Chirence City Council and its employees, agents and contractors from time to time and at all times hereafter if it or they should think fit to enter into and upon the last-mentioned land and to inspect, repair, cleanse, and amend any such sewer or drain without doing unnecessary damage to the said land.

"Pipeline and Services Easement" is defined as follows:-

FIRSTLY, THE FULL AND FREE RIGHT AND LIBERTY for TasWater and its employees, contractors, agents and all other persons duly authorised by it, at all times to

Director

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Director/Secretary

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Search Date: 10 Jul 2025 Search Time: 01:09 PM Volume Number: 188393 Revision Number: 01 Page 5 of 8



RECORDER OF TITLES

Issued Pursuant to the Land Titles Act 1980



ANNEXURE TO SCHEDULE OF EASEMENTS

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SUBDIVIDER: DAESUNGTAS PTY LTD FOLIO REFERENCE: 186365/507

- (1) enter and remain upon the Easement Land with or without machinery, vehicles, plant and equipment;
- (2) investigate, take soil, rock and other samples, survey, open and brea. up and excavate the Easement Land for any purpose or activity that TasWater is authorised to do or undertake;
- (3) install, retain, operate, modify, relocate, maintain, inspect, cleanse, repair, remove and replace the Infrastructure;
- (4) run and pass sewage, water and electricity through and along the Intirestructure;
- (5) do all works reasonably required in connection with such activities or as may be authorised or required by any law:
 - (a) without doing innecessary damage to the Easement Land; and
 - (b) leaving the Easement Land in a clean and tidy condition;
- (6) If the Easement Land is not directly accessible from a highway, then for the purpose of undertaking gay of the preceding activities TasWater may with or without employees, contractors, agents and any other persons authorised by it, and with or without grachinery, vehicles, plant and equipment enter the Lot from the highway at any vehicle entry and cross the Lot to the Easement Land; and
- (7) use the Easement Land as a right of carriageway for the purpose of undertaking any of the preceding purposes on other land, TasWater reinstating any damage that it causes in doing so to any boundary fence of the Lot.

SECONDLY, the benefit of a covenant in gross for TasWater with the registered proprietor/s of the Easement Land and their successors and assigns not to erect any building, or place any structures, objects, vegetation, or remove any thing that supports, protects or covers any Infrastructure on or in the Easement Land, without the prior written consent of TasWater to the intent that the burden of the covenant may run with and bind the servient land and every part thereof and that the benefit thereof may be annexed to the easement herein described.

Interpretation:

. Missessor 粉箱


Director/Secretary

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Search Date: 10 Jul 2025 Search Time: 01:09 PM Volume Number: 188393 Revision Number: 01 Page 6 of 8



RECORDER OF TITLES



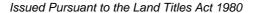

ANNEXURE TO SCHEDULE OF EASEMENTS

PAGE 7 OF 8 PAGES

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SUBDIVIDER: DAESUNGTAS PTY LTO-FOLIO REFERENCE: 186365/507

"Infrastructure" means infrastructure owned or for which TasWater is responsible and includes but is not limited to:

- (a) sewer pipes and water pipes and associated valves;
- (b) telemetry and monitoring devices;
- (c) inspection and access pits;
- (d) electricity assets and other conducting media (excluding telemetry and monitoring devices);
- (e) markers or signs indicating the location of the Ensement Land or any other Infrastructure or any warnings or restrictions with respect to the Easement Land or any other Infrastructure;
- (f) anything reasonably required to support, protect or cover any other intrastructure;
- (g) any other infrastructure whether of a similar nature or not to the preceding which is reasonably required for the piping of sewage or water, or the running of electricity, through the Easement Land or monitoring or managing that activity; and
- (h) where the context permits, any part of the infrastructure.

"TasWater" means Tasmanian Water & Sewerage Corporation Pty Ltd (ACN 162 220 653), its successors and assigns.

Director

to to


Director/Secretory

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Search Date: 10 Jul 2025 Search Time: 01:09 PM Volume Number: 188393 Revision Number: 01 Page 7 of 8



RECORDER OF TITLES



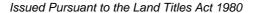

ANNEXURE TO SCHEDULE OF EASEMENTS

PAGE 8 OF 8 PAGES

Registered Number

SP 188393

SUBDIVIDER: DAESUNGTAS PTY LTD
FOLIO REFERENCE: 186365/507

EXECUTED by DAESUNGTAS PTY LTD (ACN 607)

472 131) as registered proprietor of the land comprised in)

Folio of the Register Volume 186365/507 Folio 507 in)
accordance with section 127 of the Corporations Act 2001)
(Cth) by:

Director Signature

Velic Toric Director/*Secretary Signature

DONG Keyn 400n *Birector/Secretary Full Name (print)

(*please strike out inapplicable)

*Bailce Saward Representative for Transferor Page Seager

Director To

Director/Secretary

NOTE: Every annexed page must be signed by the parties to the dealing of the teal of that body to the dealing.

Search Date: 10 Jul 2025 Search Time: 01:09 PM Volume Number: 188393 Revision Number: 01 Page 8 of 8

PROPOSED UNIT DEVELOPMENT LOT 162, DOLINA DRIVE ROKEBY

| C001 | COVER | В | 01/10/2025 |
|------|------------------------------------|---|------------|
| C101 | SITE PLAN | В | 01/10/2025 |
| C102 | ROAD AND STORMWATER PLAN - SHEET 1 | В | 01/10/2025 |
| C103 | SEWER AND WATER PLAN - SHEET 1 | В | 01/10/2025 |
| C105 | TURNPATH PLAN | В | 01/10/2025 |
| C201 | LONG SECTIONS - SHEET 1 | В | 01/10/2025 |
| C202 | CROSS SECTIONS - SHEET 1 | В | 01/10/2025 |
| C301 | STORMWATER LONG SECTIONS- SHEET 1 | В | 01/10/2025 |
| C302 | SEWER LONG SECTIONS - SHEET 1 | В | 01/10/2025 |

| | | | DRAWN: | HL |
|-----|----------------------|-----------|-----------|----|
| | | | CHECKED: | RP |
| | | | DESIGN: | HL |
| В | RFI RESPONSE | 1/10/2025 | CHECKED: | NM |
| Α | DEVELOPMENT APPROVAL | 1/08/2025 | VERIFIED: | RP |
| REV | ISSUE | DATE | APPROVAL | |




| Lower Ground | |
|-----------------------|--|
| 199 Macquarie Street | |
| Hobart TAS 7000 | |
| 03 6234 8666 | |
| mail@aldanmark.com.au | |
| www.aldanmark.com.au | |

| ROJECT: | PROPOSED UNIT DEVELOPMENT | ADDRESS: | LOT 162, DOLINA DRIVE ROKEBY | SHEET: | COVER | | | |
|---------|---------------------------|----------|---------------------------------|-----------|--------------|-----------------|---------|---|
| | | CLIENT: | TASSIE HOMES (ACCOUNTS) | SCALE: | AS INDICATED | TOTAL SHEETS: 9 | SIZE: A | 1 |
| | | | | PROJECT N | 25E12-7 | SHEET: C001 | REV: | В |



Document Set ID: 5712079 Version: 1, Version Date: 07/10/2025

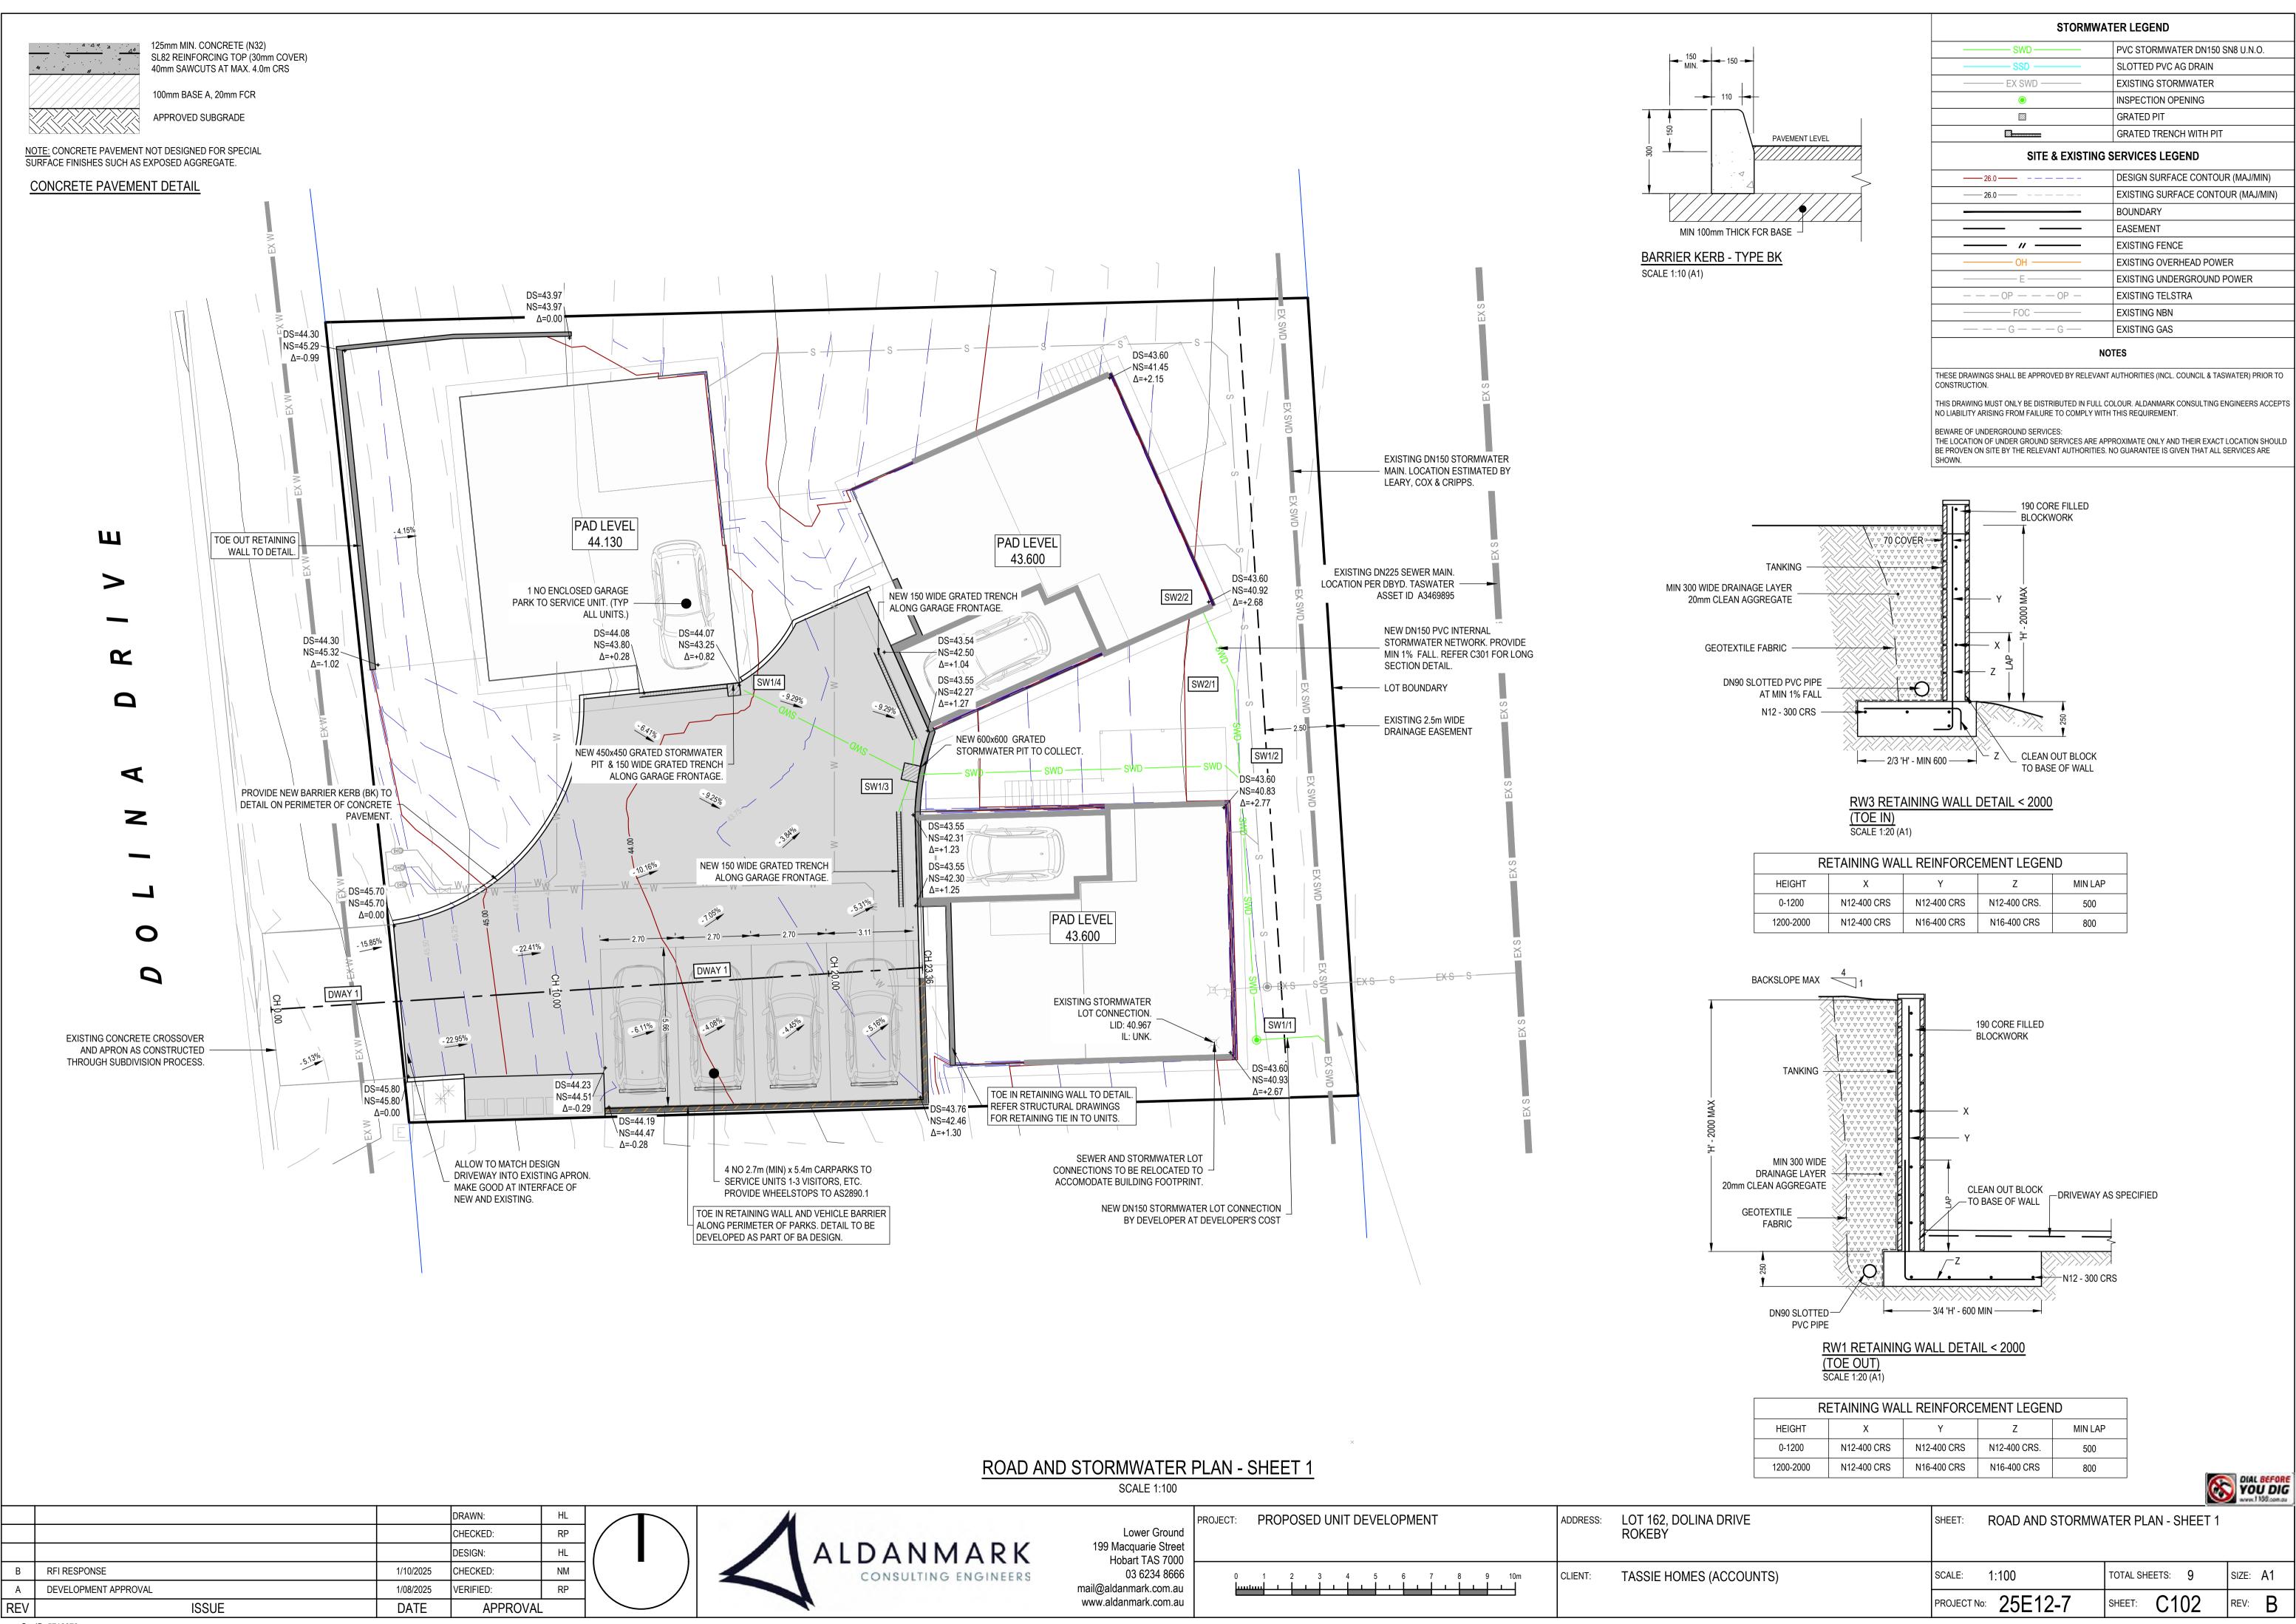



SEWER AND WATER PLAN - SHEET 1 SCALE 1:100

RFI RESPONSE DEVELOPMENT APPROVAL ISSUE



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| ROJECT: | PROPOSED UN | IT DEVELOPMEN | NT | ADDRESS: | LOT 162, DOLINA DRIVE ROKEBY |
|--------------|-------------|---------------|-----------|----------|---------------------------------|
| 0 | 1 2 3 | 4 5 6 | 7 8 9 10m | CLIENT: | TASSIE HOMES (ACCOUNTS) |

| | SLOTTED PVC AG DRAIN |
|----------------------|-----------------------------|
| | TABLE DRAIN |
| ——— EX SWD ——— | EXISTING STORMWATER |
| • | INSPECTION OPENING |
| 2 | GRATED PIT |
| 2 | GRATED TRENCH WITH PIT |
| SEWE | R LEGEND |
| s | uPVC SEWER DN100 SN6 U.N.O. |
| ———— EX S ——— | EXISTING SEWER |
| • | SEWER FIXTURE |
| IO | INSPECTION OPENING |

STORMWATER LEGEND

WATER SERVICES LEGEND

IOS

HDPE WATER 250D POLY (20ID) CONNECTION WITH 20mm WATER METER INCL. OF BACKFLOW PREVENTION AS PER TWS-W-0002

INSPECTION OPENING TO SURFACE

PVC STORMWATER DN150 SN8 U.N.O.

SITE & EXISTING SERVICES LEGEND DESIGN SURFACE CONTOUR (MAJ/MIN) _____26.0 _____ - _ - _ - _ -EXISTING SURFACE CONTOUR (MAJ/MIN) BOUNDARY EASEMENT EXISTING FENCE EXISTING OVERHEAD POWER EXISTING UNDERGROUND POWER EXISTING TELSTRA --- OP -- OP -EXISTING NBN ------FOC ------EXISTING GAS

THESE DRAWINGS SHALL BE APPROVED BY RELEVANT AUTHORITIES (INCL. COUNCIL & TASWATER) PRIOR TO

THIS DRAWING MUST ONLY BE DISTRIBUTED IN FULL COLOUR. ALDANMARK CONSULTING ENGINEERS ACCEPTS NO LIABILITY ARISING FROM FAILURE TO COMPLY WITH THIS REQUIREMENT.

BEWARE OF UNDERGROUND SERVICES: THE LOCATION OF UNDER GROUND SERVICES ARE APPROXIMATE ONLY AND THEIR EXACT LOCATION SHOULD BE PROVEN ON SITE BY THE RELEVANT AUTHORITIES. NO GUARANTEE IS GIVEN THAT ALL SERVICES ARE

WATER & SEWER NOTES


ALL WORKS ARE TO BE IN ACCORDANCE WITH THE WATER SUPPLY CODE OF AUSTRALIA WSA 03 - 2011-3.1 VERSION 3.1 MRWA EDITION V2.0 AND SEWERAGE CODE OF AUSTRALIA MELBOURNE RETAIL WATER AGENCIES CODE WSA 02 - 2014-3.1 MRWA VERSION 2 AND TASWATER'S SUPPLEMENTS TO THESE CODES


WATER METER ASSEMBLY TO BE HOUSED IN VANDAL PROOF CAGE AS PER TWS-W-0003. DEVELOPER TO LIAISE WITH TASWATER FOR SUPPLY OF ABLOY LOCK AND PIN AT DEVELOPERS COST

DIAL BEFORE
YOU DIG

SHEET: SEWER AND WATER PLAN - SHEET 1

| | DESIGN: | HL | | ALDANMARK | Hobart TAS 7000 | |
|-----------|-----------|----|---|----------------------|-----------------------|---|
| 1/10/2025 | CHECKED: | NM | \ | CONSULTING ENGINEERS | 03 6234 8666 | 0 1 2 3 4 5 6 7 8 9 10m CLIENT: TASSIE HOMES (ACCOUNTS) SCALE: 1:100 TOTAL SHEETS: 9 SIZE: A1 |
| 1/08/2025 | VERIFIED: | RP | | | mail@aldanmark.com.au | |
| DATE | APPROVA | \L | | | www.aldanmark.com.au | PROJECT No: 25E12-7 SHEET: C103 REV: B |
| | | | | | | |

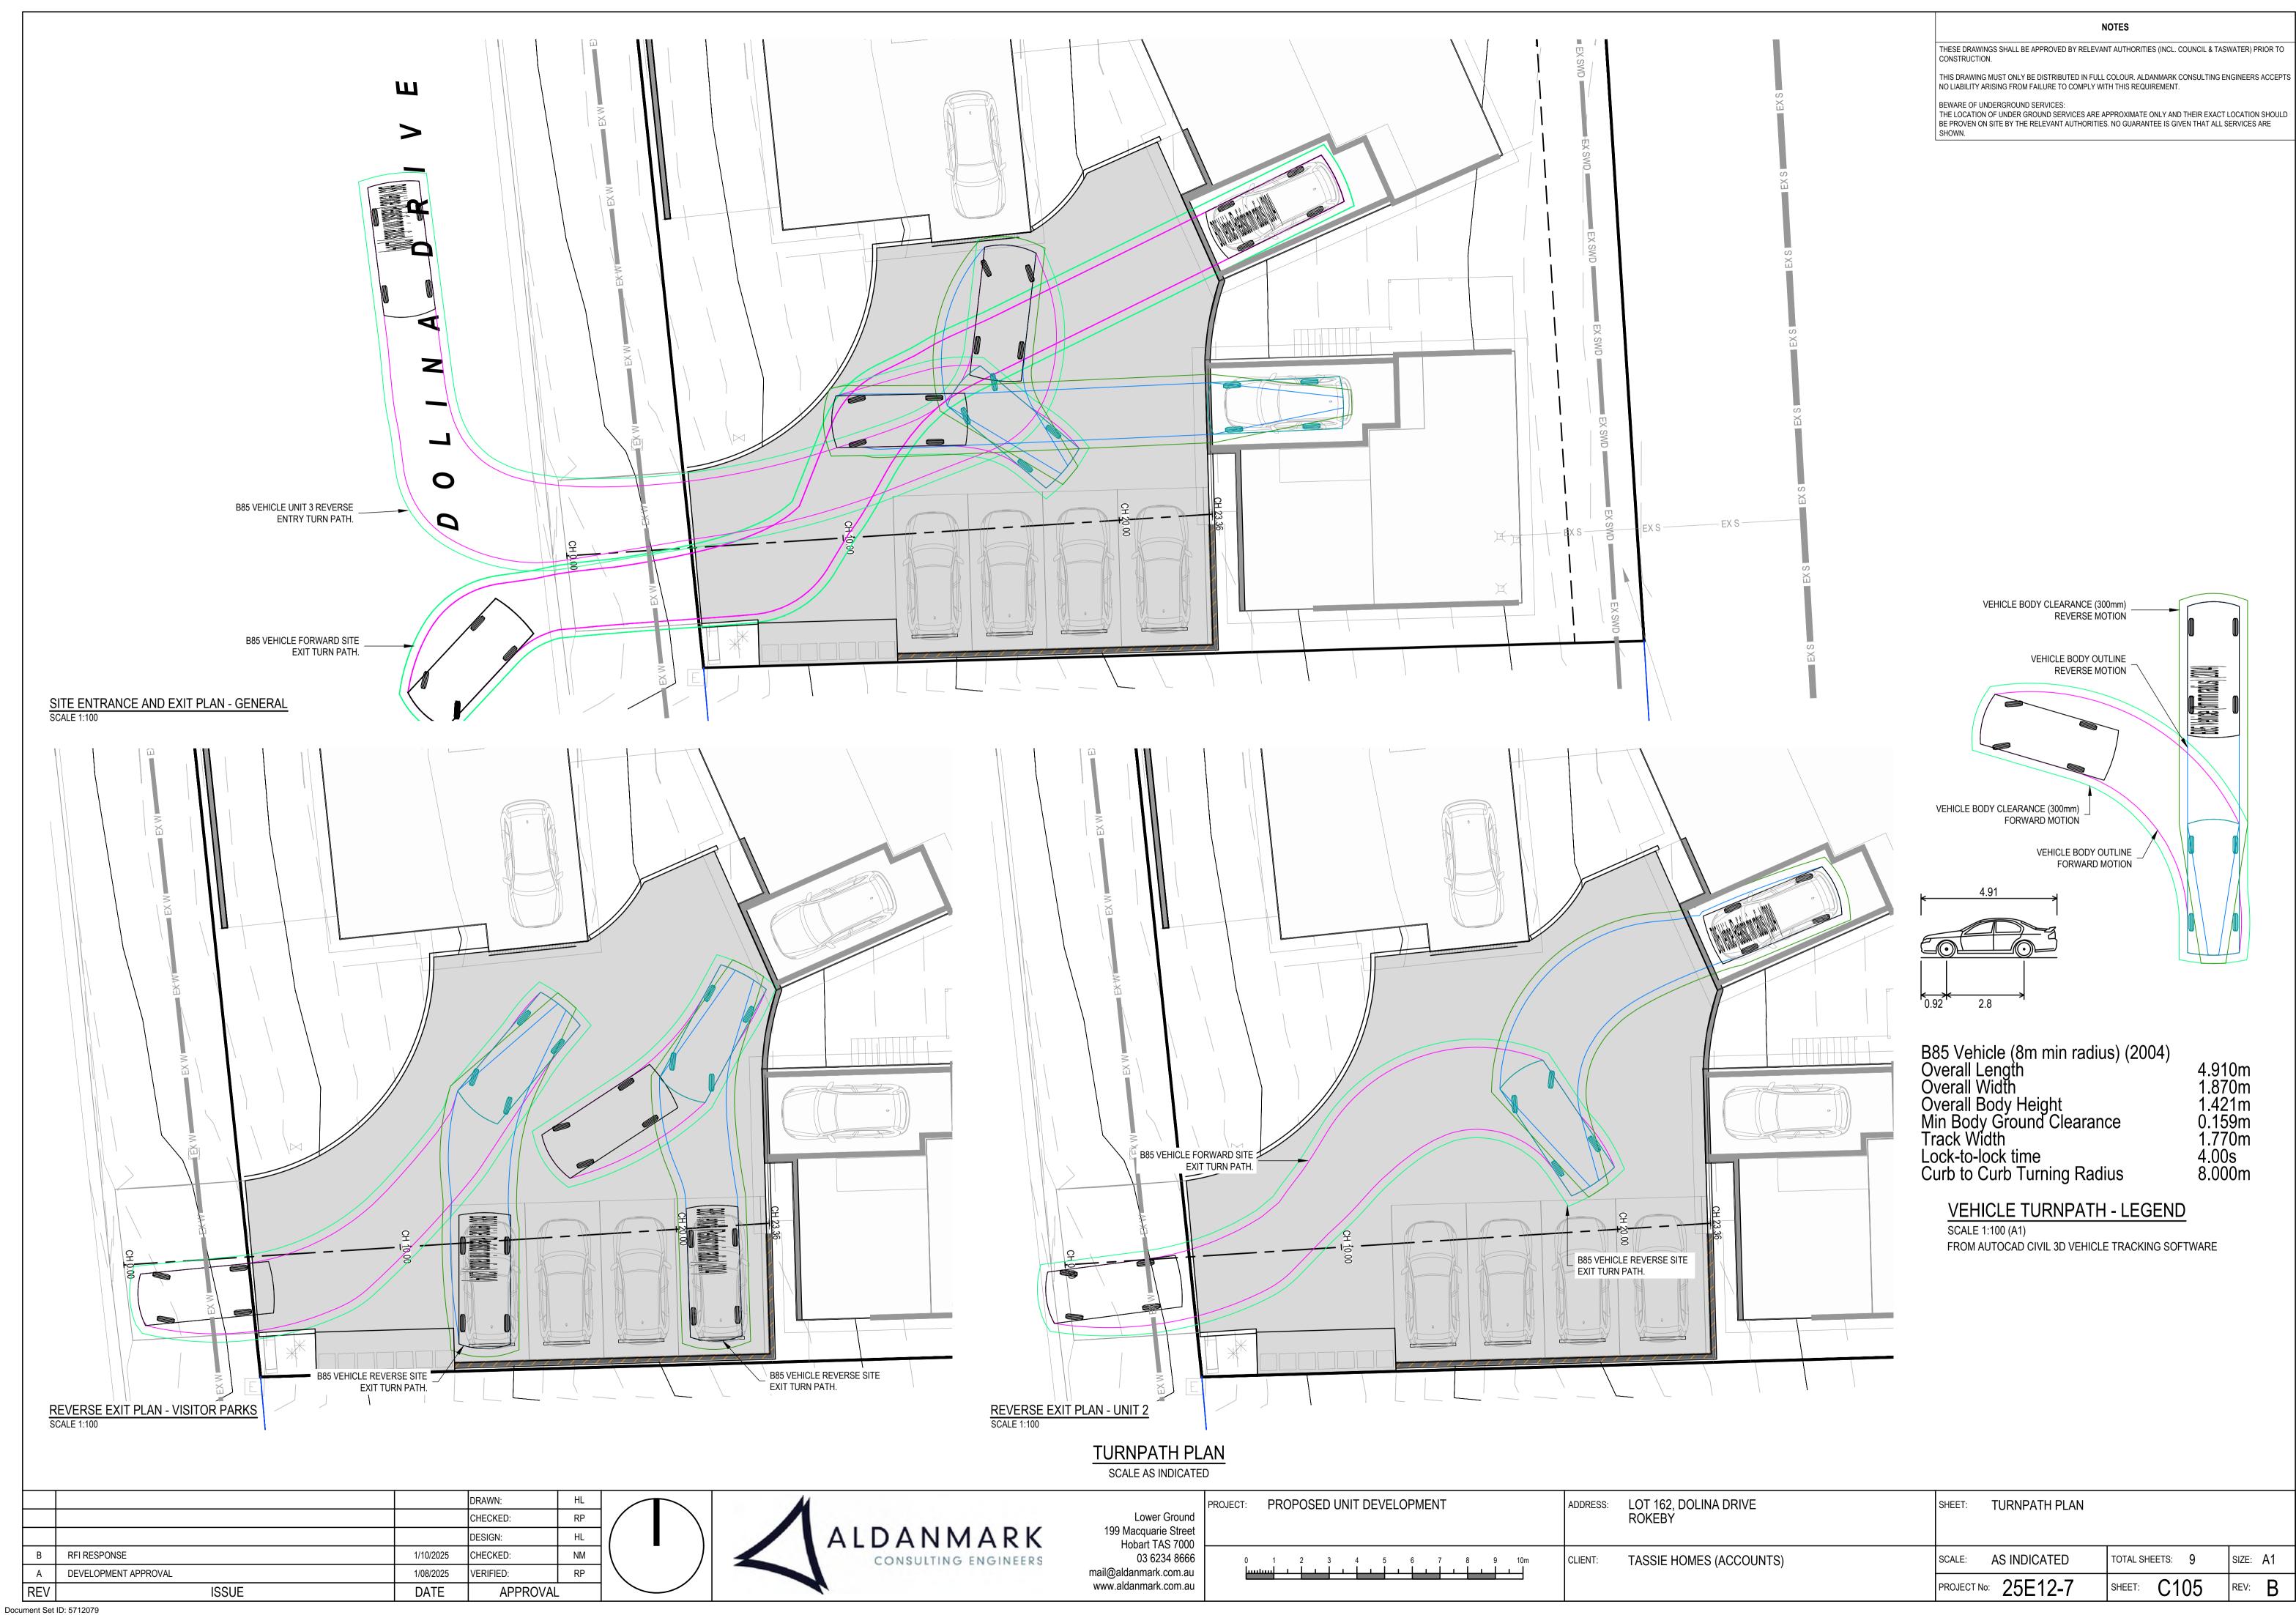

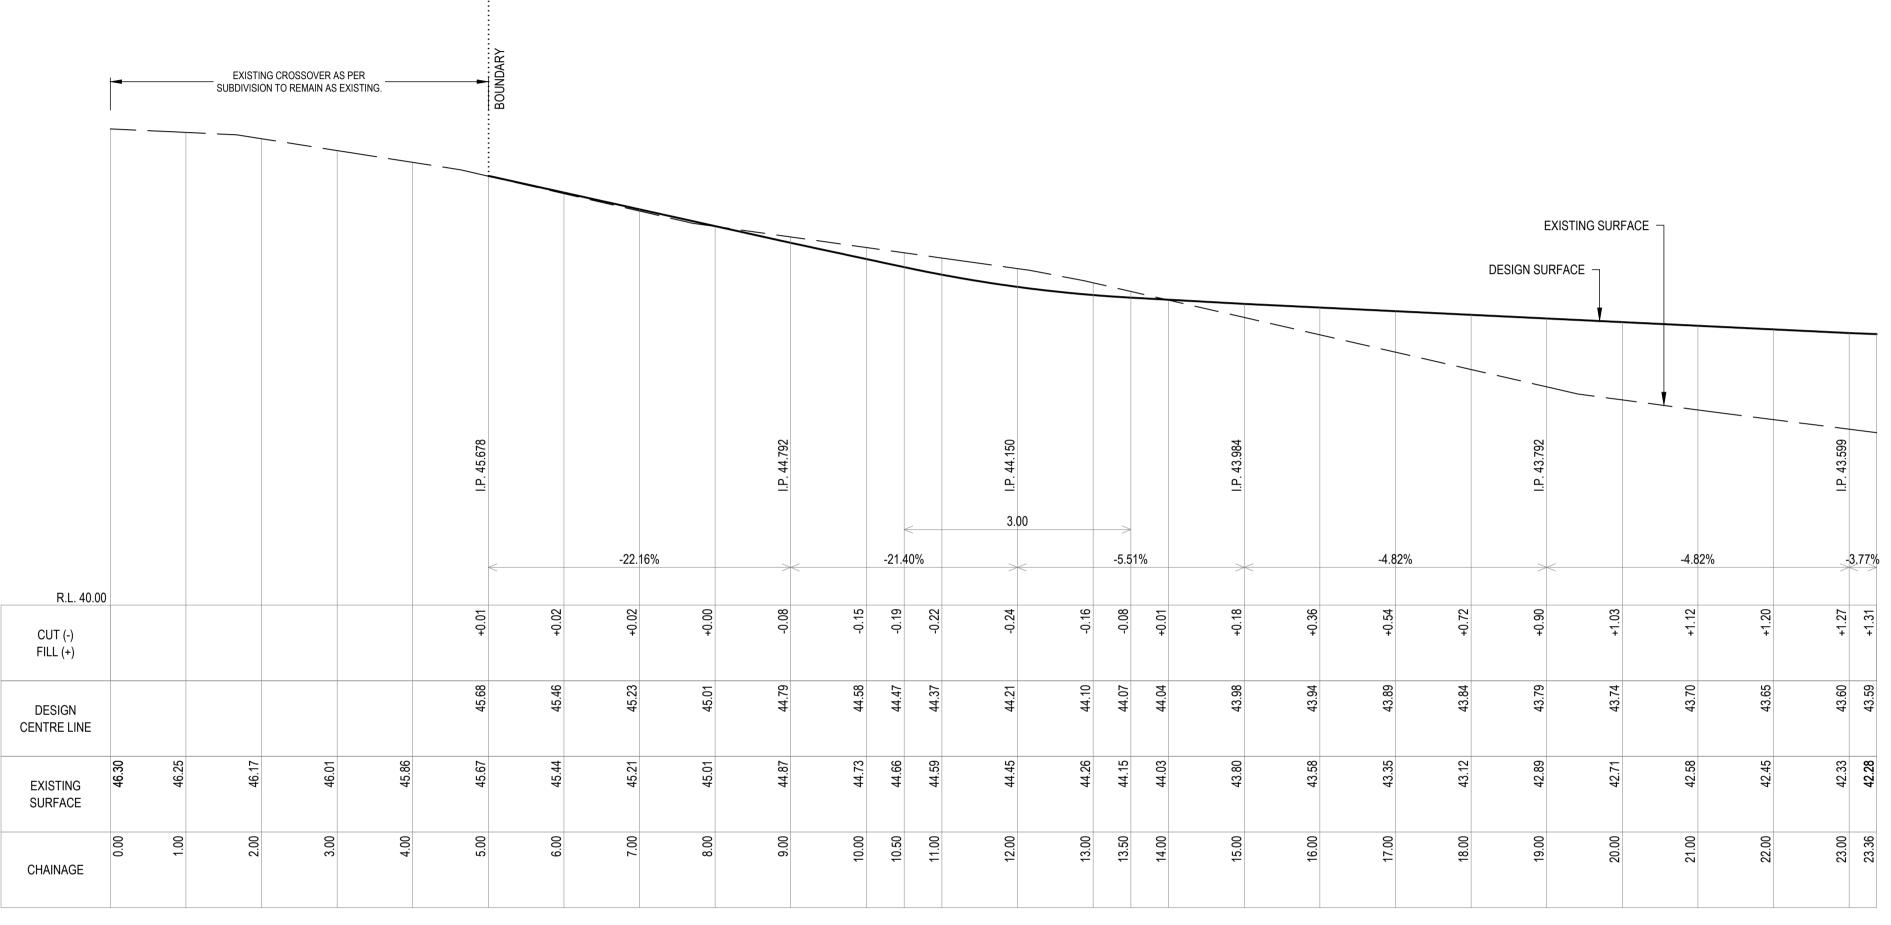

From 0.000m To 23.364m Scales: H 1:50 V 1:50

LONG SECTIONS - SHEET 1

SCALE AS INDICATED



| Lower Ground |
|-----------------------|
| 199 Macquarie Street |
| Hobart TAS 7000 |
| 03 6234 8666 |
| mail@aldanmark.com.au |
| www.aldanmark.com.au |

| d et | PROJECT: PROPOSED UNIT DEVELOPMENT | ADDRESS: | LOT 162, DOLINA DRIVE ROKEBY | SHEET: | LONG SECTIONS - SH | EET 1 |
|---------|------------------------------------|----------|---------------------------------|------------|--------------------|--------------------|
| 6 | H1:100 | CLIENT: | TASSIE HOMES (ACCOUNTS) | SCALE: | AS INDICATED | TOTAL SHEETS: 9 |
| u U | V1:50 0 0.5 1.0 1.5 2.0 2.5m | | | PROJECT No | 25E12-7 | SHEET: C201 |

NOTES

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BEWARE OF UNDERGROUND SERVICES:
THE LOCATION OF UNDER GROUND SERVICES ARE APPROXIMATE ONLY AND THEIR EXACT LOCATION SHOULD
BE PROVEN ON SITE BY THE RELEVANT AUTHORITIES. NO GUARANTEE IS GIVEN THAT ALL SERVICES ARE

REV: B

CONSTRUCTION.

BEWARE OF UNDERGROUND SERVICES:
THE LOCATION OF UNDER GROUND SERVICES ARE APPROXIMATE ONLY AND THEIR EXACT LOCATION SHOULD
BE PROVEN ON SITE BY THE RELEVANT AUTHORITIES. NO GUARANTEE IS GIVEN THAT ALL SERVICES ARE EXISTING SURFACE -RETAINING WALL AND VEHICLE DESIGN SURFACE -- BARRIER TO FURTHER DESIGN AS PART OF BA PROCESS. TYP. RL42.3m RL40.8m CUT (-) / FILL CUT (-) / FILL 43.873 44.230 DESIGN 42.391 43.600 4 4 ____ DESIGN 43. 43.83 44.26 44.26 42.33 42.46 **EXISTING** 42.39 **EXISTING** ____ -21.97 -25.00 -24.91 -17.66 4.68 4.71 6.20 7.00 OFFSET OFFSET Ch 13.00 m Ch 23.00 m RL42.6m RL41.2m CUT (-) / FILL CUT (-) / FILL 44.160 44.585 44.587 DESIGN ____ DESIGN 4 4 **EXISTING** 42.71 ____ **EXISTING** -21.81 OFFSET OFFSET Ch 10.00 m Ch 20.00 m RL42.7m RL42m CUT (-) / FILL CUT (-) / FILL 45.747 44.130 45.608 DESIGN DESIGN ___ 45.59 45.59 45.74 45.74 43.65 43.73 **EXISTING EXISTING** ____ ____ -10.59 2.75 -22.55 OFFSET OFFSET Ch 5.00 m Ch 15.00 m **CROSS SECTIONS - SHEET 1** SCALE AS INDICATED LOT 162, DOLINA DRIVE ROKEBY DRAWN: SHEET: CROSS SECTIONS - SHEET 1 PROPOSED UNIT DEVELOPMENT

Lower Ground

199 Macquarie Street Hobart TAS 7000 03 6234 8666

mail@aldanmark.com.au

www.aldanmark.com.au

CONSULTING ENGINEERS

NOTES

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CONSTRUCTION.

SCALE: AS INDICATED

PROJECT No: 25E12-7

TOTAL SHEETS: 9

SHEET:

C202

REV: B

TASSIE HOMES (ACCOUNTS)

RFI RESPONSE

DEVELOPMENT APPROVAL

ISSUE

RP

HL

CHECKED:

DESIGN:


CHECKED:

VERIFIED:

APPROVAL

1/08/2025

DATE

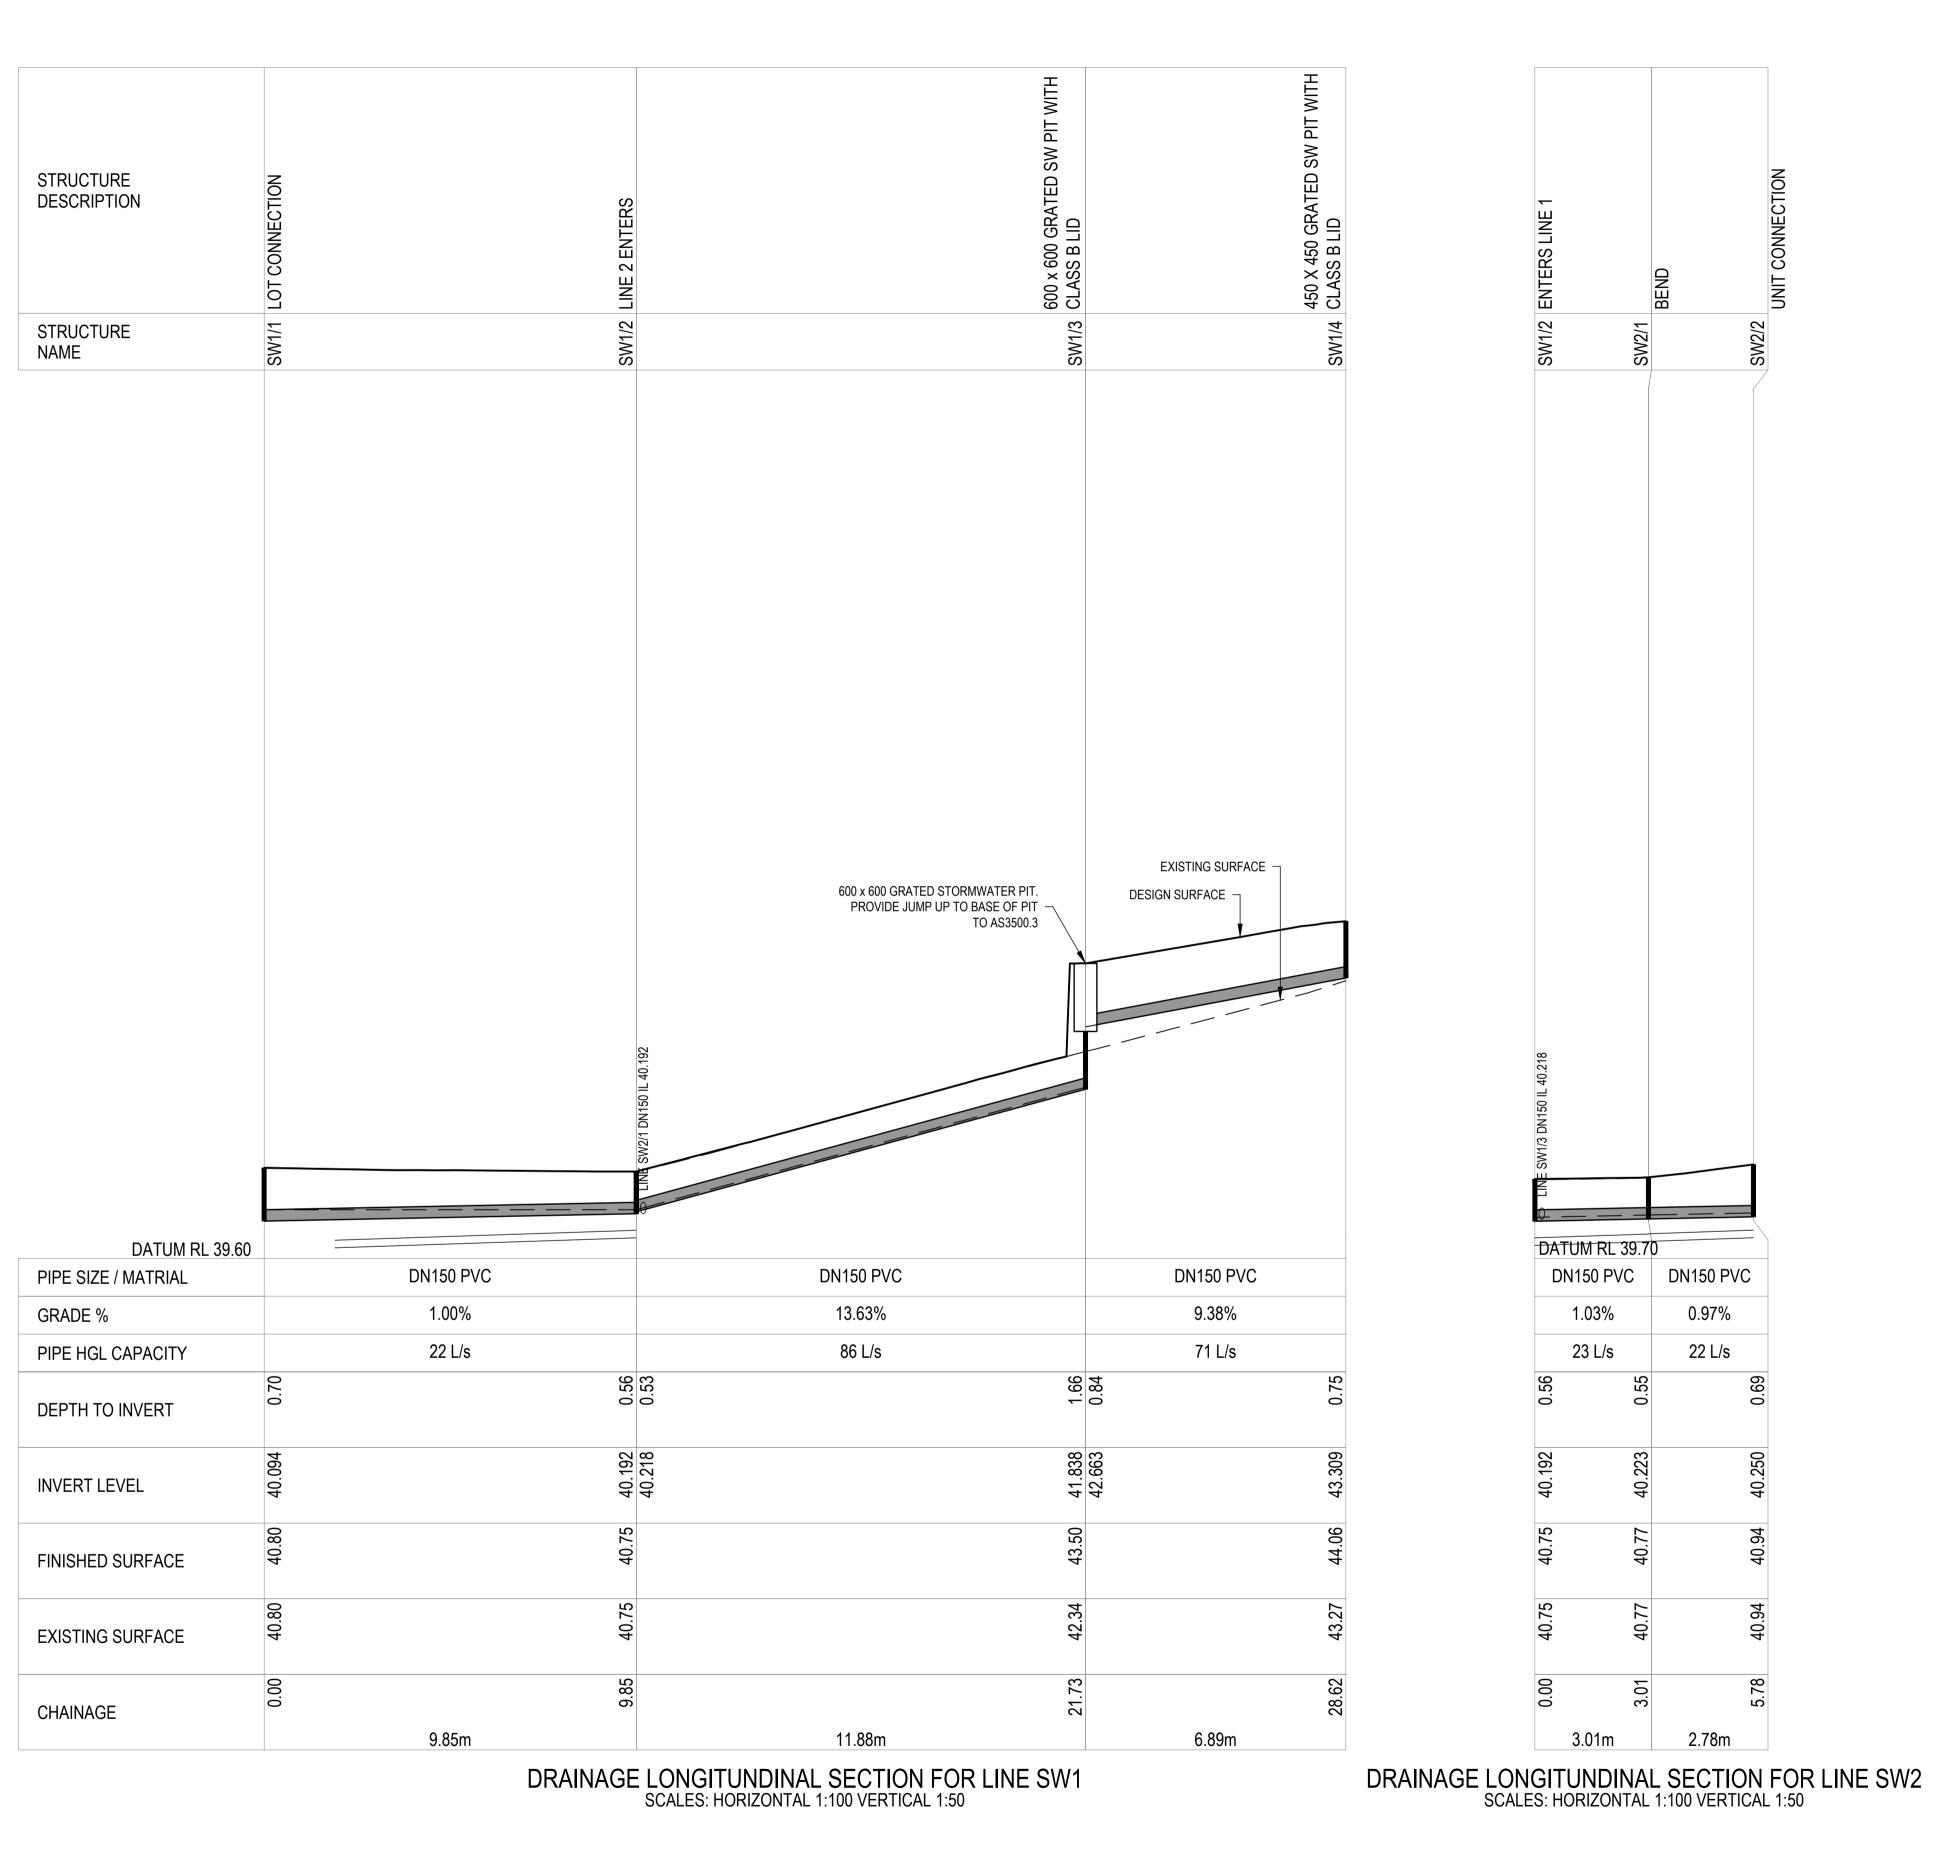

STORMWATER LONG SECTIONS- SHEET 1 SCALE AS INDICATED

DRAWN: RP CHECKED: HL NM RFI RESPONSE CHECKED: DEVELOPMENT APPROVAL RP 1/08/2025 VERIFIED: ISSUE DATE APPROVAL



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|-----------------------|
| 199 Macquarie Street |
| Hobart TAS 7000 |
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| mail@aldanmark.com.au |
| www.aldanmark.com.au |

| ROJECT: | PROPOSED UNIT DEVELOPMENT | ADDRESS: | L F |
|---------|---------------------------------|----------|--------|
| | 0 1 2 3 4 5m H1:100 V1:50 | CLIENT: | 1 |

| LOT 162, DOLINA DRIVE ROKEBY | SH |
|---------------------------------|----|
| TASSIE HOMES (ACCOUNTS) | SO |

SHEET: STORMWATER LONG SECTIONS- SHEET 1 SCALE: AS INDICATED TOTAL SHEETS: 9

PROJECT No: 25E12-7 SHEET: **C301** REV: B

NOTES

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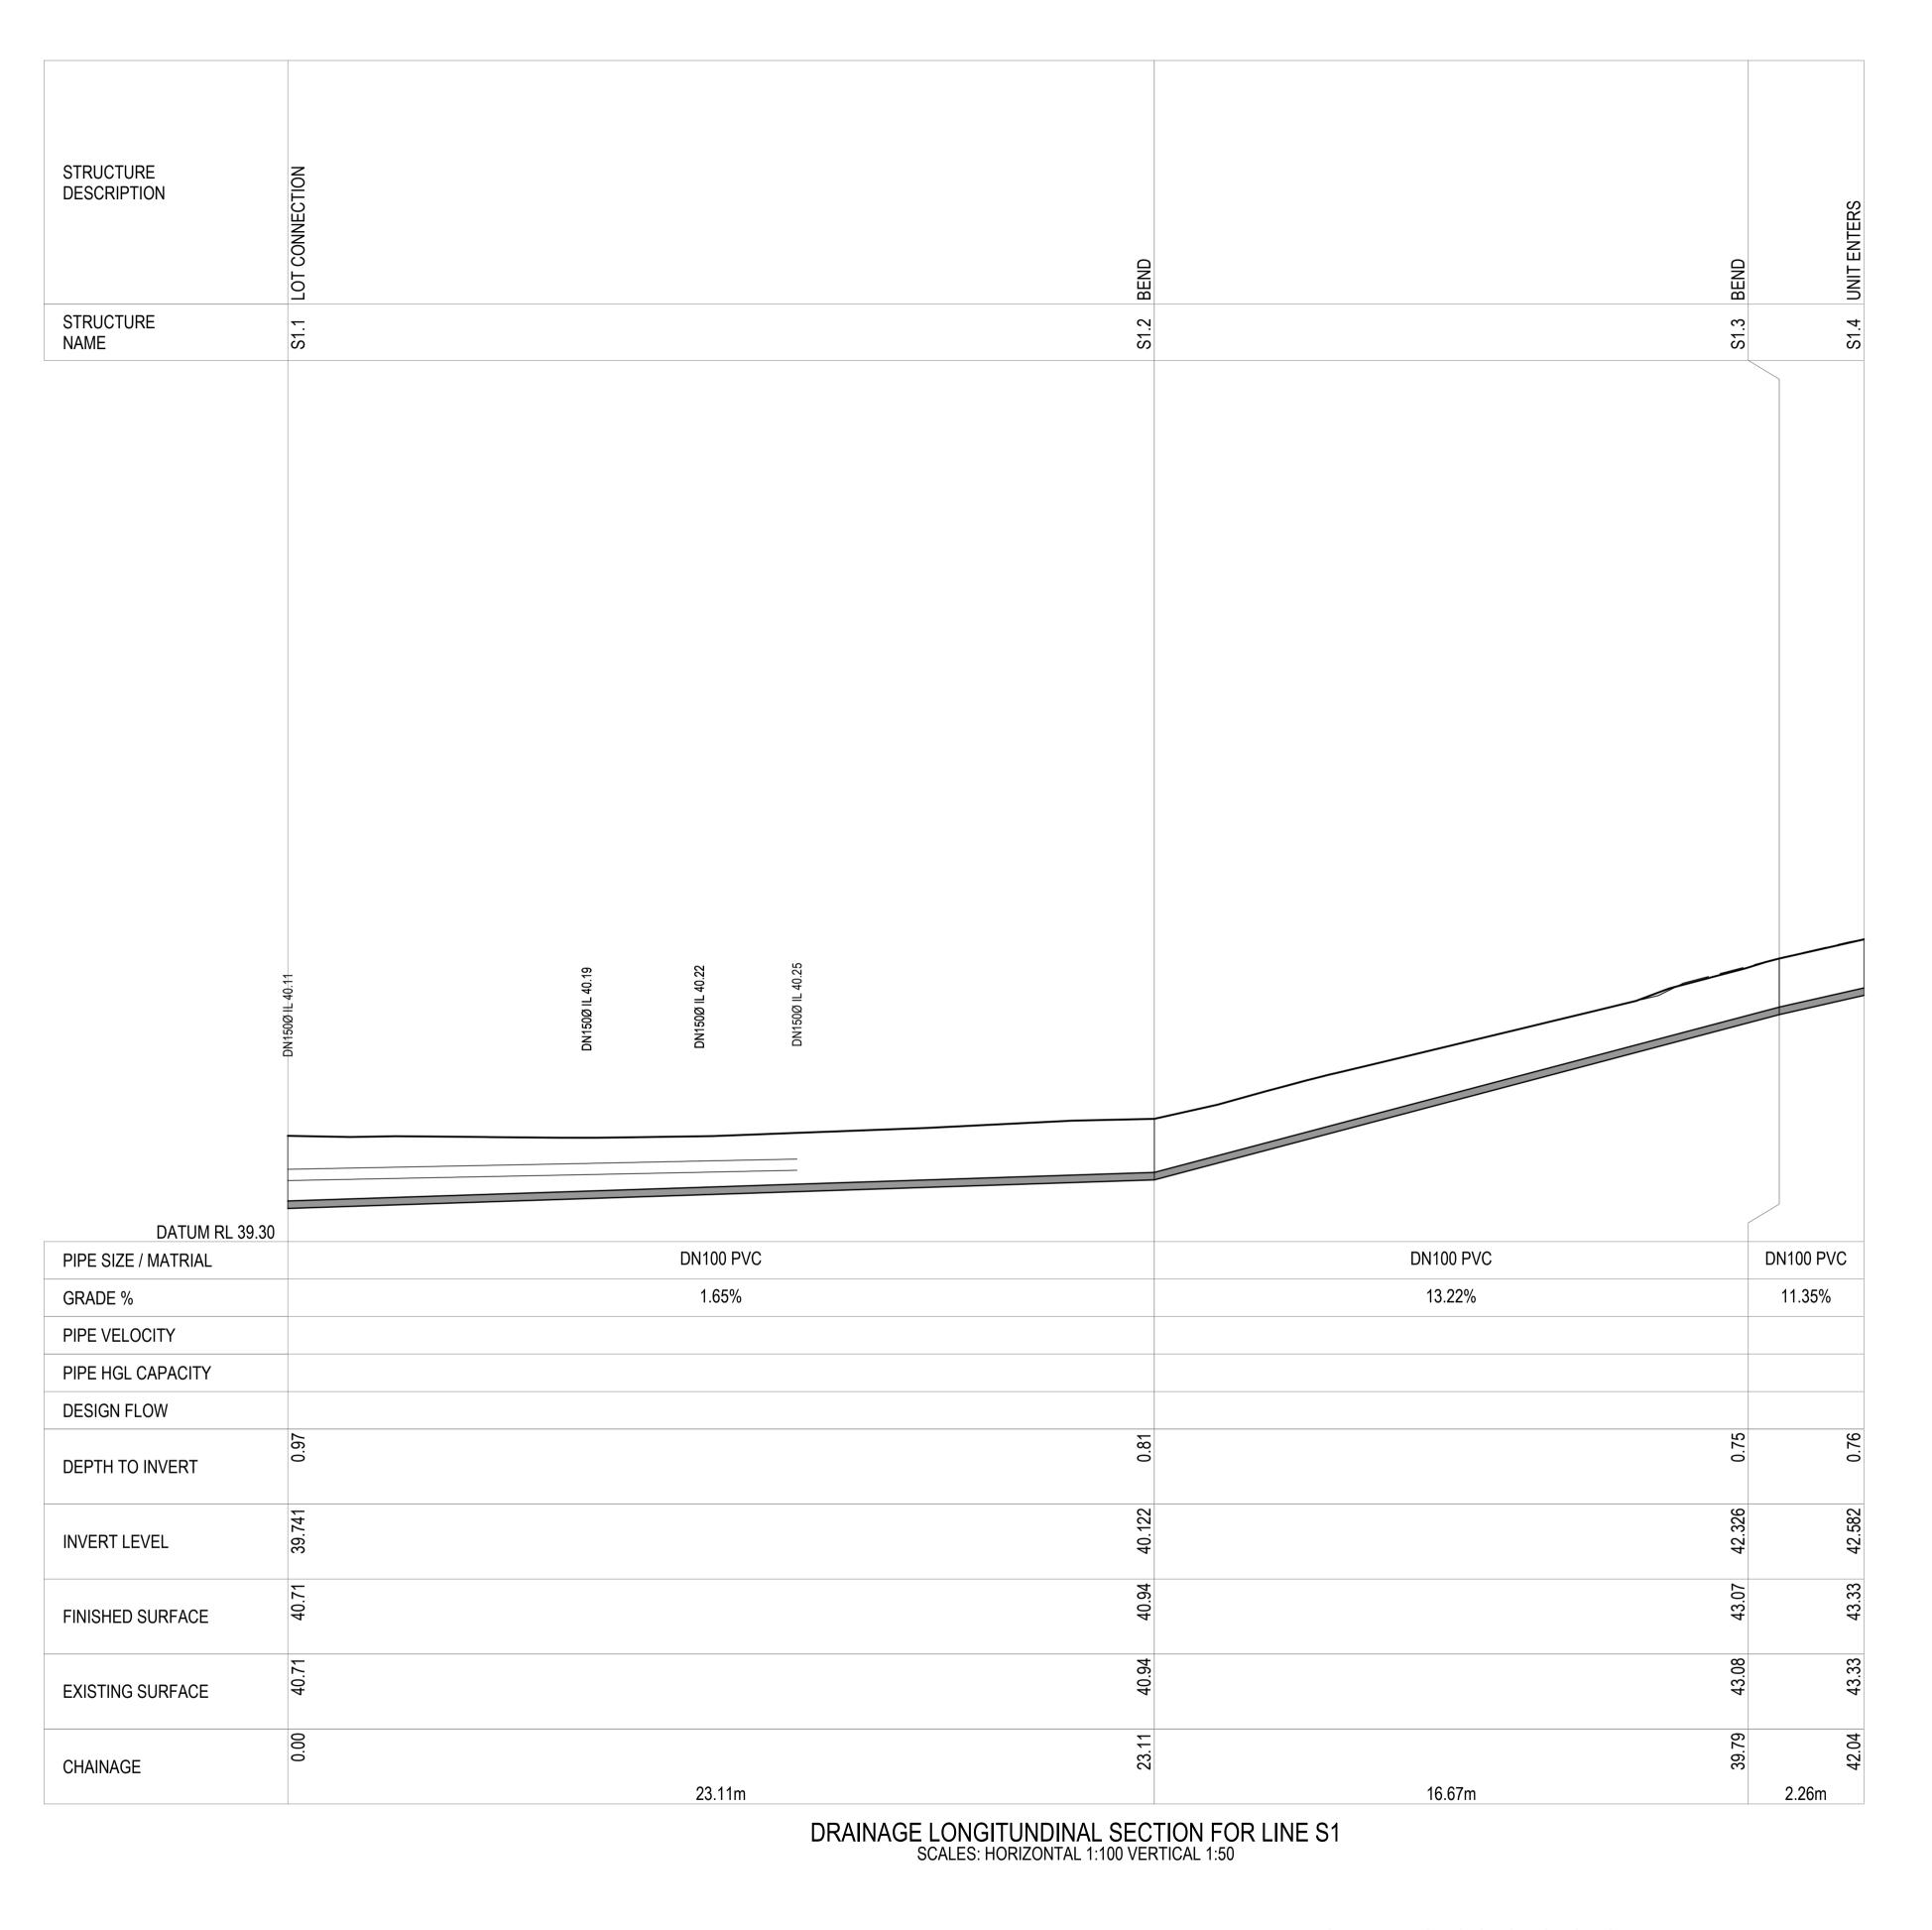
THIS DRAWING MUST ONLY BE DISTRIBUTED IN FULL COLOUR. ALDANMARK CONSULTING ENGINEERS ACCEPTS

THE LOCATION OF UNDER GROUND SERVICES ARE APPROXIMATE ONLY AND THEIR EXACT LOCATION SHOULD BE PROVEN ON SITE BY THE RELEVANT AUTHORITIES. NO GUARANTEE IS GIVEN THAT ALL SERVICES ARE

NO LIABILITY ARISING FROM FAILURE TO COMPLY WITH THIS REQUIREMENT.

CONSTRUCTION.

BEWARE OF UNDERGROUND SERVICES:



SEWER LONG SECTIONS - SHEET 1

SCALE AS INDICATED

| | | | DRAWN: | HL | 44 |
|-----|----------------------|-----------|-----------|----|-----|
| | | | CHECKED: | RP | |
| | | | DESIGN: | HL | ALD |
| В | RFI RESPONSE | 1/10/2025 | CHECKED: | NM | |
| Α | DEVELOPMENT APPROVAL | 1/08/2025 | VERIFIED: | RP | |
| REV | ISSUE | DATE | APPROVAL | _ | |

| Lower Ground |
|-----------------------|
| 199 Macquarie Street |
| Hobart TAS 7000 |
| 03 6234 8666 |
| mail@aldanmark.com.au |
| www.aldanmark.com.au |

| d et | PROJECT: | PROPOSED UNIT DEVELOPMENT | ADDRESS: | LOT ROK |
|---------|----------|---------------------------------|----------|------------|
| น 6 | | 0 1 2 3 4 5m H1:100 V1:50 | CLIENT: | TAS |

ADDRESS: LOT 162, DOLINA DRIVE ROKEBY

SHEET: SEWER LONG SECTIONS - SHEET 1

CLIENT: TASSIE HOMES (ACCOUNTS)

SCALE: AS INDICATED TOTAL SHEETS:

SCALE: AS INDICATED TOTAL SHEETS: 9 SIZE: A1

PROJECT No: 25E12-7 SHEET: C302 REV: B

NOTES

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BE PROVEN ON SITE BY THE RELEVANT AUTHORITIES. NO GUARANTEE IS GIVEN THAT ALL SERVICES ARE

CONSTRUCTION.

| THIS PLAN IS ACCEPTED BY: |
|--|
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| DATE: |

H1346 - Proposed 3 Unit Development, TASSIE HOMES AT 116 DOLINA DRIVE, ROKEBY

| Architectural Drawing No. | Description | Architectural Drawing No. | Description |
|------------------------------|--|------------------------------|---|
| 01 | Site Plan | 15 | Unit 2 Flooring Layout Plan |
| 01a | Solar Access Diagram | 16 | Unit 2 Lighting Calculations, Insulation & |
| 01b | Shadow Analysis | | Window Schedule |
| 02 | Drainage Plan | 17 | Unit 3 Upper Floor Plan |
| 02a | TasWater Manifold Detail | 17a | Unit 3 Lower Floor Plan |
| 02b | TasWater Non-Trafficable Box Detail | 18 | Unit 3 Elevations |
| 03 | Unit 1 Lower Floor Plan | 19 | Unit 3 Section |
| 03a | Unit 1 Upper Floor Plan | 20 | Unit 3 Roof Plan |
| 04 | Unit 1 Elevations | 21 | Unit 3 Electrical Plan |
| 05 | Unit 1 Section | 22 | Unit 3 Flooring Layout Plan |
| 06 | Unit 1 Roof Plan | 23 | Unit 3 Lighting Calculations, Insulation & |
| 07 | Unit 1 Electrical Plan | | Window Schedule |
| 08 | Unit 1 Flooring Layout Plan | 24 | Compliance Notes |
| 09 | Unit 1 Lighting Calculations, Insulation & | 24a | Liveable Housing Specifications Sheet 1 of 3 |
| | Window Schedule | 24b | Liveable Housing Specifications Sheet 2 of 3 |
| 10 | Unit 2 Upper Floor Plan | 24c | Liveable Housing Specifications Sheet 3 of 3 |
| 10a | Unit 2 Lower Floor Plan | 25 | Wet Area Specifications |
| 11 | Unit 2 Elevations | 25a | Stair Notes |
| 12 | Unit 2 Section | 25b | Balustrade Notes |
| 13 | Unit 2 Roof Plan | 26 | Vegetation Overlay |
| 14 | Unit 2 Electrical Plan | 27 | BAL Construction Requirements |
| 25 JULY 20. | 25 Preliminary drawings | Pre Eng pro | liminary construction drawings ineer not to sign this copy, only wide notes, additions & amendments Approved by Engineer |
| 25 JULY 20 | Development application drawings (DA) | | al construction drawings (BA) Approved by Building Surveyor |

PROTECTIVE COATINGS FOR STEELWORK

| ENVIDONMENT | LOCATION | MINIMUM PROTECTIVE COATING | | |
|---|----------|--|-----------------------|-------------------------------------|
| ENVIRONMENT | | General stru | ıctural steel members | Lintels in masonry |
| MODERATE | INTERNAL | No protection required | | |
| More than 1km from breaking surf or more than 100m from salt water not subject to breaking surf or non- heavy industrial areas | EXTERNAL | Option 1 2 coats alkyd primer; or Option 2 2 coats alkyd gloss Option 3 Hot dip galvanise 300 g/m² Option 4 Hot dip galvanise 100 g/m² (a) 1 coat solvent based vi | | 00 g/m² min. 00 g/m² min. plus - |

- Australia, examples of which occur around Port Pirle and Newcastle.
- 2. The outer leaf and cavity of an external masonry wall of a building, including walls under open carports are considered to be external environments. A part of an internal leaf of an external masonry wall which is located in the roof space is considered to be in an internal
- Where a paint finish is applied the surface of the steel work must be hand or power tool cleaned to remove any rust immediately prior to painting.

 4. All zinc coatings (including inorganic zinc) require a barrier coat to stop conventional domestic enamels from peeling
- Refer to the paint manufacturer where decorative finishes are required on top of the minimum coating specified in the table for protection of the steel against corrosion. 6. Internal locations subject to moisture, such as in close proximity to kitchen or bathroom exhaust fans are not considered to be in a
- permanently dry location and protection as specified for external locations is required.
- For applications outside the scope of this table, seek specialist advice.

| REVISION | DATE | SHEETS | DESCRIPTION |
|----------|-------------------|---|---|
| A | 8 July 2025 | 00, 01, 05, 05a, 06, 07, 07a & 08 | Re-draft Unit 2 and Unit 3 floor plans and elevations. Amend site plan as necessary and update setbacks and fencing. |
| В | 11 July 2025 | All preliminary DA sheets | Changes to Unit 1 windows and floor plan. Update elevations to reflect changes. Changes to Unit 3 floor plan and mirror plans to replace Unit 2. Re-draft elevations. Amend site plan to reflect changes. Re-calculate areas and amend setbacks. |
| С | 15 July 2025 | All preliminary DA sheets | Changes to to all units including windows, decks, and floor plan changes. Revise elevations to reflect changes. Move Linit 2 on silie. Relocate POS for units. Amend setbacks and dimensions where changed. |
| D | 11 September 2025 | 00, 01, new 01a & 01b, 03, 03a, 04, 09, 10, 10a, 11, 16, 17, 17a & 23 | Changes required to comply with CCC RFI including provide shadow analysts and solar access diagram. Amend parking and bin enclosure information. Show actual POS for each dwelling, provide privacy screens, reduce window sizes and change some to opaque. Change all glazing to grey, low reflectance. |



Climate Zone - 7

C.T. No. 188393/162

Wind Speed - N2

Corrosion Environment -MODERATE

Soil Classification - M

Unit 1 Lower Floor Area = 77.6m²

Unit 1 Upper Floor Area = 77.0m² Unit 1 Total Floor Area = 154.6m²

= 16.7 sq

Unit 2 Lower Floor Area $= 96.2m^2$ Unit 2 Upper Floor Area = 47.1m²

Unit 2 Total Floor Area = 143.3m²

 $= 15.4 \, \text{sg}$

Unit 3 Lower Floor Area = 96.2m² Unit 3 Upper Floor Area = 47.1m²

Unit 3 Total Floor Area = 143.3m²

 $= 15.4 \, \text{sg}$

BAL- 12.5

See sheet 27 for **Bushfire Attack Level** construction requirements

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DRAWING: FILE NAME:

DWG No:

COVER SHEET 11/09/25 H1346 DA 150515.dgn

COVER SHEET

Document Set ID: 5712079 Version: 1, Version Date: 07/10/2025

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DATE:

Α1

(a)

(b)

8.4.1 - Residential density for multiple dwellings:

SITE COVERAGE:

286.8m² (28.9%)

Max. 50% of site $= 445.5 \text{m}^2$

Proposed site coverage:

IMPERVIOUS SURFACES:

surfaces = 247.75m²

412.4m² (41.6%)

The builder shall ensure that all downpipes are connected to the stormwater drainage system as soon as possible to prevent any

erosion, swelling or saturation of


IMPORTANT NOTES:


susceptible foundation soils. Batter slopes to be in accordance with NCC Table 3.2.1. Provide retaining walls as required to comply with NCC requirements.

C.T. No. 188393/162 991m²

TASMANIAN PLANNING SCHEME GENERAL RESIDENTIAL SITE DENSITY: Min. 325m² per unit 991m² / 3 (units) = 330.3m² provided 8.4.3 - Site coverage and private open space for dwellings: Min. 25% of site to be free of impervious Proposed impervious area = 578.6m² Proposed area free of impervious surfaces:



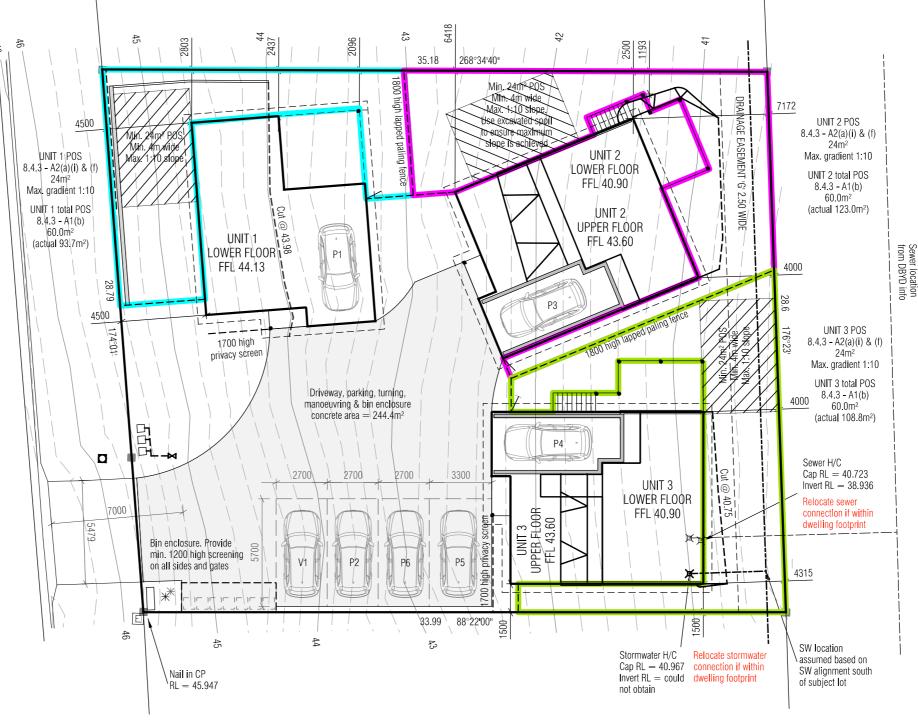

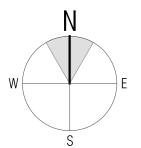

Version: 1, Version Date: 07/10/2025

Scale 1:200 Document Set ID: 5712079

PROPOSED UNIT DEVELOPMENT FOR TASSIE HOMES AT 116 DOLINA DRIVE, ROKEBY

| REVISION | DATE | DESCRIPTION |
|----------|-------------------|-------------------------------------|
| А | 8 July 2025 | Changes as described on Cover Sheet |
| В | 11 July 2025 | Changes as described on Cover Sheet |
| С | 15 July 2025 | Changes as described on Cover Sheet |
| D | 11 September 2025 | Changes as described on Cover Sheet |



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LOT BOUNDARY

− − − − EASEMENT BOUNDARY

BITUMEN EDGE

KERB INVERT KERB BACK

DRIVEWAY

———— SEWER UNDERGROUND

TITLE PEG

SURVEY MARK

STORMWATER MANHOLE

STORMWATER HOUSE CONNECTION

ELECTRICITY MAIN

CABLE HYDRO UNDERGROUND

CABLE COMMS UNDERGROUND

SEWER MANHOLE

SEWER HOUSE CONNECTION

WATER MAIN

METER WATER

BAL-12.5


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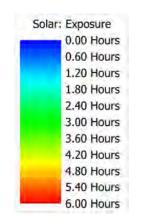
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Solar Access Diagram for 116 Dolina Drive, ROKEBY on 21 June. 42° 53' 04" South 147º 26' 16" East



BAL-12.5

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11 September 2025

Changes as described on Cover Sheet

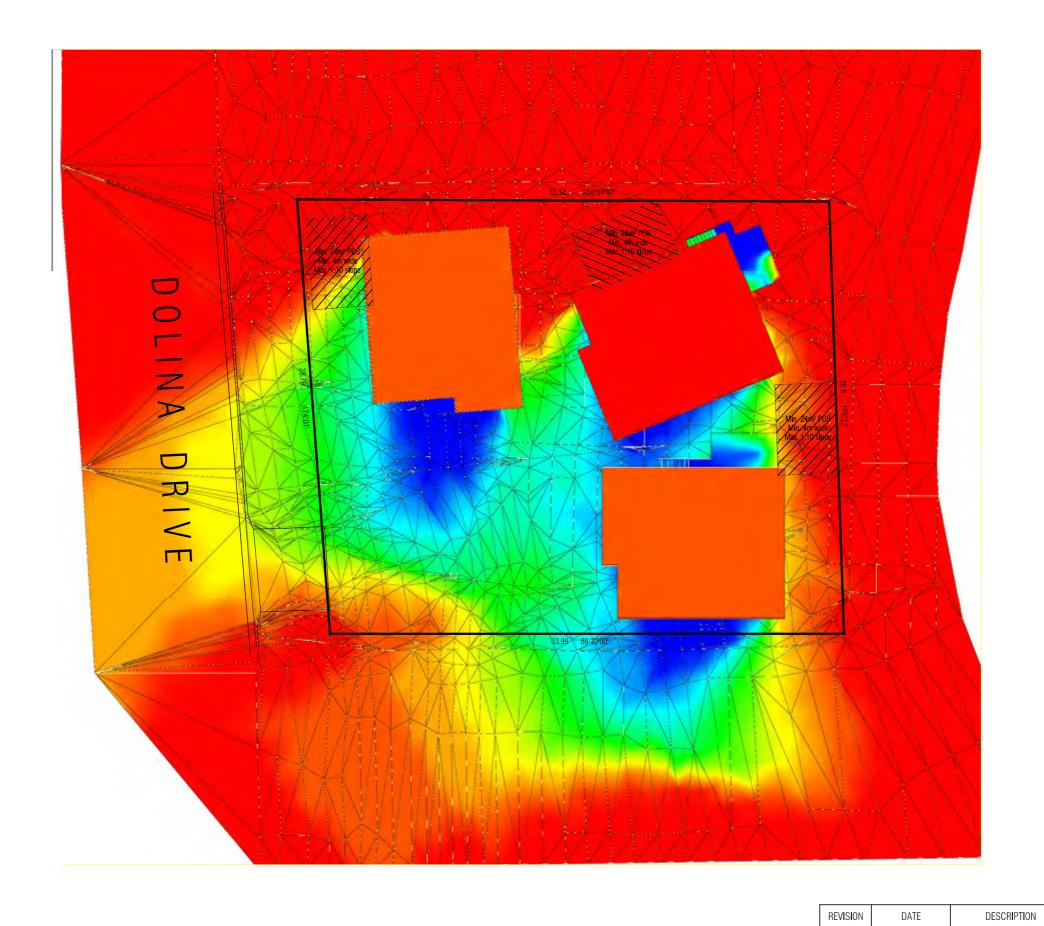SOLAR ACCESS DIAGRAM 9:00AM - 3:00PM 11/09/25 H1346 DA 150525.dgn PC

01a

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PROPOSED UNIT DEVELOPMENT FOR TASSIE HOMES AT 116 DOLINA DRIVE, ROKEBY


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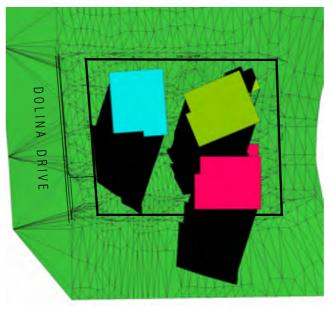
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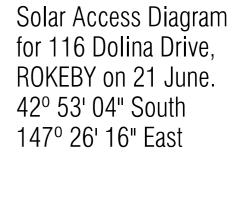





10:00 a.m.




11:00 a.m.

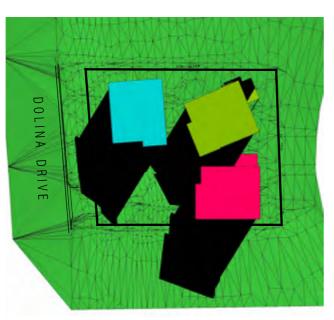


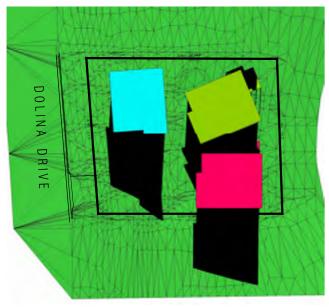


12:00 p.m.

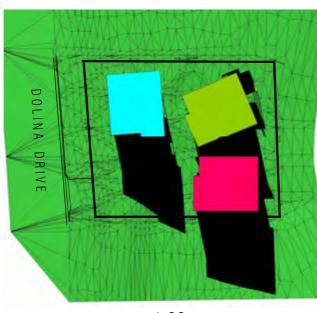

1:00 p.m.

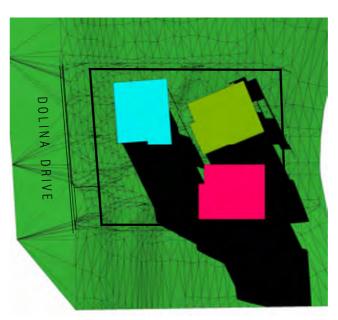

2:00 p.m.

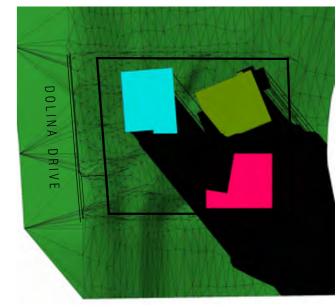

3:00 p.m.

BAL-12.5

See sheet 27 for Bushfire Attack Level construction requirements

| REVISION | DATE | DESCRIPTION |
|----------|-------------------|-------------------------------------|
| D | 11 September 2025 | Changes as described on Cover Sheet |
| | | |
| | | |
| | | |

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SHADOW DIAGRAMS 9:00AM - 3:00PM 11/09/25 H1346 DA 150525.dgn PC 01b




DATE:

DRAINAGE LEGEND

f/w FLOOR WASTE


| 1 | WC | 100 dia |
|----|----------------------------------|---------|
| 2 | HANDBASIN | 40 dia |
| 3 | SHOWER | 50 dia |
| 4 | BATH | 40 dia |
| 5 | LAUNDRY TROUGH | 50 dia |
| 6 | KITCHEN SINK | 50 dia |
| 7 | VENT | 50 dia |
| 8 | TAP CHARGED ORG min. 150mm below | FFL |
| 9 | DOWNPIPE | 90 dia |
| 10 | TAP | |
| 11 | INSPECTION OPENING TO GROUND LEV | EL |

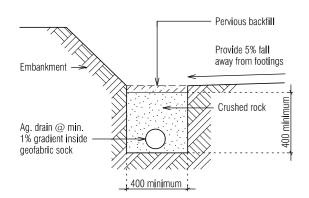

All materials and construction to comply with AS/NZS3500, 2015 and to be inspected and approved by a qualified engineer.

IMPORTANT NOTE:

All works are to be in accordance with the Water Supply Code of Australia WSA 03-2011-3.1 Version 3.1 MRWA Edition V2.0, Sewerage Code of Australia Melbourne Retail Water Agencies Code WSA 02-2014-3.1 MRWA Version 2 and TasWater's supplements to these codes

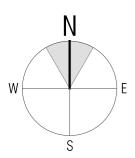

Scale 1:200

Dropper to ground Dropper - to ground level 5 To propper to ground level Dropper to ground Unit 1 Upper Floor Drainage Unit 2 Upper Floor Drainage 35.18 268°34'40" DRAINAGE EASEMENT 'G' 2.50 WIDE hot water to connect/into Overflow from stormwater Drain from heat hot water to pump units to connect into connect into heat pump stormwater stormwater Lower Floor units to drainage connect into Bath to connect f/w`w into floor waste. Fall bathroom Lower Floor upper\level Riser from \floor to waste. \overline{z} drainage Sewer location from DBYD info upper level Riser from upper level upper level 174°01 Upgrade water connection to DN32mm Lower Floor (ID25mm) with 3 x ID 20mm meters on a manifold in accordance with TWS-W-0002, page 5. Work by TasWater at applicants cost. Non-trafficable meter boxes to be supplied Riser from \Box and installed by TasWater at applicants cost. upper level Sewer H/C Water meter location is 8500 from Cap RL = 40.723Southern boundary and 600 from the Invert RL = 38.936front boundary to centre of the first meter. Relocate sewer Overflow from connection if within Riser from hot water to dwelling footprint connect into upper\level Driveway, parking, turning and Stormwater H/C stormwater manoeuvring and associated Cap RL = 40.967drainage to be designed by Invert RL = couldnot obtain civil engineer Relocate stormwater connection if within dwelling footprint 33.99 88°22**'**00" Overflow from hot water to SW location connect into assumed based on stormwater SW alignment south Nail in CP of subject lot ¹RL = 45.947

PROPOSED UNIT DEVELOPMENT FOR TASSIE HOMES

AT 116 DOLINA DRIVE, ROKEBY



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LOT BOUNDARY

———— EASEMENT BOUNDARY

BITUMEN EDGE

— KERB INVERT

--- KERB BACK

— DR**I**VEWAY

— - SEWER UNDERGROUND

■ TITLE PEG

▲ SURVEY MARK

STORMWATER MANHOLE

STORMWATER HOUSE CONNECTION

-

ELECTRICITY MAIN

K CABLE COMMS UNDERGROUND

CABLE HYDRO UNDERGROUND

SEWER MANHOLE


OLIVER INFILITIOEE

SEWER HOUSE CONNECTION

WATER MAIN

A METER WATE

■ METER WATER

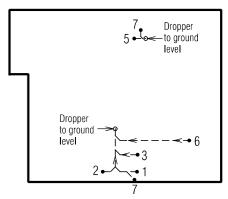

Unit 3 Upper Floor Drainage

BAL-12.5

See sheet 27 for Bushfire Attack Level construction requirements

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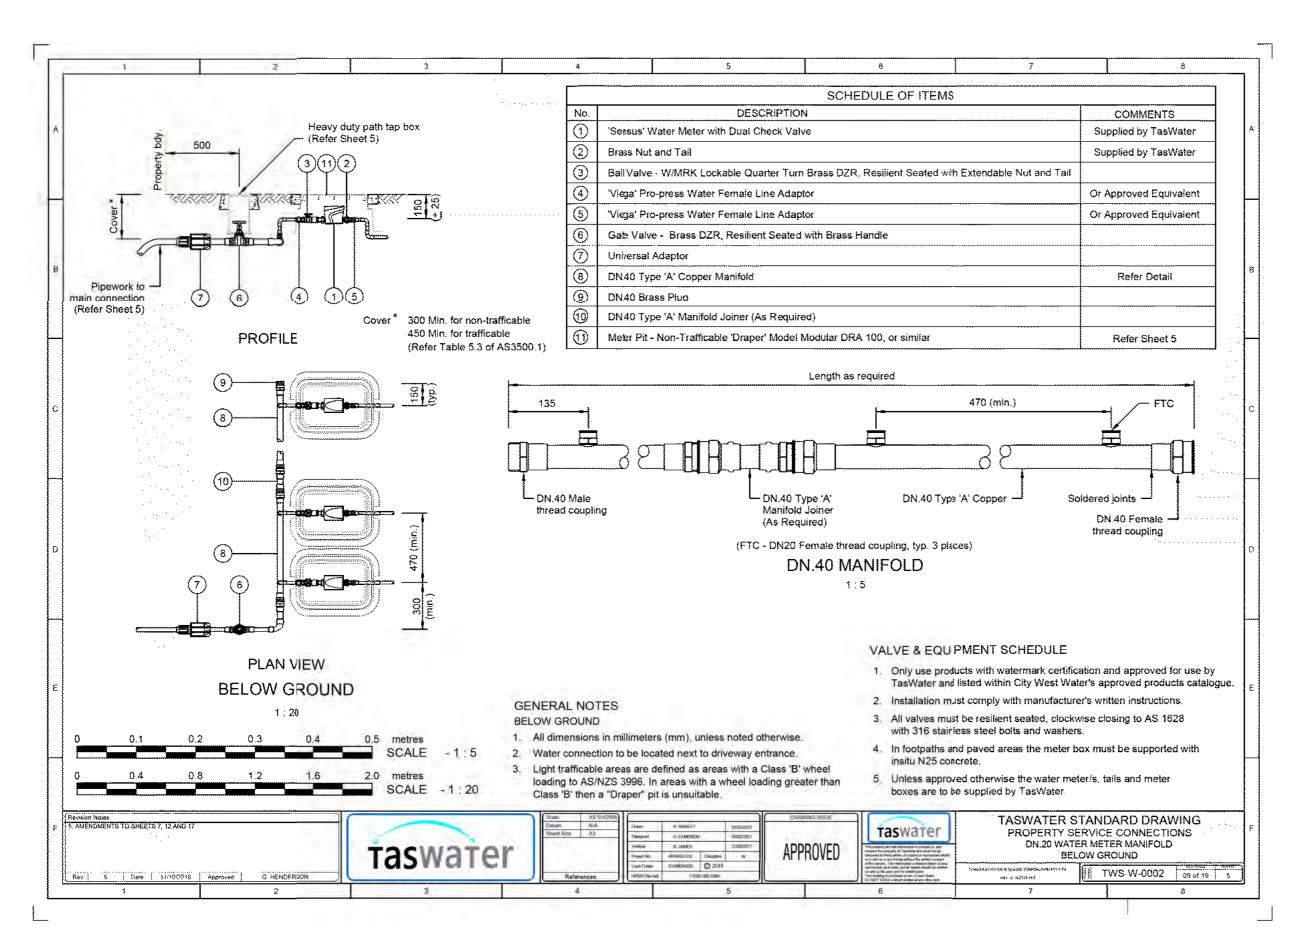
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H1346 DA 150 PC

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Pocument Set ID: 5712079 Version: 1, Version Date: 07/10/2025





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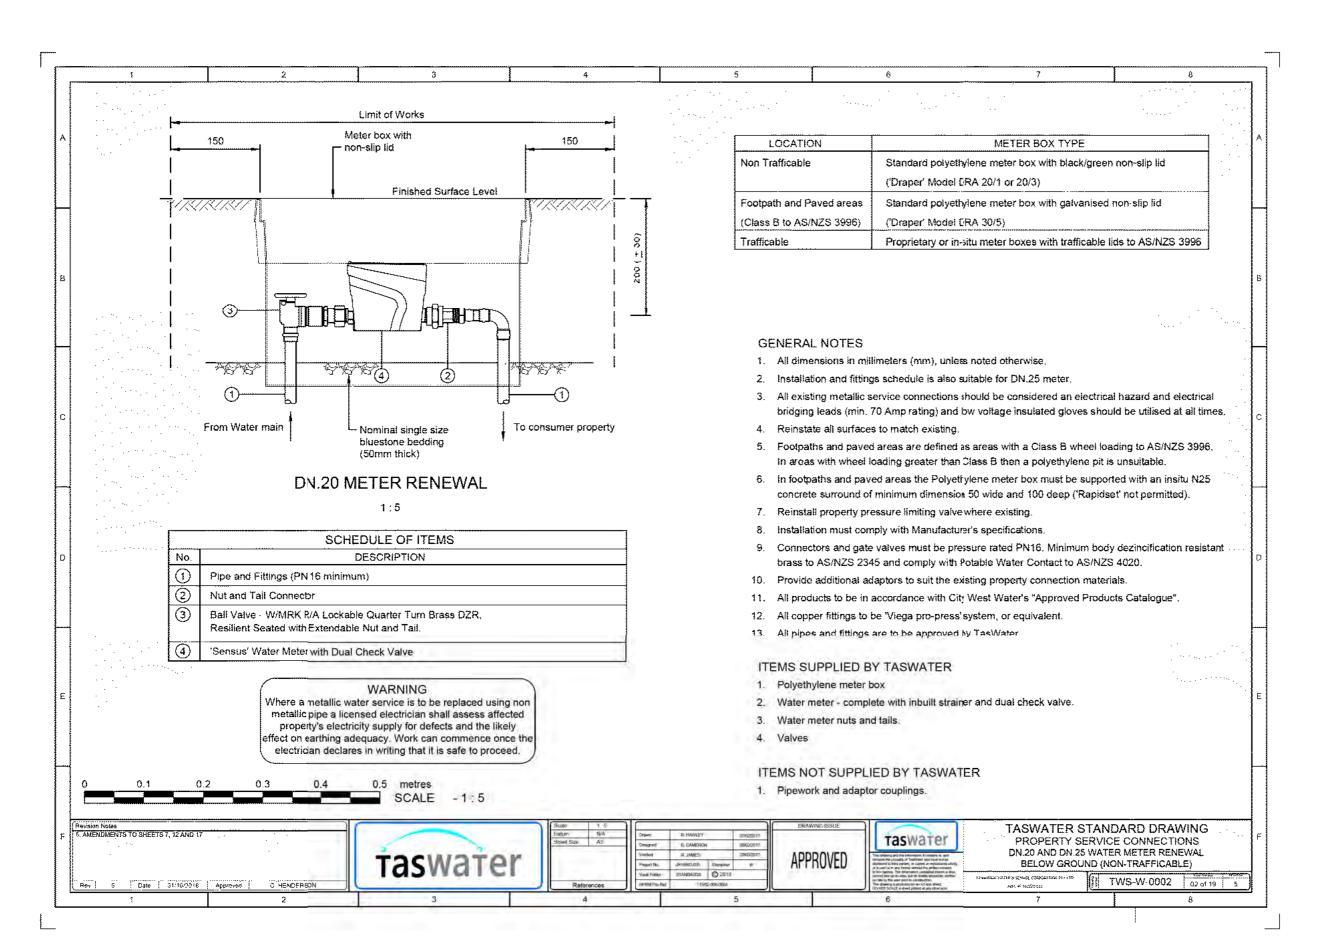
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TasWater METER MANIFOLD DETAIL 22/07/25

NAME: H1346 DA 150525.dgn WN BY: PC



PROPOSED UNIT DEVELOPMENT FOR TASSIE HOMES AT 116 DOLINA DRIVE, ROKEBY

TASSIE HOMES

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TasWater NON-TRAFFICABLE BOX FOR WATER METER DETAIL 22/07/25

H1346 DA 150525.dgn


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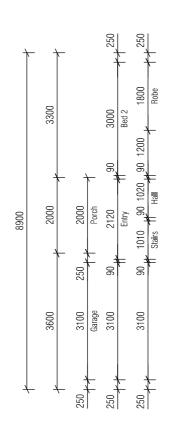
NOT TO SCALE


PLEASE NOTE: no variations will be permitted after plans are signed by the client (with exception of Council requirements / approvals). SIGNATURE:


DATE:

Lower Floor Area = 77.6m² Upper Floor Area = 77.0m² Total Floor Area = 154.6m² Alfresco Area = 16.7m² Porch Area = $2.0m^2$



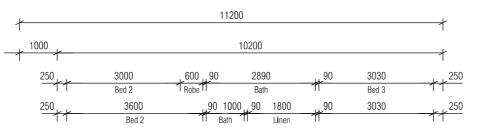

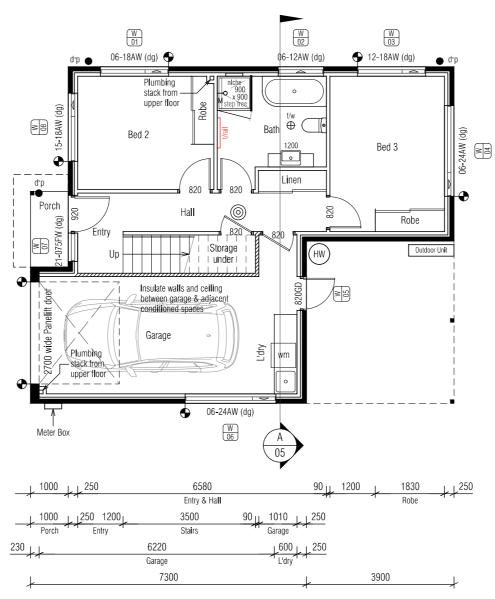

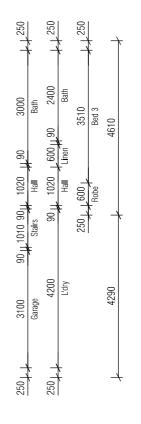

REVISION

В

D

DATE

11 Ju**l**y 2025

15 Ju**l**y 2025


11 September 2025

DESCRIPTION

Changes as described on Cover Sheet

Changes as described on Cover Sheet

Changes as described on Cover Sheet

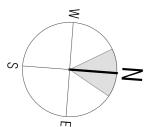

Scale 1:100

Version: 1, Version Date: 07/10/2025

Document Set ID: 5712079

PROPOSED UNIT DEVELOPMENT FOR TASSIE HOMES AT 116 DOLINA DRIVE, ROKEBY

BAL-12.5

See sheet 27 for Bushfire Attack Level construction requirements

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TASSIE HOMES

Unit 4/37 Ascot Drive, Huntingfield, Tasmania. 7055

www.tassiehomes.com.au

Ph. (03) 62 833 273

DWG No:


03

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DATE:

Lower Floor Area = 77.7m² Upper Floor Area = 77.0m² Total Floor Area = 154.7m² Alfresco Area = 17.4m² Porch Area = $2.0m^2$



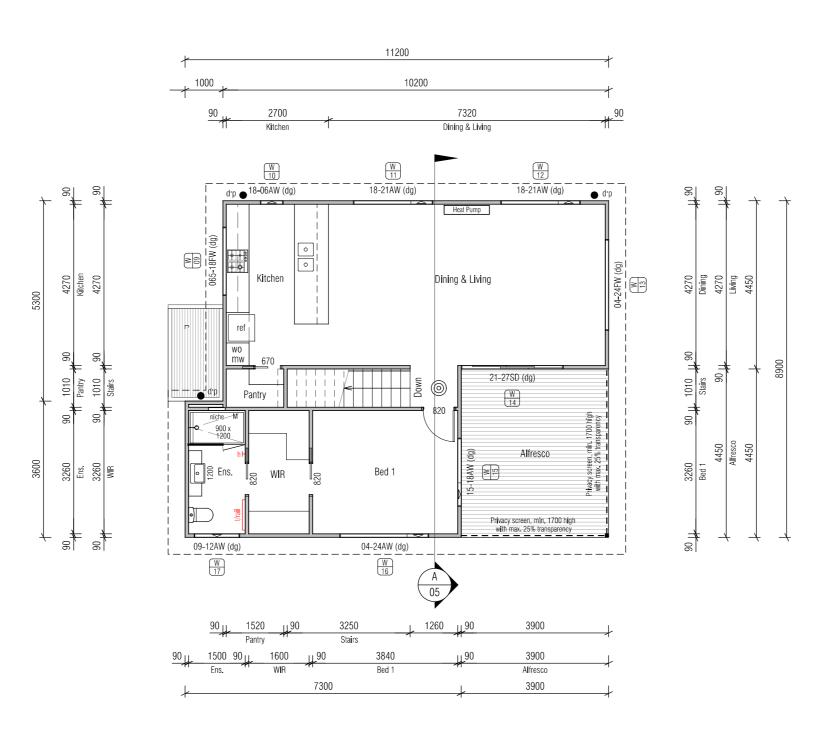

BAL-12.5

See sheet 27 for Bushfire Attack Level construction requirements

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DRAWING: DATE: FILE NAME: DRAWN BY

REVISION

В

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DATE

11 Ju**l**y 2025

15 Ju**l**y 2025

11 September 2025

DESCRIPTION

Changes as described on Cover Sheet

Changes as described on Cover Sheet

Changes as described on Cover Sheet


UNIT 1 UPPER FLOOR PLAN 11/09/25 H1346 DA 150525.dgn PC

PROPOSED UNIT DEVELOPMENT FOR TASSIE HOMES AT 116 DOLINA DRIVE, ROKEBY

03a DWG No:

Document Set ID: 5712079 Version: 1, Version Date: 07/10/2025

Scale 1:100

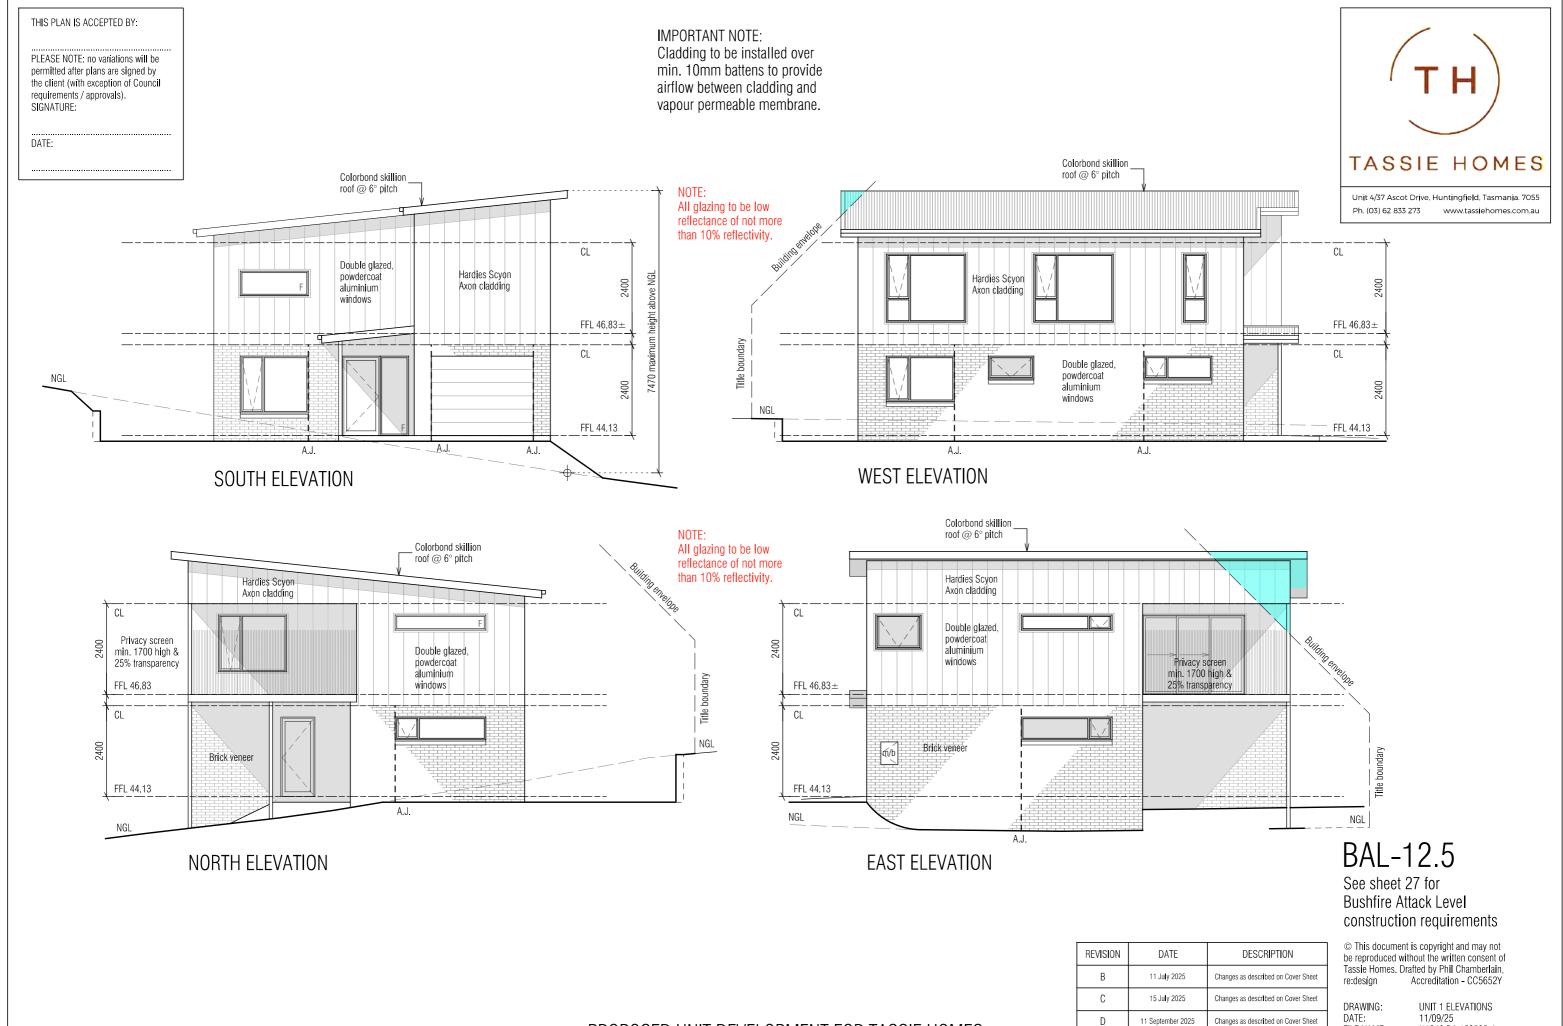

PROPOSED UNIT DEVELOPMENT FOR TASSIE HOMES AT 116 DOLINA DRIVE, ROKEBY

DATE: FILE NAME:

11/09/25 H1346 DA 150525.dgn

04

DRAWN BY:

DWG No:

Scale 1:100

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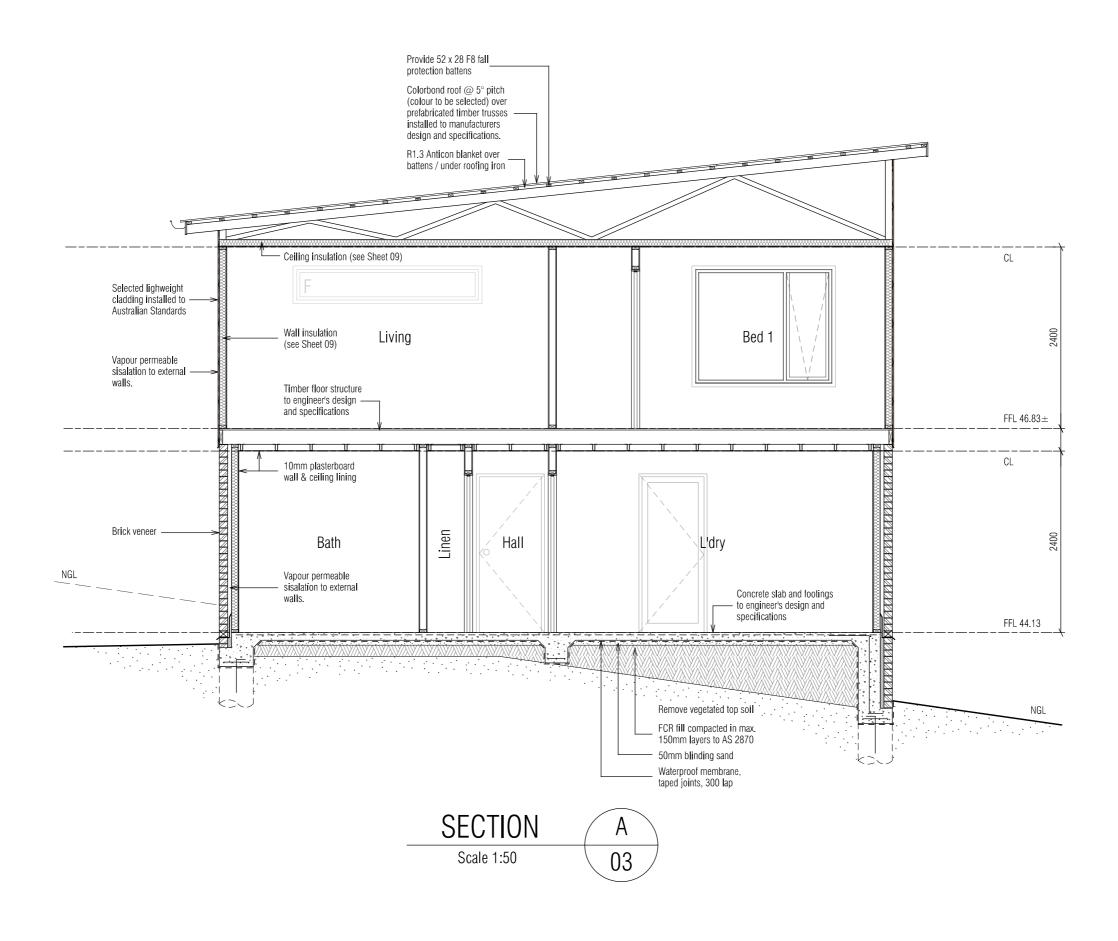
PLEASE NOTE: no variations will be permitted after plans are signed by the client (with exception of Council requirements / approvals).

SIGNATURE:

DATE:

IMPORTANT NOTE:

Cladding to be installed over min. 10mm battens to provide airflow between cladding and vapour permeable membrane.



PROPOSED UNIT DEVELOPMENT FOR TASSIE HOMES AT 116 DOLINA DRIVE, ROKEBY



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05

PC

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Scale 1:100


ROOF VENTILATION CALCULATIONS (Roof 'B' ? ° skillion roof)

200 x 400 eaves vents (0.08m²) Ceiling area = $? m^2 / 150 = 0.000 m^2$ 30% of 0.000 $m^2 = 0.000 m^2$

 $0.000 \text{ m}^2 / 0.08 \text{m}^2 = ? (x 2) = ? \text{ ridge vents}$ 70% of 0.000 $m^2 = 0.000 m^2$

 $0.000 \text{ m}^2 / 0.08 \text{m}^2 = ? (x 2) = ? \text{ eaves vents}$ 200 x 400 ridge vent (50% opening)

EV 200 x 400 eaves vent (50% opening)

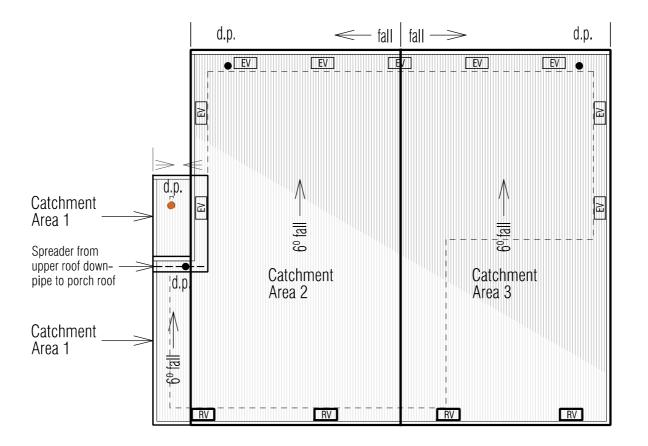

| DOWNP | DOWNPIPE & ROOF CATCHMENT AREA CALCULATIONS (as per NCC Part 3.5.2) | |
|--|--|---|
| Ah | Ah 117.3 Area of roof (including 115mm Quad Gutter) (m²) | |
| Ac | 123.2 | Ah x slope factor (determined from Table 3.2 from AS/NZS 3500.3) (m²) |
| Gutter type | Gutter type A Cross sectional area 6500mm² (determined from NCC Table 3.5.2.2) | |
| DRI | DRI 85 Design Rainfall Intensity Hobart (determined from NCC Table 3.5.2.1) | |
| Acdp 70 Catchment area per 90mm downpipe (determined from NCC Table 3.5.2.2) | | |
| Downpipes Required | 2 | Ac Acdp |
| Downpipes Provided | 4 | |

PROPOSED UNIT DEVELOPMENT FOR TASSIE HOMES AT 116 DOLINA DRIVE, ROKEBY

Document Set ID: 5712079 Version: 1, Version Date: 07/10/2025



CATCHMENT AREA NOTES: Skillion roof @ 6° pitch CATCHMENT AREA $1 = 8.5 \text{m}^2$ CATCHMENT AREA $2 = 57.8 \text{m}^2$

CATCHMENT AREA $3 = 57.8 \text{m}^2$

denotes roof area

denotes downpipe

denotes direction of fall

denotes 200 x 400 ridge vent

denotes 200 x 400 eaves vent

IMPORTANT NOTES:

The position and quantity of downpipes are not to be altered without consulting with designer. Areas shown are surface / catchment areas NOT plan areas.

All roof areas shown are indicative only and not to be used for any other purpose.

Roof space must be vented. Eave vents must be fitted to the soffit with BAL compliant, non-combustible ember mesh installed. Vents must be in accordance with the NCC, BCA 2022, Volume 2, Part 10.8.3 'Ventilation of Roof Spaces' and AS 3959.

BAL-12.5

See sheet 27 for Bushfire Attack Level construction requirements

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UNIT 1 ROOF PLAN 24/07/25 H1346 DA 150525.dgn

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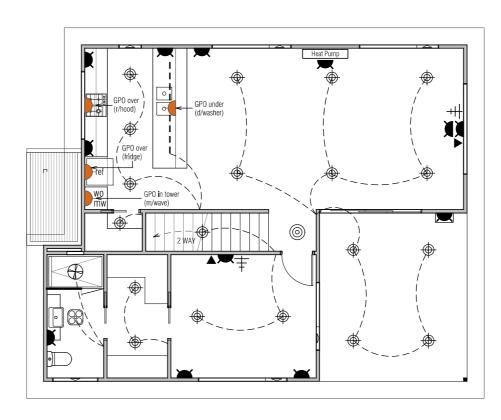
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Sensor Se

LOWER FLOOR ELECTRICAL PLAN



UPPER FLOOR ELECTRICAL PLAN



Fluorescent light (19 W)

Wall light (28W)

--- LED strip light

Ducted exhaust fan

LED spotlight (sensor)

4-light Tastic (10W centre light only)

Pendant light (28W)

LED downlight (12W)

Single GPO

Double GP0

Double GPO (exterior)

Smoke alarm

Phone / NBN point

± TV point

■ Data point

IMPORTANT NOTES:

Smoke alarms are to be installed in accordance with the NCC 9.5. Smoke alarms are to be interconnected where more than one alarm is installed.

Toilet & bathroom fans to be min. 25L/s and to be ducted directly to outside where possible. Kitchen & laundry fans to be min. 40L/s and to be ducted directly to outside where possible. All downlights are to be sealed and IC-F rated.

BAL-12.5

See sheet 27 for Bushfire Attack Level construction requirements

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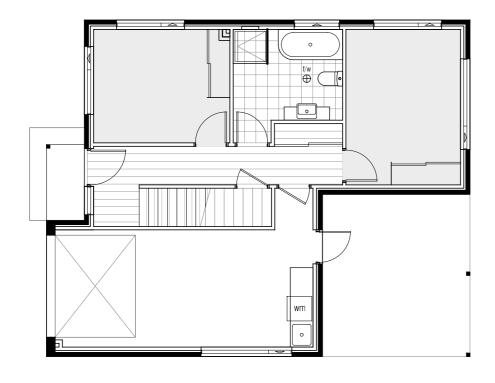
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DWG No:

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FLOORING LEGEND Floating Flooring Carpet Tiles

LOWER FLOORING PLAN

UPPER FLOORING PLAN

BAL-12.5

See sheet 27 for Bushfire Attack Level construction requirements

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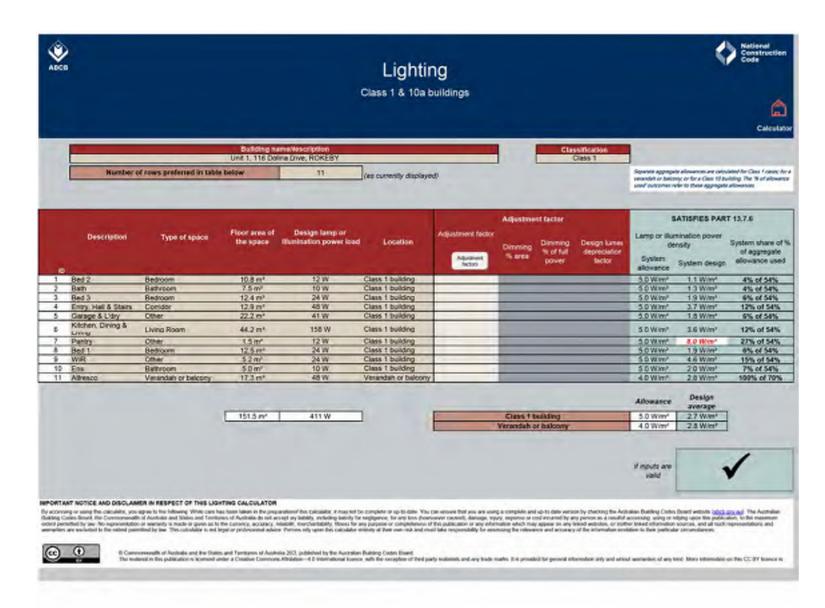
UNIT 1 FLOORING LAYOUT PLAN 22/07/25 H1346 DA 150525.dgn PC

80





LIGHTING CALCULATIONS



(iii) 3W per m2 in a Class 10a building associated

* The illumination power density allowance must be

increased by dividing it by the illumination power

density adjustment factor for a control device as

with a Class 1 building.

per BCA 2014 Table 3.12.5.3.

WINDOW SCHEDULE

| Window Number | Туре | ID | Size | Glass | Uw | SHGO |
|------------------|------|------------|--------|--------|------|------|
| W01 | AW | AWS-008-01 | 06-18 | Grey | 4.30 | 0.55 |
| W02 | AW | AWS-008-01 | 06-12 | Opaque | 4.30 | 0.55 |
| W03 | AW | AWS-008-01 | 12-18 | Grey | 4.30 | 0.55 |
| W04 | AW | AWS-008-01 | 06-24 | Grey | 4.30 | 0.55 |
| W05 | FD | AWS-019-01 | 21-09 | Grey | 4.10 | 0.50 |
| W06 | AW | AWS-008-01 | 06-24 | Opaque | 4.30 | 0.55 |
| W07 | FW | AWS-067-08 | 21-075 | Grey | 3.20 | 0.68 |
| W08 | AW | AWS-008-01 | 15-18 | Grey | 4.30 | 0.55 |
| W09 | FW | AWS-067-08 | 065-18 | Grey | 3.20 | 0.68 |
| W10 | AW | AWS-008-01 | 18-06 | Grey | 4.30 | 0.55 |
| W11 | AW | AWS-008-01 | 18-21 | Grey | 4.30 | 0.55 |
| W12 | AW | AWS-008-01 | 18-21 | Grey | 4.30 | 0.55 |
| W13 | FW | AWS-067-08 | 04-24 | Grey | 3.20 | 0.68 |
| W14 | SD | AWS-013-01 | 21-27 | Grey | 4.00 | 0.61 |
| W15 | AW | AWS-008-01 | 15-18 | Grey | 4.30 | 0.55 |
| W16 | AW | AWS-008-01 | 04-24 | Clear | 4.30 | 0.55 |
| W17 | AW | AWS-008-01 | 09-12 | Opaque | 4.30 | 0.55 |

SW = Sliding window, AW = Awning window, FW = Fixed window, SD = Sliding door, BF = Bj-fold Door or Window, FD = French door, TW = Transom Window

Windows supplied MUST HAVE Uw, SHGC & Air infiltration performance values EQUAL TO or

NOTE:

All glazing to be low reflectance of not more than 10% reflectivity.

INSULATION

| INSULATION SCHEDULE | | |
|---------------------|---|--|
| AREA | INSULATION DETAILS | |
| Roof | R1.3 anticon blanket under iron / over battens. | |
| Ceiling | R4.0 bulk insulation (or equivalent). | |
| Walls (external) | R2.0 bulk insulation (or equivalent) with 1 layer of vapour permeable sisalation. | |
| Walls (internal) | R2.0 bulk insulation (or equivalent) to all internal walls adjoining unconditioned spaces. | |
| Floors | R2.0 bulk insulation (or equivalent) to all timber floors above sub-floor and other unconditioned spaces below. | |
| | | |

Clearance is required for uncompressed installation of bulk insulation and timbers should be sized accordingly,

210mm for R4.0 bulk insulation, 240mm for R4.0 bulk insulation; 260mm for R4.0 bulk insulation.

These dimensions are nominal and may vary depending on the type of insulation to be installed.

BAL-12.5

See sheet 27 for Bushfire Attack Level construction requirements

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DATE:

UNIT 1 LIGHTING CALCULATIONS, INSULATION & WINDOW SCHEDULE 11/09/25 FILE NAME: DRAWN BY:

H1346 DA 150525.dan

DWG No:

REVISION DATE DESCRIPTION 11 September 2025 Changes as described on Cover Sheet

PROPOSED UNIT DEVELOPMENT FOR TASSIE HOMES AT 116 DOLINA DRIVE, ROKEBY

Document Set ID: 5712079

Version: 1, Version Date: 07/10/2025

3.12.5.5 - ARTIFICIAL LIGHTING

must not exceed the allowance of:

eave perimeter lights);

(i) 5W per m² in Class 1 building;

* Lamp power density or illumination power density of

artificial lighting, excluding heaters that emit light,

(ii) 4W per m2 on a verandah, balcony or the like

attached to a Class 1 building (not including

BETTER THAN those specified above.


* Glass specification may change to comply with BAL requirements (Refer to sheet 27)

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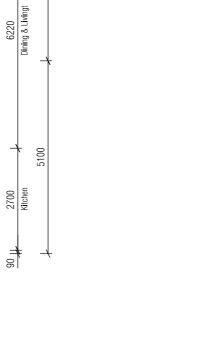
DATE:

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Upper Floor Area = 96.2m² Lower Floor Area = 47.1m² Total Floor Area = 143.3m² Deck & Steps Area = 14.2m² Porch Area = 2.1m²





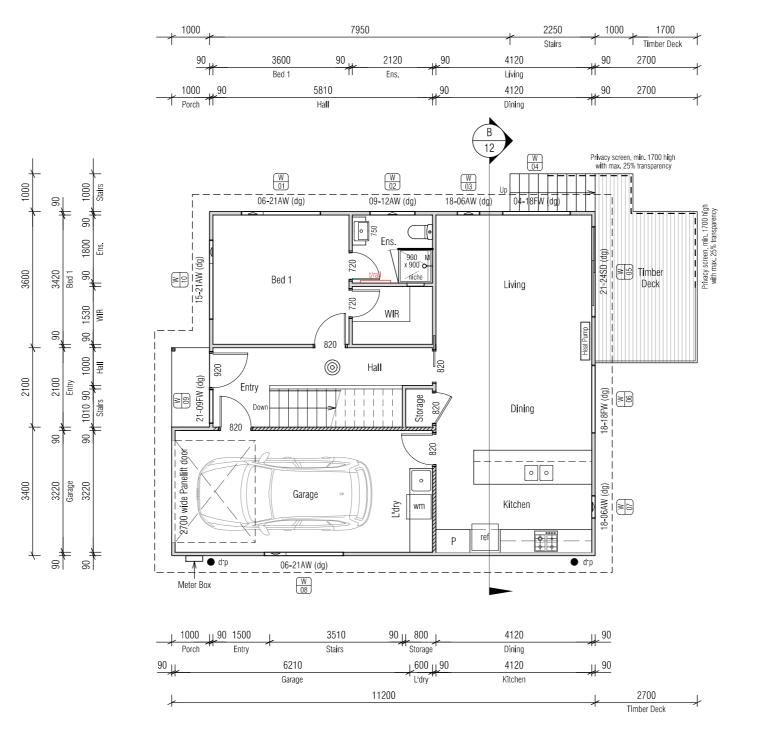

1000 Stairs


96

1000 H 90 1530 Hall WIR

90 1010 90

3220 L'dry

86

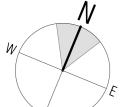

Scale 1:100

PROPOSED UNIT DEVELOPMENT FOR TASSIE HOMES AT 116 DOLINA DRIVE, ROKEBY

| REVISION | DATE | DESCRIPTION | |
|----------|-------------------|-------------------------------------|--|
| А | 8 July 2025 | Changes as described on Cover Sheet | |
| В | 11 July 2025 | Changes as described on Cover Sheet | |
| С | 15 July 2025 | Changes as described on Cover Sheet | |
| D | 11 September 2025 | Changes as described on Cover Sheet | |

BAL-12.5 See sheet 27 for Bushfire Attack Level

construction requirements

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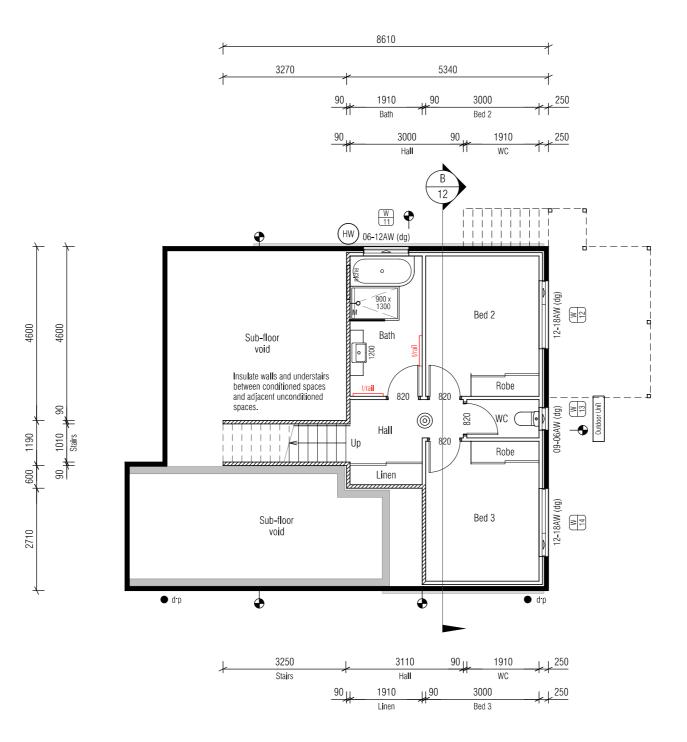
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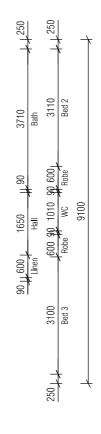
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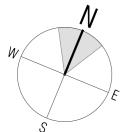
DATE:

Upper Floor Area = 96.2m² Lower Floor Area = 47.1m² Total Floor Area = 143.3m² Deck & Steps Area = 14.2m² Porch Area $= 2.1 \text{m}^2$









Scale 1:100

Version: 1, Version Date: 07/10/2025

Document Set ID: 5712079

PROPOSED UNIT DEVELOPMENT FOR TASSIE HOMES AT 116 DOLINA DRIVE, ROKEBY

| REVISION | DATE | DESCRIPTION |
|----------|-------------------|-------------------------------------|
| А | 8 July 2025 | Changes as described on Cover Sheet |
| В | 11 July 2025 | Changes as described on Cover Sheet |
| С | 15 July 2025 | Changes as described on Cover Sheet |
| D | 11 September 2025 | Changes as described on Cover Sheet |

BAL-12.5 See sheet 27 for

Bushfire Attack Level construction requirements

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10a


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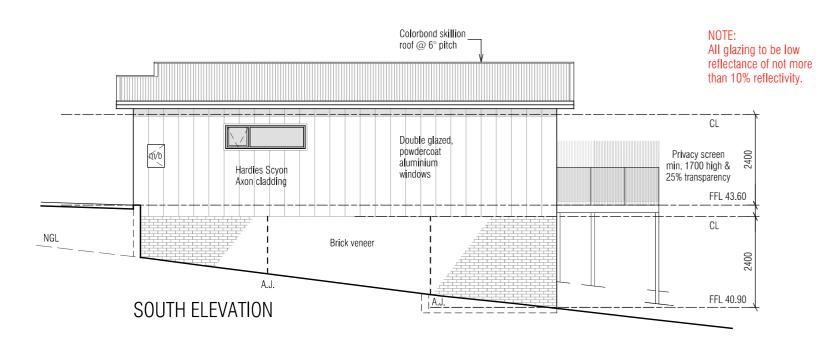
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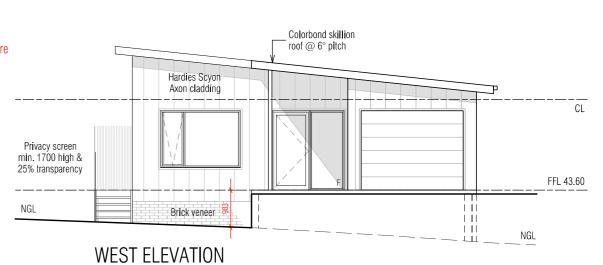
DATE:

IMPORTANT NOTE: Cladding to be installed over min. 10mm battens to provide airflow between cladding and vapour permeable membrane.







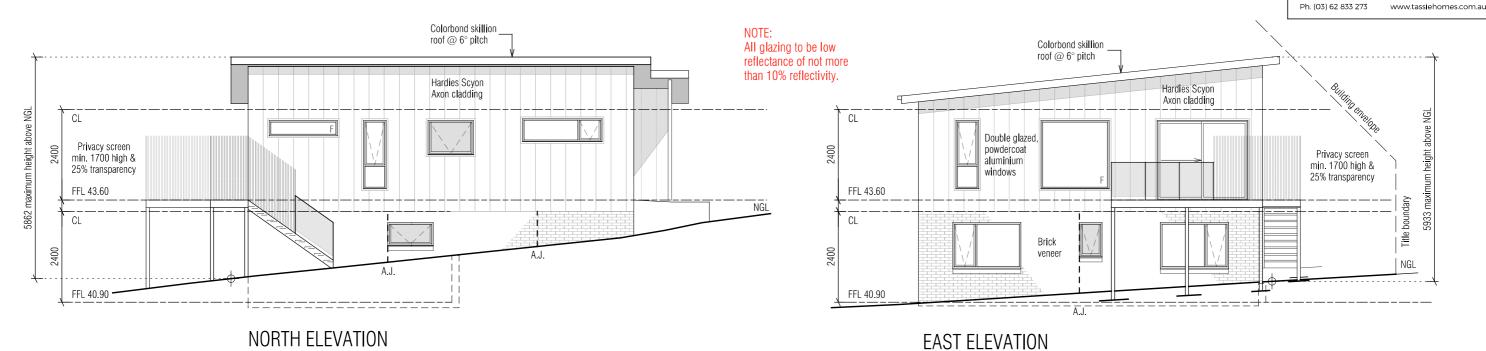

BAL-12.5

See sheet 27 for Bushfire Attack Level construction requirements

| REVISION | DATE | DESCRIPTION |
|---|---|-------------------------------------|
| A 8 July 2025 Changes as described on Cover 9 | | Changes as described on Cover Sheet |
| В | 11 July 2025 Changes as described on Cover Sh | |
| С | 15 July 2025 | Changes as described on Cover Sheet |
| D | 11 September 2025 | Changes as described on Cover Sheet |

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H1346 DA 150525. C: PC

DWG No:

Scale 1:100


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DATE:

IMPORTANT NOTE:

Cladding to be installed over min. 10mm battens to provide airflow between cladding and vapour permeable membrane.



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UNIT 2 SECTION 22/07/25 H1346 DA 150525.dgn

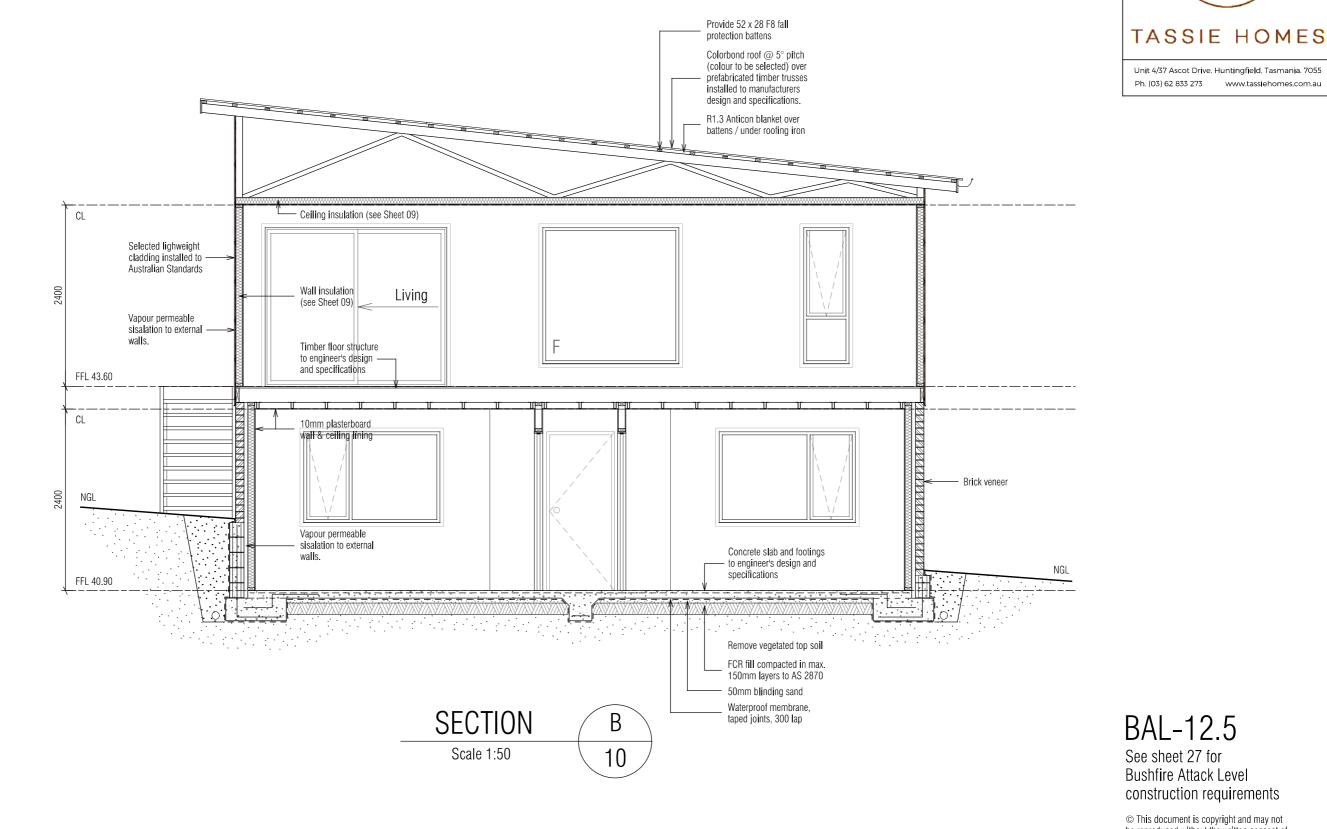Unit 4/37 Ascot Drive, Huntingfield, Tasmania. 7055

Ph. (03) 62 833 273 www.tassiehomes.com.au

DWG No:

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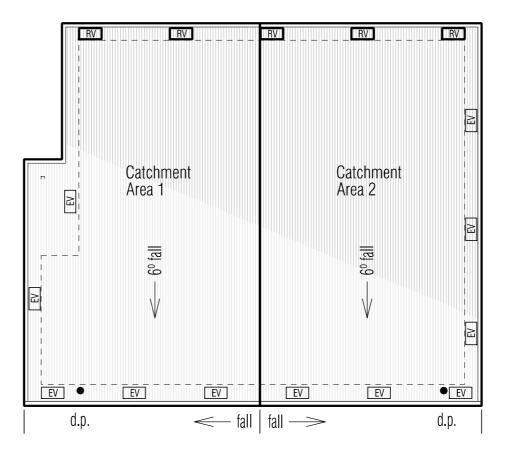
DATE:

Scale 1:100

ROOF VENTILATION CALCULATIONS (6° skillion roof)

200 x 400 eaves vents (0.08m²) Ceiling area = $92.6m^2 / 150 = 0.617m^2$ 30% of $0.617m^2 = 0.185m^2$ $0.185m^2 / 0.08m^2 = 2.3$ (x 2) = 5 ridge vents 70% of $0.617m^2 = 0.432m^2$ $0.432m^2 / 0.08m^2 = 5.4$ (x 2) = 11 eaves vents 200 x 400 ridge vent (50% opening)

EV 200 x 400 eaves vent (50% opening)



| DOWNP | IPE & ROO | F CATCHMENT AREA CALCULATIONS (as per NCC Part 3.5.2) |
|-----------------------|-----------|--|
| Ah | 118.9 | Area of roof (including 115mm Quad Gutter) (m²) |
| Ac | 124.8 | Ah x slope factor (determined from Table 3.2 from AS/NZS 3500.3) (m²) |
| Gutter type | А | Cross sectional area 6500mm ² (determined from NCC Table 3.5.2.2) |
| DRI | 85 | Design Rainfall Intensity Hobart (determined from NCC Table 3.5.2.1) |
| Acdp | 70 | Catchment area per 90mm downpipe (determined from NCC Table 3.5.2.2) |
| Downpipes Required | 2 | Ac Acdp |
| Downpipes Provided | 2 | |

PROPOSED UNIT DEVELOPMENT FOR TASSIE HOMES AT 116 DOLINA DRIVE, ROKEBY

TASSIE HOMES

Unit 4/37 Ascot Drive, Huntingfield, Tasmania. 7055
Ph. (03) 62 833 273 www.tassiehomes.com.au

CATCHMENT AREA NOTES: Skillion roof @ 6° pitch CATCHMENT AREA 1 = 62.5m² CATCHMENT AREA 2 = 62.4m²

denotes roof area

d.p. denotes downpipe

denotes direction of fall

denotes 200 x 400 ridge vent

denotes 200 x 400 eaves vent

IMPORTANT NOTES:

The position and quantity of downpipes are not to be altered without consulting with designer. Areas shown are surface / catchment areas NOT plan areas.

All roof areas shown are indicative only and not to be used for any other purpose. Roof space must be vented. Eave vents must be

fitted to the soffit with BAL compliant, non-combustible ember mesh installed. Vents must be in accordance with the NCC, BCA 2022, Volume 2, Part 10.8.3 'Ventilation of Roof Spaces' and AS 3959.

BAL-12.5

See sheet 27 for Bushfire Attack Level construction requirements

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13

PC


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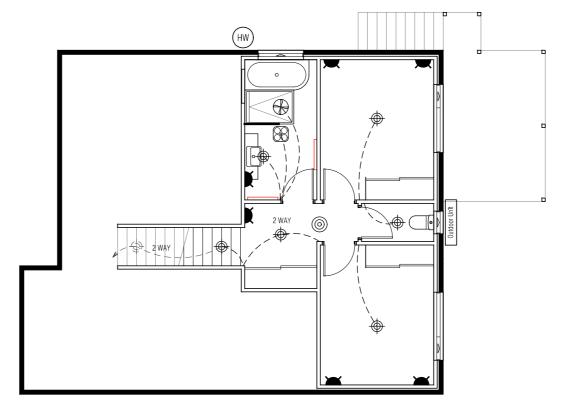
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LOWER FLOOR ELECTRICAL PLAN



Fluorescent light (19 W)

Wall light (28W)

--- LED strip light

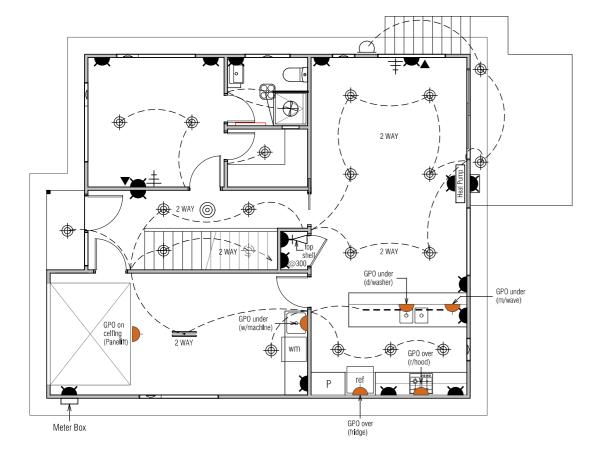Ducted exhaust fan

LED spotlight (sensor)

4-light Tastic (10W centre light only)

Pendant light (28W)

LED downlight (12W)

Single GPO

Double GPO

Double GPO (exterior)

Smoke alarm

Mark Phone / NBN point

± TV point

■ Data point

IMPORTANT NOTES:

Smoke alarms are to be installed in accordance with the NCC 9.5. Smoke alarms are to be interconnected where more than one alarm is installed.

Toilet & bathroom fans to be min. 25L/s and to be ducted directly to outside where possible. Kitchen & laundry fans to be min. 40L/s and to be ducted directly to outside where possible. All downlights are to be sealed and IC-F rated.

BAL-12.5

See sheet 27 for Bushfire Attack Level construction requirements

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14

H1346 DA 150 PC


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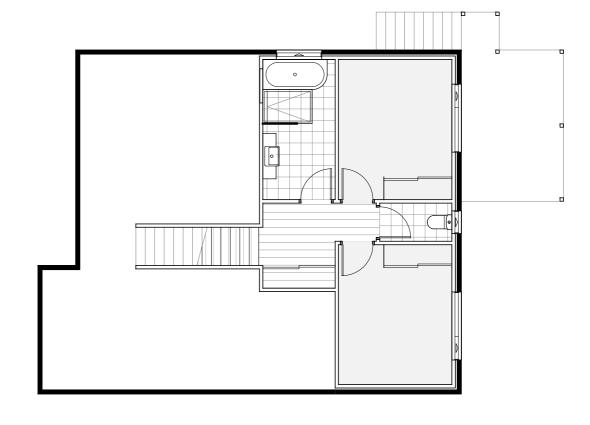
requirements / approvals). SIGNATURE:

DATE:






UPPER FLOORING PLAN

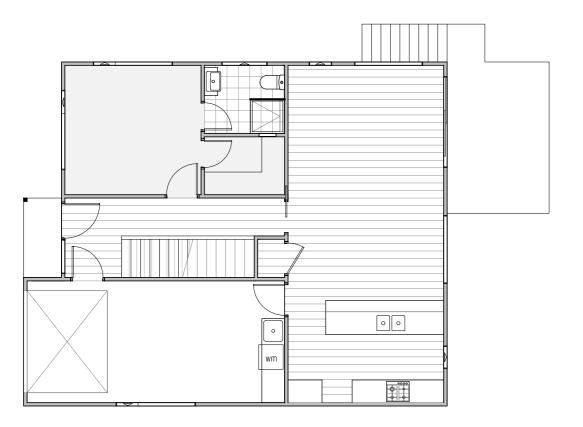

LOWER FLOORING PLAN

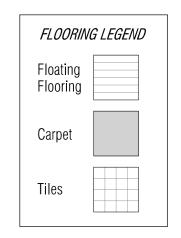

BAL-12.5

See sheet 27 for Bushfire Attack Level construction requirements

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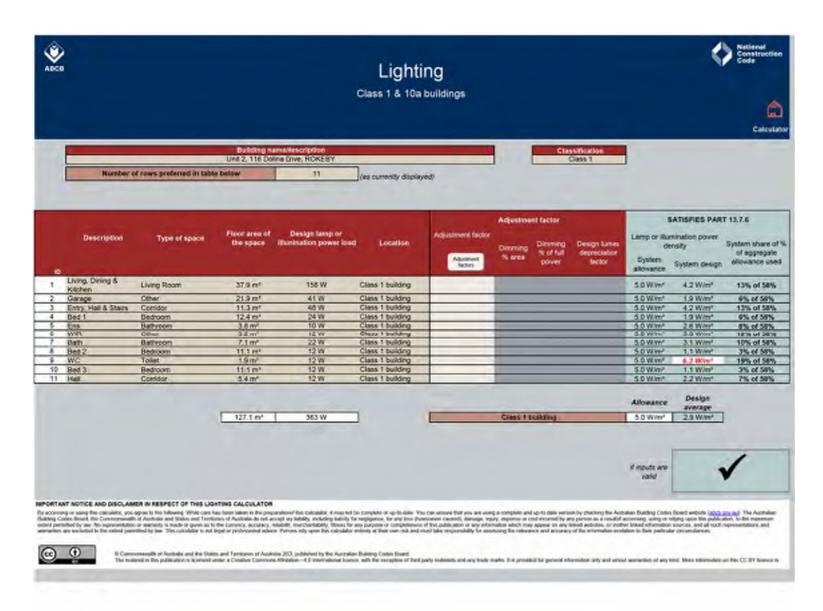
DWG No:

UNIT 2 FLOORING LAYOUT PLAN 25/07/25 H1346 DA 150525.dgn PC





LIGHTING CALCULATIONS



(iii) 3W per m2 in a Class 10a building associated

* The illumination power density allowance must be

increased by dividing it by the illumination power

density adjustment factor for a control device as

with a Class 1 building.

per BCA 2014 Table 3.12.5.3.

WINDOW SCHEDULE

| Window Number | Туре | ID | Size | Glass | Uw | SHG |
|------------------|------|------------|-------|--------|------|------|
| W01 | AW | AWS-008-01 | 06-21 | Grey | 4.30 | 0.55 |
| W02 | AW | AWS-008-01 | 09-12 | Opaque | 4.30 | 0.55 |
| W03 | AW | AWS-008-01 | 18-06 | Grey | 4.30 | 0.55 |
| W04 | FW | AWS-067-08 | 04-18 | Grey | 3.20 | 0.68 |
| W05 | SD | AWS-013-01 | 21-24 | Grey | 4.00 | 0.61 |
| W06 | FW | AWS-067-08 | 18-18 | Grey | 3.20 | 0.68 |
| W07 | AW | AWS-008-01 | 18-06 | Grey | 4.30 | 0.55 |
| W08 | AW | AWS-008-01 | 06-21 | Grey | 4.30 | 0.55 |
| W09 | FW | AWS-067-08 | 21-09 | Grey | 3.20 | 0.68 |
| W10 | AW | AWS-008-01 | 15-21 | Grey | 4.30 | 0.55 |
| W11 | AW | AWS-008-01 | 06-12 | Opaque | 4.30 | 0.55 |
| W12 | AW | AWS-008-01 | 12-18 | Grey | 4.30 | 0.55 |
| W13 | AW | AWS-008-01 | 09-06 | Opaque | 4.30 | 0.55 |
| W14 | AW | AWS-008-01 | 12-18 | Grey | 4.30 | 0.55 |

 $SW = Sliding \ window, \ AW = Awning \ window, \ FW = Fixed \ window, \ SD = Sliding \ door, \ BF = Bi-fold \ Door \ or \ Window, \ FD = French \ door, \ TW = Transom \ Window$

Windows supplied MUST HAVE Uw, SHGC & Air infiltration performance values EQUAL TO or BETTER THAN those specified above.

* Glass specification may change to comply with BAL requirements (Refer to sheet 27)

NOTE:

All glazing to be low reflectance of not more than 10% reflectivity.

REVISION

DATE

11 September 2025

INSULATION

| INSULATION SCHEDULE | | | | | |
|-------------------------|---|--|--|--|--|
| AREA INSULATION DETAILS | | | | | |
| Roof | R1.3 anticon blanket under iron / over battens. | | | | |
| Ceiling | R4.0 bulk insulation (or equivalent). | | | | |
| Walls (external) | R2.0 bulk insulation (or equivalent) with 1 layer of vapour permeable sisalation. | | | | |
| Walls (internal) | R2.0 bulk insulation (or equivalent) to all internal walls adjoining unconditioned spaces. | | | | |
| Floors | R2.0 bulk insulation (or equivalent) to all timber floors above sub-floor and other unconditioned spaces below. | | | | |

DESCRIPTION

Changes as described on Cover Sheet

Clearance is required for uncompressed installation of bulk insulation and timbers should be sized accordingly,

210mm for R4.0 bulk insulation; 240mm for R4.0 bulk insulation; 260mm for R4.0 bulk insulation.

These dimensions are nominal and may vary depending on the type of insulation to be installed.

BAL-12.5

See sheet 27 for Bushfire Attack Level construction requirements

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DWG No:

UNIT 2 LIGHTING CALCULATIONS, INSULATION & WINDOW SCHEDULE 11/09/25 H1346 DA 150525.dgn

16

Accreditation - CC5652Y re:design

| PROPOSED UNIT DEVELOPMENT FOR TASSIE HOMES |
|--|
| AT 116 DOLINA DRIVE, ROKEBY |

Version: 1, Version Date: 07/10/2025

3.12.5.5 - ARTIFICIAL LIGHTING

must not exceed the allowance of:

eave perimeter lights);

(i) 5W per m² in Class 1 building;

* Lamp power density or illumination power density of

artificial lighting, excluding heaters that emit light,

(ii) 4W per m2 on a verandah, balcony or the like


attached to a Class 1 building (not including


PLEASE NOTE: no variations will be permitted after plans are signed by the client (with exception of Council requirements / approvals). SIGNATURE:

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.....

Upper Floor Area = 96.2m² Lower Floor Area = 47.1m² Total Floor Area = 143.3m² Deck & Steps Area = 15.6m² Porch Area = 2.1m²



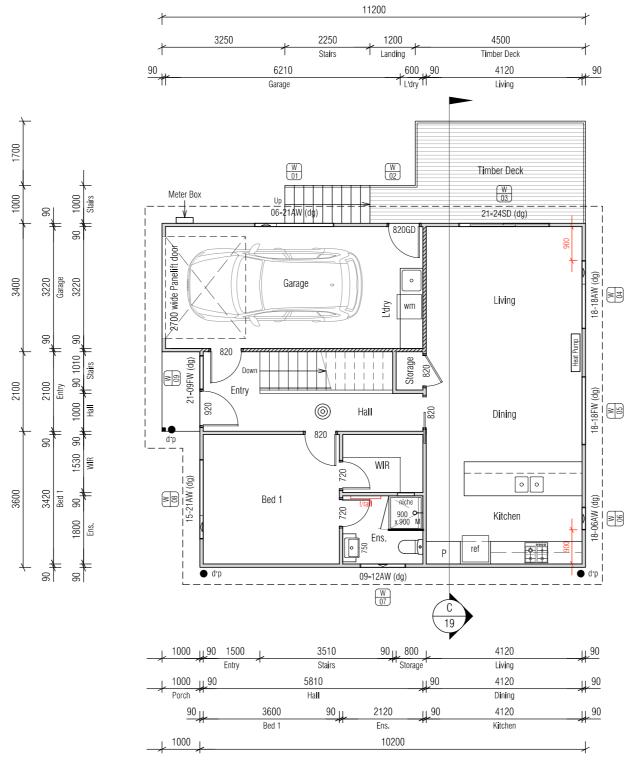
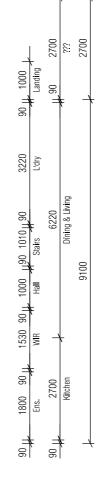
| REVISION | DATE | DESCRIPTION |
|----------|-------------------|-------------------------------------|
| А | 8 July 2025 | Changes as described on Cover Sheet |
| В | 11 July 2025 | Changes as described on Cover Sheet |
| С | 15 July 2025 | Changes as described on Cover Sheet |
| D | 11 September 2025 | Changes as described on Cover Sheet |

BAL-12.5

TASSIE HOMES

Unit 4/37 Ascot Drive, Huntingfield, Tasmania. 7055

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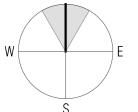
See sheet 27 for Bushfire Attack Level construction requirements

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ИЕ: Н13 ВҮ: РС

PROPOSED UNIT DEVELOPMENT FOR TASSIE HOMES AT 116 DOLINA DRIVE, ROKEBY



Scale 1:100


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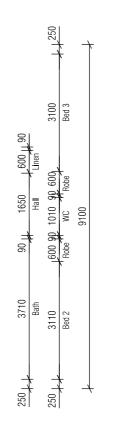
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| REVISION | DATE | DESCRIPTION |
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| А | 8 July 2025 | Changes as described on Cover Sheet |
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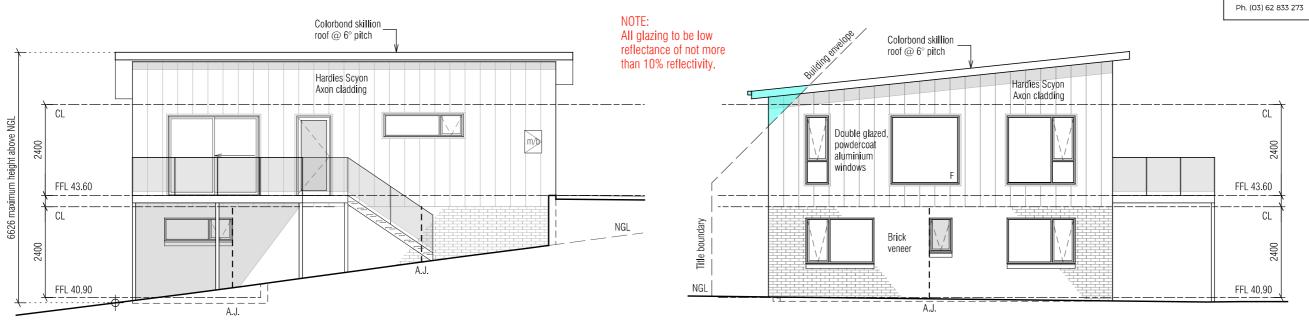
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IMPORTANT NOTE: Cladding to be installed over min. 10mm battens to provide airflow between cladding and vapour permeable membrane.




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NORTH ELEVATION

EAST ELEVATION

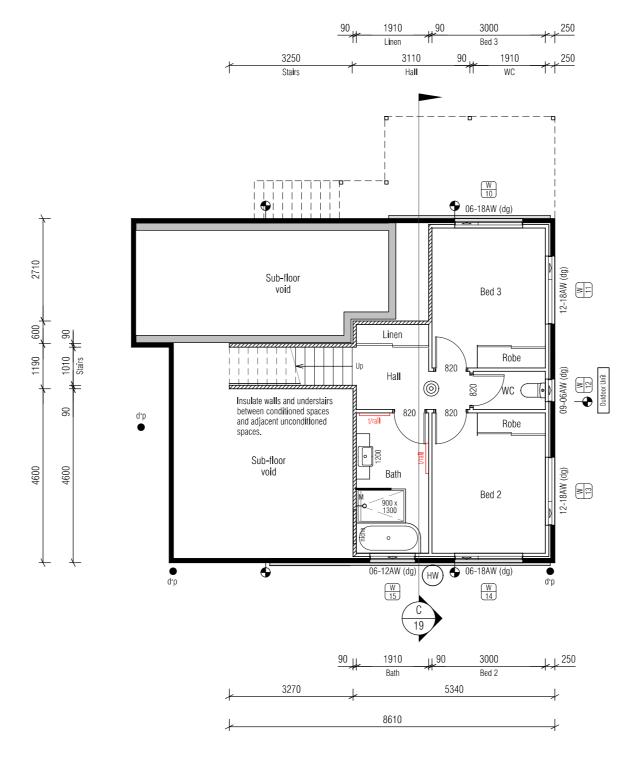

REVISION DATE DESCRIPTION 8 July 2025 Changes as described on Cover Sheet В 11 Ju**l**y 2025 Changes as described on Cover Sheet C 15 Ju**l**y 2025 Changes as described on Cover Sheet

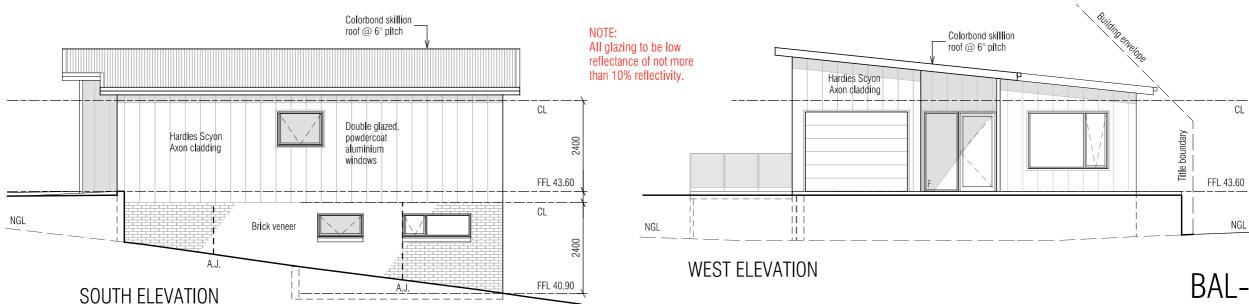Changes as described on Cover Sheet

11 September 2025

D

BAL-12.5

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UNIT 3 ELEVATIONS 11/09/25 H1346 DA 150525.dgn

PROPOSED UNIT DEVELOPMENT FOR TASSIE HOMES AT 116 DOLINA DRIVE, ROKEBY

18

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IMPORTANT NOTE:

Cladding to be installed over min. 10mm battens to provide airflow between cladding and vapour permeable membrane.


FFL 43.60

CL

NGL

NGL

FFL 40.90

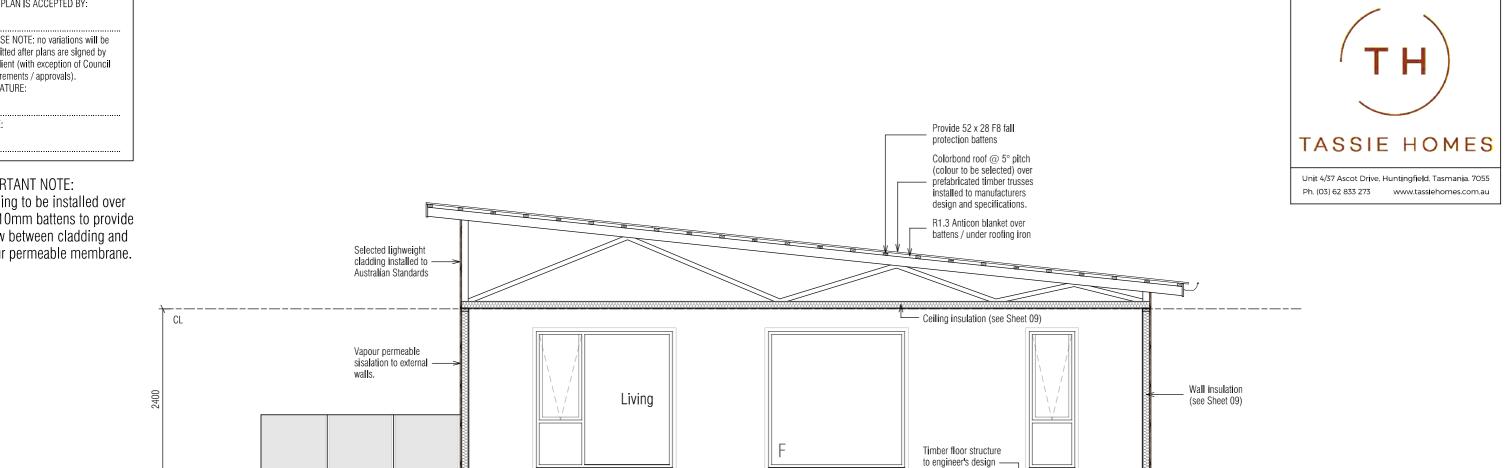

10mm plasterboard wall & ceiling lining

Concrete slab and footings to engineer's design and -

Remove vegetated top soil FCR fill compacted in max. 150mm layers to AS 2870 50mm blinding sand Waterproof membrane, taped joints, 300 lap

specifications

and specifications

Vapour permeable

sisalation to external

SECTION Scale 1:50

PROPOSED UNIT DEVELOPMENT FOR TASSIE HOMES AT 116 DOLINA DRIVE, ROKEBY

BAL-12.5 See sheet 27 for Bushfire Attack Level construction requirements

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Brick veneer

NGL

UNIT 3 SECTION 22/07/25 H1346 DA 150525.dgn

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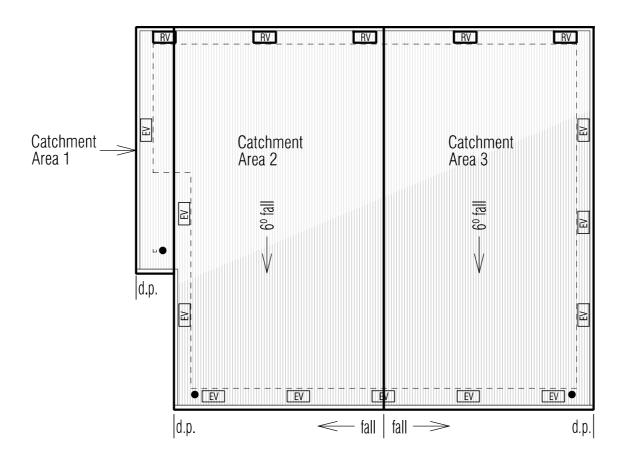
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ROOF VENTILATION CALCULATIONS (6° skillion roof)

200 x 400 eaves vents (0.08m²) Ceiling area = $92.6m^2 / 150 = 0.617m^2$ 30% of $0.617m^2 = 0.185m^2$ 0.185m² / $0.08m^2 = 2.3$ (x 2) = 5 ridge vents 70% of $0.617m^2 = 0.432m^2$ 0.432m² / $0.08m^2 = 5.4$ (x 2) = 11 eaves vents

200 x 400 ridge vent (50% opening)

EV 200 x 400 eaves vent (50% opening)



| DOWNPIPE & ROOF CATCHMENT AREA CALCULATIONS (as per NCC Part 3.5.2) | | | | | | |
|---|-------|---|--|--|--|--|
| Ah | 118.9 | Area of roof (including 115mm Quad Gutter) (m²) | | | | |
| Ac | 124.8 | Ah x slope factor (determined from Table 3.2 from AS/NZS 3500.3) (m²) | | | | |
| Gutter type | А | Cross sectional area 6500mm² (determined from NCC Table 3.5,2.2) | | | | |
| DRI | 85 | Design Rainfall Intensity Hobart (determined from NCC Table 3.5.2.1) | | | | |
| Acdp | 70 | Catchment area per 90mm downpipe (determined from NCC Table 3.5.2.2) | | | | |
| Downpipes Required | 2 | Ac Acdp | | | | |
| Downpipes Provided | 3 | | | | | |

PROPOSED UNIT DEVELOPMENT FOR TASSIE HOMES AT 116 DOLINA DRIVE, ROKEBY

Pocument Set ID: 5712079 Version: 1, Version Date: 07/10/2025



CATCHMENT AREA NOTES: Skillion roof @ 6° pitch CATCHMENT AREA 1 = 6.8m² CATCHMENT AREA 2 = 59.0m² CATCHMENT AREA 3 = 59.0m²

denotes roof area

d.p.
denotes downpipe

denotes direction of fall

denotes 200 x 400 ridge vent

denotes 200 x 400 eaves vent

IMPORTANT NOTES:

The position and quantity of downpipes are not to be altered without consulting with designer. Areas shown are surface / catchment areas NOT plan areas.

All roof areas shown are indicative only and not to be used for any other purpose.

Roof space must be vented. Eave vents must be fitted to the soffit with BAL compliant, non-combustible ember mesh installed. Vents must be in accordance with the NCC, BCA 2022, Volume 2, Part 10.8.3 'Ventilation of Roof Spaces' and AS 3959.

BAL-12.5

See sheet 27 for Bushfire Attack Level construction requirements

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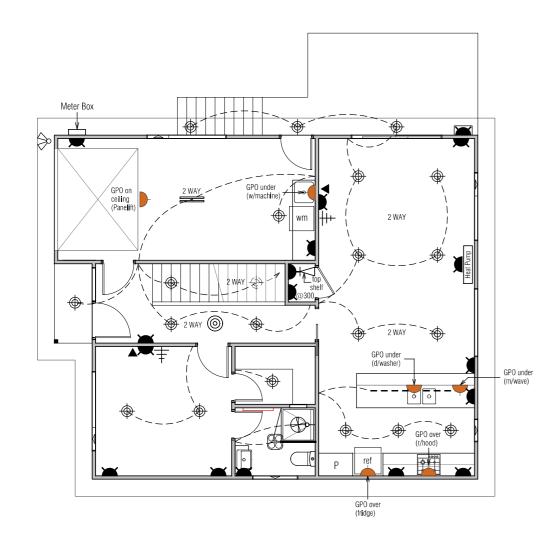
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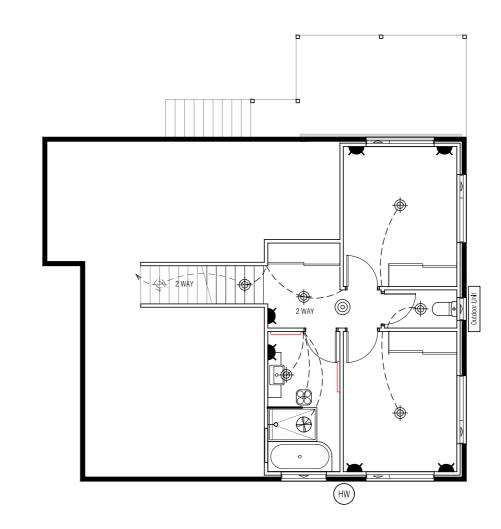
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UPPER FLOOR ELECTRICAL PLAN



LOWER FLOOR ELECTRICAL PLAN



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Ducted exhaust fan

LED spotlight (sensor)



4-light Tastic (10W centre light only)



Pendant light (28W)



LED downlight (12W)





Double GPO (exterior)



Mark Phone / NBN point



■ Data point

IMPORTANT NOTES:

Smoke alarms are to be installed in accordance with the NCC 9.5. Smoke alarms are to be interconnected where more than one alarm is installed.

Toilet & bathroom fans to be min. 25L/s and to be ducted directly to outside where possible. Kitchen & laundry fans to be min. 40L/s and to be ducted directly to outside where possible. All downlights are to be sealed and IC-F rated.

BAL-12.5

See sheet 27 for Bushfire Attack Level construction requirements

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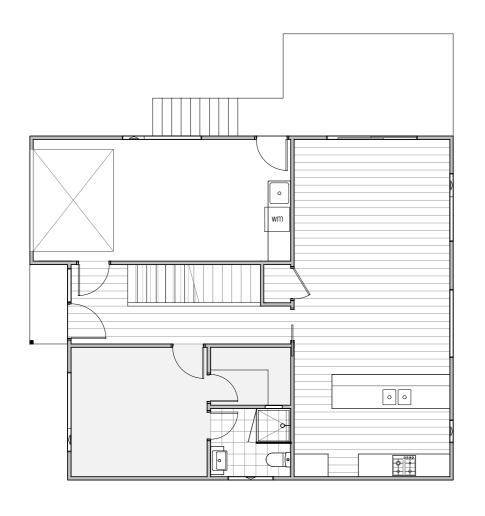
UNIT 3 ELECTRICAL PLAN 25/07/25 H1346 DA 150525.dgn


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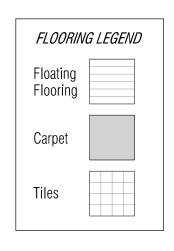
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UPPER FLOORING PLAN

LOWER FLOORING PLAN

BAL-12.5

See sheet 27 for Bushfire Attack Level construction requirements

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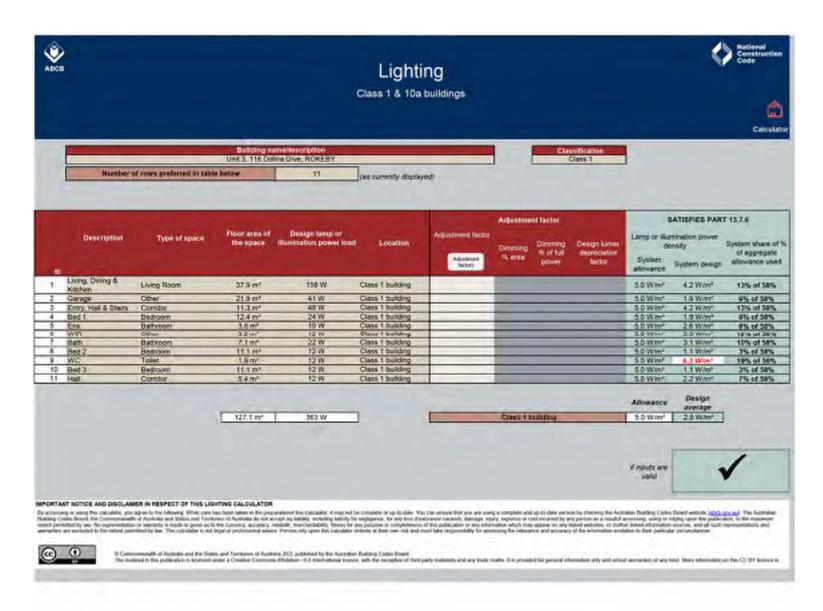
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DWG No:

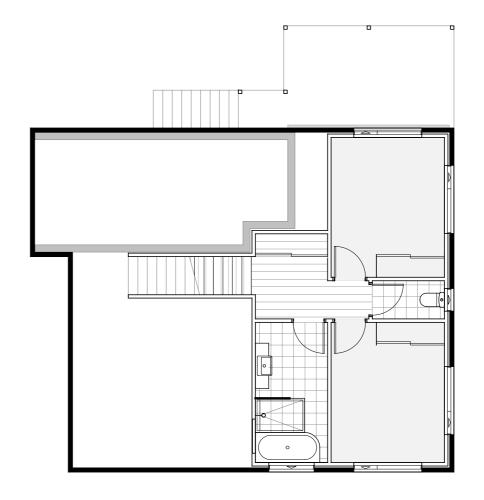



LIGHTING CALCULATIONS



WINDOW SCHEDULE

.....

| Window Number | Туре | ID | Size | Glass | Uw | SHGC |
|------------------|------|------------|-------|--------|------|------|
| W01 | AW | AWS-008-01 | 06-21 | Grey | 4.30 | 0.55 |
| W02 | FD | AWS-019-01 | 21-09 | Opaque | 4.10 | 0.50 |
| W03 | SD | AWS-013-01 | 21-24 | Grey | 4.00 | 0.61 |
| W04 | AW | AWS-008-01 | 18-18 | Grey | 4.30 | 0.55 |
| W05 | FW | AWS-067-08 | 18-18 | Grey | 3.20 | 0.68 |
| W06 | AW | AWS-008-01 | 18-06 | Grey | 4.30 | 0.55 |
| W07 | AW | AWS-008-01 | 09-12 | Opaque | 4.30 | 0.55 |
| W08 | AW | AWS-008-01 | 15-21 | Grey | 4.30 | 0.55 |
| W09 | FW | AWS-067-08 | 21-09 | Grey | 3.20 | 0.68 |
| W10 | AW | AWS-008-01 | 06-18 | Grey | 4.30 | 0.55 |
| W11 | AW | AWS-008-01 | 12-18 | Grey | 4.30 | 0.55 |
| W12 | AW | AWS-008-01 | 09-06 | Opaque | 4.30 | 0.55 |
| W13 | AW | AWS-008-01 | 12-18 | Grey | 4.30 | 0.55 |
| W14 | AW | AWS-008-01 | 06-18 | Grey | 4.30 | 0.55 |
| W15 | AW | AWS-008-01 | 06-12 | Opaque | 4.30 | 0.55 |

SW = Sliding window, AW = Awning window, FW = Fixed window, SD = Sliding door, BF = Bi-fold Door or Window, FD = French door, TW = Transom Window

Windows supplied MUST HAVE Uw, SHGC & Air infiltration performance values EQUAL TO or BETTER THANK those specified above.

* Glass specification may change to comply with BAL requirements (Refer to sheet 27)

NOTE: All glazing to be low reflectance of not more than 10% reflectivity.

INSULATION

| INSULATION SCHEDULE | | | | | |
|-------------------------|---|--|--|--|--|
| AREA INSULATION DETAILS | | | | | |
| Roof | R1.3 anticon blanket under iron / over battens. | | | | |
| Ceiling | R4.0 bulk insulation (or equivalent). | | | | |
| Walls (external) | R2.0 bulk insulation (or equivalent) with 1 layer of vapour permeable sisalation. | | | | |
| Walls (internal) | R2.0 bulk insulation (or equivalent) to all internal walls adjoining unconditioned spaces. | | | | |
| Floors | R2.0 bulk insulation (or equivalent) to all timber floors above sub-floor and other unconditioned spaces below. | | | | |

Clearance is required for uncompressed installation of bulk insulation and timbers should be sized accordingly,

210mm for R4.0 bulk insulation, 240mm for R4.0 bulk insulation; 260mm for R4.0 bulk insulation.

These dimensions are nominal and may vary depending on the type of insulation to be installed.

BAL-12.5

See sheet 27 for Bushfire Attack Level construction requirements

REVISION DATE DESCRIPTION 11 September 2025 Changes as described on Cover Sheet

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DRAWING: DATE: FILE NAME: DRAWN BY: UNIT 3 LIGHTING CALCULATIONS, INSULATION & WINDOW SCHEDULE 11/09/25 H1346 DA 150525.dan

3.12.5.5 - ARTIFICIAL LIGHTING

- * Lamp power density or illumination power density of artificial lighting, excluding heaters that emit light, must not exceed the allowance of:
- (i) 5W per m² in Class 1 building;
- (ii) 4W per m2 on a verandah, balcony or the like attached to a Class 1 building (not including eave perimeter lights);
- (iii) 3W per m2 in a Class 10a building associated with a Class 1 building.
- * The illumination power density allowance must be increased by dividing it by the illumination power density adjustment factor for a control device as per BCA 2014 Table 3.12.5.3.

PROPOSED UNIT DEVELOPMENT FOR TASSIE HOMES AT 116 DOLINA DRIVE, ROKEBY

DWG No:

Document Set ID: 5712079 Version: 1, Version Date: 07/10/2025

NCC VOLUME 2, CLASS 1 & 1a COMPLIANCE NOTES

SITE PREPARATION

Excavation and filling of site to be in accordance with NCC Part 3.1 and AS 2870

Drainage works to be in accordance with NCC Part 3.1 & AS 3500.3.2. Suface drainage - finished ground to fall away from building 50mm in

Finished slab level to be;

Minimum 150 above finished ground;

Minimum 50 above paved surfaces;

Prevent ponding of water under suspended floors.

All embankments that are left exposed must be stabilised with vegetation or similar to prevent erosion.

Embankments cannot exceed 2.0m in height without the aid of retaining walls or other approved types of soil retaining methods.

All unprotected embankments must comply with the slope ratios for soil type in NCC Table 3.2.1.

| SOIL TYPE / | EMBANKMENT SLOPE | | | | |
|-----------------|------------------|----------------|--|--|--|
| CLASSIFICATION | Cut | Compacted Fill | | | |
| STABLE ROCK (A) | 8:1 | 3:3 | | | |
| SAND (A) | 1:2 | 1:2 | | | |
| FIRM CLAY (M-E) | 1:1 | 1:2 | | | |
| SOFT CLAY (M-E) | 2:3 | Not Suitable | | | |

FOOTINGS AND SLABS

Generally to be in accordance with NCC Part 4.2 (H1D4) and AS 2870. Preparation for placement of concrete and reinforcement to be to AS 2870. Concrete & steel reinforcement to be in accordance with AS 2870 & AS/NZS 3500.

The site classification to be in accordance with AS 2879.

Alternatively, footings & slabs to be in accordance with structural engineers design & specifications.

MASONRY

Generally masonry walls to be constructed in accordance with NCC Part 5 & AS 3700.

Un-reinforced masonry to NCC 5.2 & 5.3; Reinforced masonry to NCC 5.4: Masonry accessories to NCC 5.6: Vertical articulation joints to NCC 5.6.8:

Weatherproofing of to NCC 5.7.

FRAMING

Timber framing to be in accordance with AS 1684.

Manufactured timber members to be in accordance with prescribed framing manual

Sub-floor ventilation in accordance with NCC 6.2.

Sub-floor area to be clear of organic materials & rubbish.

Provide vent openings in substructure walls at a rate of not less than 6000mm²per meter of wall length, with vents not more than 600mm from corners.

150mm clearance required to underside of floor framing members unless specified otherwise by flooring material specification.

Tie down and bracing of frame to be in accordance with AS 1684 & AS 4055. Structural steel framing to be in accordance with NCC 6.3, AS 1250, AS 4100 & structural engineers design & specifications.

ROOF AND WALL CLADDING

Generally to be in accordance with NCC 3.5.

Roof cladding to be in accordance with NCC 3.5.1 and;

Roof tiles to AS 2049 & AS 2050;

Metal sheet roofing to AS 1562.1

Plastic sheet roofing to AS 4256.1, .2, .3 & .5 and AS 1562.3;

Gutters and downpipes, generally to be in accordance with NCC 7.4 & AS 3500.3.2 and The Tasmanian Plumbing Code.

Eaves, internal and valley guttering to have cross sectional area of

Roof space must be vented. Eave vents must be fitted to the soffit with BAL compliant, non-combustible ember mesh installed. Vents must be in accordance with the NCC 10.8.3 'Ventilation of Roof Spaces' and AS 3059

Wall cladding to be installed in accordance with NCC 7.5 and manufacturer's specification. Flashings and cappings to NCC 7.2.7.

GLA7ING

Generally glazing to be in accordance with NCC Part 8 and AS 1288. Refer to window legend for sizes and type.

Windows to comply with NCC 8.4 'Protection of Openable Windows'. Glazing to comply with NCC (H1D8) 8.2, 8.3 & 8.4.

BAL REQUIREMENTS:

Glazing to comply with AS 3959 - 2009 Section 3.9 'Construction of Buildings in Bushfire-prone Areas' where applicable. Window weatherproofing to AS 2047.

FIRE SAFETY

Generally to be in accordance with NCC Part 9.

Fire separation to be in accordance with NCC 9.2. External walls and gable ends constructed within 900 of boundary are to extend to underside of non-combustible roofing / eaves and are to be constructed of a masonry skin 90 thick with FBL of 60/60/60.

Sarking to have a flammability index less than 5.

Roof lights not to be placed closer than 900 from boundary. Smoke alarm installations to be in accordance with NCC 9.5. Locations indicated on the floor plan.

Smoke alarms are to be interconnected where more than 1 smoke alarm is installed.

Installation locations:

CEILINGS - 300 away from wall junction; CATHEDRAL CEILINGS - 500 down from apex;

WALLS - 300 down from ceiling junction.

Heating appliances generally to NCC 12.4 and to be in compliance with AS 2918, Also refer to manufacturer's details and specifications for setbacks to adjacent combustible surfaces, flue installation and required hearth dimensions.

Construction in Bush Fire Area to be in accordance with AS 3959.

HEALTH AND AMENIT

Generally wet area waterproofing to be in accordance with NCC 10.2 and AS 3740.

Ceiling heights to be in accordance with NCC 10.3.

Construction of sanitary compartments to NCC 10.4.2.

Required facilities to NCC 10.4.1.

Provision of natural light to be in accordance with NCC 10.5.1. Windows / roof lights to provide light transmission area equal to 10% of the floor area of the room

Artificial lighting to NCC 10.5.2.

Ventilation generally to NCC Part 10.6. Exhaust fan from kitchen, laundry, bathroom & WC to be vented to outside for steel roof and to roof space for tile roof.Natural ventilation to be provided at a rate of 5% of room floor area, in accordance with NCC 10.6.2.

Mechanical ventilation to be in accordance with NCC 10.6.3 (b) & 10.8.2 or AS 1668.2

Sound insulation requirements generally to NCC Part 10.7.

SAFE MOVEMENT AND ACCESS

Stair and ramp construction to be in accordance with NCC 11.2. Maximum of 18 risers to each flight; Riser opening to be less than 125; Treads to have non-slip surface or nosing;

RISERS - min. 115, max. 190; TREADS min. 240, max. 355.

Balustrade is generally in accordance with NCC 11.3.

Balustrade is required where area is not bounded by a wall or where level exceeds 1000 above floor level or ground level. 865 high on stairs, measured from line of stair nosing.1000 high above floor or landing. Openings between balusters / infill members to be constructed so as not to allow 125 sphere to pass between members. Where floor level exceeds 4000 above lower level, infill members between 150 and 760 above floor level, to be constructed so as to restrict climbing.

Protection from openable windows for rooms other than bedrooms to NCC 11.3.8.

ANCILLARY PROVISIONS

Generally in accordance with NCC Part 12.

Heating appliances, fireplaces, chimneys and flues to NCC Part 12.4.

OPEN FIREPLACE CONSTRUCTION to NCC 12.4.2;

CHIMNEY CONSTRUCTION to NCC 12.4.3;

INSERT FIREPLACES AND FLUES to NCC 12.4.4;

FREESTANDING HEATING APPLICANCES to NCC 12.4.5

ENERGY EFFICIENCY

Generally in accordance with BCA 2019 Part 3.12

Climate Zone 7 applicable to Tasmania (Zone 8 applicable to Alpine areas) BUILDING FABRIC INSULATION-

Insulation to be fitted to form continuous barrier to roof / ceiling, walls and floors. REFLECTIVE BUILDING MEMBRANE-

To be 'vapour permeable' with a minimum value of 4ug/Ns, installed to form 20mm airspace between reflective faces and external lining/ cladding, fitted closely up to penetrations/ openings, adequately supported and joints to be lapped minimum 150.

BÜLK INSULATION-

To maintain thickness and position after installation. Continuous cover without voids except around services/fittings.

ROOF INSULATION-

Roof construction to achieve minimum additional R Value of R4.0 unless noted otherwise. Roof lights to comply with 3.12.1.3.

EXTERNAL WALLS-

External wall construction to achieve minimum additional R Value of R2.5 unless noted otherwise. Wall surface density minimum – 220kg/m² FLOORS-

FLOORS-

Generally in accordance with 3.12.1.5.Suspended floor with an unenclosed perimeter required to achieve a minimum Total R Value of R2.0.Concrete slab on ground with an in slab heating system to be insulated to R1.0 around vertical edge of slab perimeter.

ATTACHED CLASS 10a BUILDING-

External wall or separating wall between Class 1 building is required to achieve minimum Total R-Value of R1.9.

All hot water plumbing to be insulated in accordance with AS/NZS 3500: Plumbing and Drainage, Part 4 Heated Water Services.

Thermal insulation for central heating piping to NCC 13.7.2 and 13.7.3.

Heating and cooling ductwork to NCC 13.7.4

Chimneys or flues to be fitted with sealing damper or flap.Roof lights to habitable rooms to be fitted with operable or permanent seal to minimise air leakage.External windows & doors to habitable rooms / conditioned spaces to be fitted with air seal to restrict air infiltrations.Exhaust fans to habitable rooms / conditioned spaces to be fitted with self-closing damper or filter.Building envelope to be constructed to minimise air leakage. Construction joints and junctions or adjoining surfaces to be tight fitting and sealed by caulking, skirting, architraves and cornices.Windows and external door weatherproofing to AS 2047.



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BAL-12.5

See sheet 27 for Bushfire Attack Level construction requirements

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STEP-FREE ACCESS PATH

A continuous path to a dwelling entrance door must be provided from -

- (1) The pedestrian entry at the allotment boundary from the ground level of the adjoining land; or
 - (a) an appurtenant Class 10a garage or carport; or
 - (b) a car parking space within the allotment that is provided for the exclusive use of the occupants of the dwelling.
 - (c) Access for the purposes of (1) must be -
- (2) via a pathway that -
 - (a) has no steps; and
 - (i) except for a step ramp provided under (5), has a maximum gradient of 1:14 in the direction of travel; and
 - (ii) if crossfall is provided, has a crossfall not more than 1:40; and
 - (iii) has a minimum width of 1000mm; and
 - (iv) if it incorporates a section suspended above finished ground level, is able to take loading forces in accordance with AS/NZS 1170.1; and
 - (vi) connects to a dwelling entrance door that complies with Section 2; or
 - (vi) provided directly from an attached Class 10a garage or carport, via a door complying with the requirements of Section 2, other than Clause 2.3.
- (3) For the purposes of (2), the following applies:
 - (a) Any gates along the access path must have a minimum clear opening width of 820mm, measured as if the gate were an entrance door.
 - (b) A deck or boardwalk-style path constructed in accordance with AS 1684 or NASH Standard Residential and Low-rise Steel Framing would satisfy the requirements of (2)(a)(v).
- (4) Where one or more ramps are used, the following applies:
 - (a) The aggregate length of ramping (excluding landings) must not be more than—
 - (i) 9 m for a 1:14 gradient; or
 - (ii) 15 m for a 1:20 gradient; or
 - (iii) a length determined by linear interpolation for ramps with a gradient between 1:14 and 1:20.
- (b) The minimum width of the ramp must be maintained at 1000mm between any handrails and/or kerbs (if provided) at each side of the ramp
- (c) At each end of a ramp there must be a landing that is -
 - (i) not less than 1200mm long; and
 - (ii) at least as wide as the ramp to which it connects; and
 - (iii) level, or has a gradient not more than 1:40 if a gradient is necessary for drainage.
- (d) A landing area required by Clause 2.3 may also be counted as a landing for the purposes of (c).
- (5) The access path may incorporate one step ramp having a -
 - (a) height of not more than 190mm; and
 - (b) gradient not more than 1:10; and
 - (c) width of at least 1000mm or equivalent to that of the access path, whichever is the greater; and
 - (d) maximum length of 1900mm.

THRESHOLD NOTES:

The threshold of an entrance door must -

- (a) be level; or
- (b) have a sill height of not more than 5mm if the lip is rounded or bevelled: or
- (c) have a ramped threshold that -
 - (i) does not extend beyond the depth of the door jamb; and
 - (ii) has a gradient not steeper than 1:8; and
 - (iii) is at least as wide as the minimum clear opening width of the entrance door; and
 - (iv) does not intrude into the minimum dimensions of the required landing area; or
- (d) where the requirements of (a), (b) or (c) cannot meet the weatherproofing requirements of the NCC for external entrance doors containing a raised door sill -
 - (i) have no lip or upstand greater than 15mm within the sill profile; and
 - (ii) have no more than 5mm height difference between the edge of the top surface of the sill and the adjoining finished surface.

LANDING AREA NOTES:

An entrance door must have a space of at least 1200mm x 1200mm on the external (arrival) side of the door that is -

- (a) unobstructed (other than by a gate or a screen door); and
- (b) level, or has a gradient of not more than 1:40 if a gradient is necessary to allow for drainage.

WEATHERPROOFING FOR EXTERNAL STEP-FREE ENTRANCE Weatherproofing for an external step-free entrance must be provided in accordance with one or a combination of the following:

- (a) where the external surface is concrete or another impermeable surface, a channel drain that meets the requirements of Volume Two H2D2 is to be provided for within the entrance.
- (b) Where the external trafficable surface is decking or another raised permeable surface, a drainage surface below the trafficable surface is provided that meets the requirements of Volume T20 H2D2, and drainage gaps in the trafficable surface, such as those between decking boards, are no greater than -
 - (i) 8mm; or
 - (ii) in a 'designated bushfire prone area' that is permitted by AS 3959.
- (c) A roof covering an area no smaller than 1200mm by 1200mm, where the area is provided with a fall away from the building not greater than 1:40.

LIVEABLE HOUSING NOTES

Internal doorways must provide a minimum clear opening width of 820mm,

At least one shower must have a hobless and step-free entry. A lip not more than 5mm in height may be provided for water retention purposes.

Internal corridors, hallways, passageways or the like, if connected to a door that is subject to Clause 3.1, must have a minimum clear width of 1000mm, measured between the finished surfaces of opposing walls.

MEASUREMENT OF CLEAR OPENING WIDTH 820 min. Clear opening OPENING TO BE CLEAR OF DOOR LEAF AND FRAMES OPENING TO BE CLEAR OF DOOR LEAF AND FRAMES

PROPOSED UNIT DEVELOPMENT FOR TASSIE HOMES AT 116 DOLINA DRIVE, ROKEBY



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BAL-12.5

See sheet 27 for Bushfire Attack Level construction requirements

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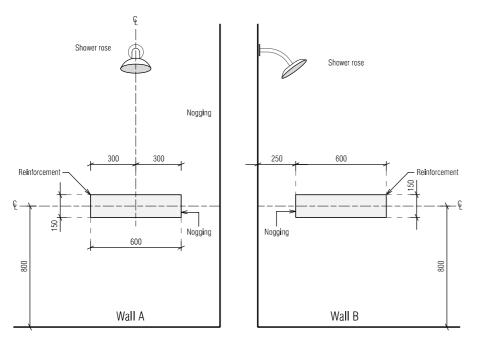
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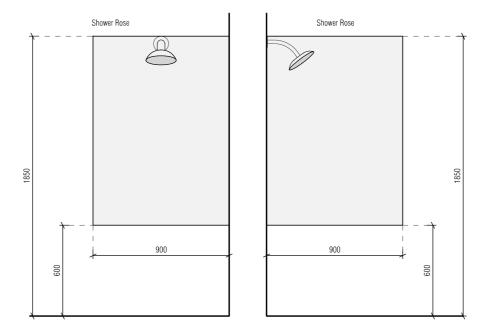
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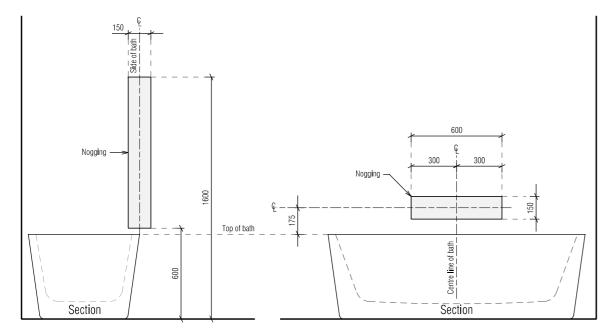
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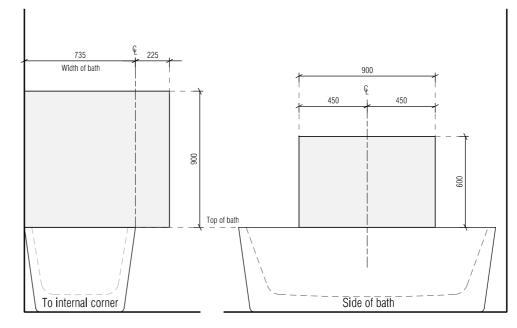
LOCATION OF NOGGINGS FOR SHOWER WALLS



LOCATION OF SHEETING FOR SHOWER WALLS



LOCATION OF NOGGINGS FOR WALLS SURROUNDING A BATH



LOCATION OF SHEETING FOR WALLS SURROUNDING A BATH

BAL-12.5 See sheet 27 for

TASSIE HOMES

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Bushfire Attack Level construction requirements

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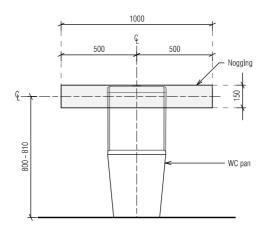
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LIVEABLE HOUSING NOTES 2 of 3 22/07/25 H1346 DA 150525.dgn PC


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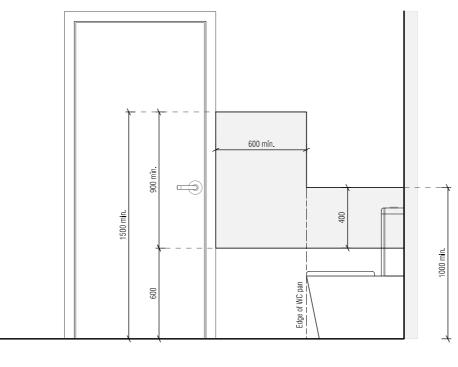
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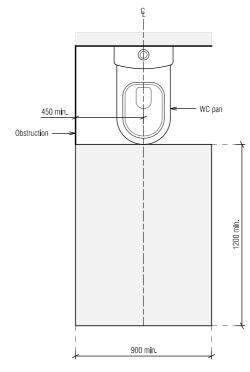
LOCATION OF NOGGINGS FOR A WALL BEHIND TOILET PAN



LOCATION OF SHEETING BEHIND TOILET PAN



MINIMUM EXTENT OF SHEETING FOR A WALL ADJACENT TO A TOILET PAN

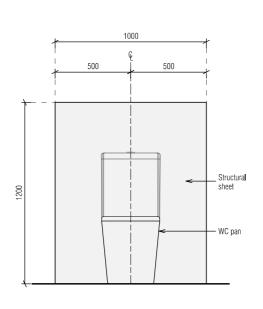

CIRCULATION SPACE FOR A TOILET PAN

BAL-12.5

See sheet 27 for Bushfire Attack Level construction requirements

TASSIE HOMES

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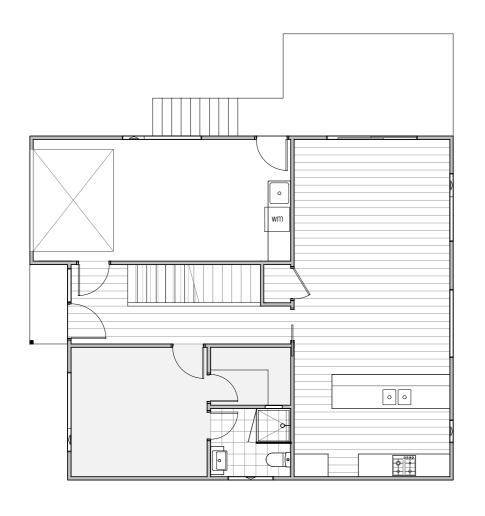
LIVEABLE HOUSING NOTES 3 of 3 22/07/25 H1346 DA 150525.dgn PC


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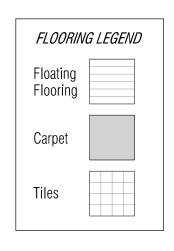
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UPPER FLOORING PLAN

LOWER FLOORING PLAN

BAL-12.5

See sheet 27 for Bushfire Attack Level construction requirements

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| DATE: | |

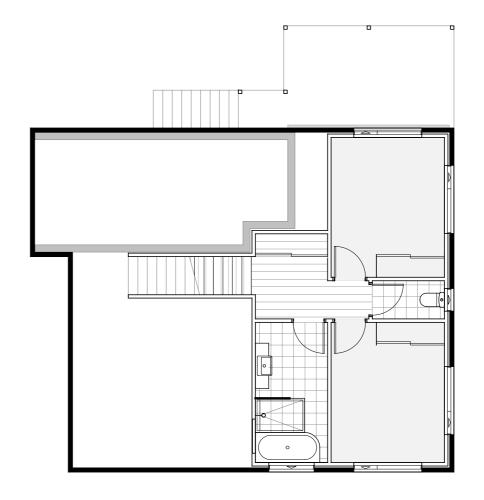Floors and horizontal surfaces

Waterproof entire enclosed

shower area, including hob.

Waterproof entire enclosed

Waterproof entire enclosed

Waterproof entire enclosed

Water resistant to entire floor

Waterproof entire floor.

shower area.

N/A

shower area, including the step

shower area, including waterstop.

Vessels or area where the

Enclosed shower with hob

Enclosed shower without hob

Enclosed shower with step

Enclosed shower with

Unenclosed showers

Areas outside the shower area

for concrete and compressed

Areas outside the shower area

for timber floors including

particleboard, plywood and

other timber based flooring

fibre cement sheet flooring

preformed shower base

fixture is installed



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| Walls | Wall junctions and joints | Penetrations | Vessels o |
|--|---|------------------------------|--|
| Waterproof to not less than 150mm above the shower floor substrate or not less than 25mm above the maximum retained water level which ever is the greater with the remainder being water resistant to a height of not less than 1800mm above the finished floor level. | Waterproof internal and external corners and horizontal joints within a height of 1800mm above the floor level with not less than 40mm width either side of the junction. | Waterproof all penetrations. | Areas adj spas for c compress sheet floo |
| Waterproof to not less than 150mm above the shower floor substrate with the remainder being water resistant to a height of not less than 1800mm above the finished floor level. | Waterproof internal and external corners and horizontal joints within height of 1800mm above the floor level with not less than 40mm width either side of the junction. | Waterproof all penetrations. | spas (see floors inc plywood a based floo |
| | | | Inserted b |
| Waterproof to not less than 150mm above the shower floor substrate or not less than 25mm above the maximum retained water level whichever is the greater with the remainder being water resistant to a height of not less than 1800mm above the finished floor level. | Waterproof internal and external corners and horizontal joints within a height of 1800mm above the floor level with not less than 40mm width either side of the junction. | Waterproof all penetrations. | Walls adj (eg. sinks basins) |
| Water resistant to a height of not less than 1800mm above finished floor level. | Waterproof internal and external corners and horizontal joints within a height of 1800mm above the floor level with not less than 40mm width either side of the junction. | Waterproof all penetrations. | Laundries |
| Waterproof to not less than 150mm above the shower floor substrate or not less than 25mm above the maximum retained water level which ever is the greater with the remainder being water resistant to a height of not less than 1800mm above the finished floor level. | Waterproof internal and external corners and horizontal joints within a height of 1800mm above the floor level with not less than 40mm width either side of the junction. | Waterproof all penetrations. | IMPORT 1. If a : requ 2. N/A by Ii 3. Cert 4. Con wate |
| N/A | Waterproof all wall / floor junctions. Where a flashing is used the horizontal leg must be not less than 40mm. | N/A | for i 5. The is in Wat code |
| N/A | Waterproof all wall / floor junctions. Where a flashing is used the horizontal leg must be not less than 40mm. | N/A | this |

| Vessels or area where the fixture is installed | Floors and horizontal surfaces | Walls | Wall junctions and joints | Penetrations |
|---|--|---|--|---|
| Areas adjacent to baths and spas for concrete and compressed fibre cement sheet flooring. | Water resistant to entire floor. | Water resistant to a height of not less than 150mm above the vessel and exposed surfaces below the vessel lip to floor level. | Waterproof edges of the vessel and junction of bath enclosure with floor. Where the lip of the bath is supported by a horizontal surface, this must be waterproof for showers over bath and water resistant for all other cases. | Waterproof all tap and spout penetrations where they occur in a horizontal surface. |
| Areas adjacent to baths and spas (see note 1) for timber floors including particleboard, plywood and other timber based flooring materials. | Waterproof entire floor. | Water resistant to a height of not less than 150mm above the vessel and exposed surfaces below the vessel lip to floor level. | Waterproof edges of the vessel and junction of bath enclosure with floor. Where the lip of the bath is supported by a horizontal surface, this must be waterproof for showers over bath and water resistant for all other cases. | Waterproof all tap and spout penetrations where they occur in a horizontal surface. |
| Inserted baths | N/A for floor under bath. Waterproof entire shelf area, incorporating waterstop under the bath lip and project not less than 5mm above the tile surface. | N/A for wall under bath. Waterproof to not less than 150mm above the lip of the bath. | N/A for wall under bath. | Waterproof all tap and spout penetrations where they occur in a horizontal surface. |
| Walls adjoining other vessels (eg. sinks, laundry tubs and basins) | N/A | Water resistant to a height of not less than 150mm above the vessel if the vessel is within 75mm of the wall. | Where the vessel is fixed to a wall, waterproof edges for extent of vessel. | Waterproof all tap and spout penetrations where they occur in a horizontal surface. |
| Laundries and WCs | Water resistant to entire floor. | Waterproof all wall / floor junctions to not less than 25mm above the finished floor level, sealed to floor. | Waterproof all wall / floor junctions. Where a flashing is used the horizontal leg must be not less than 40mm. | N/A |

RTANT NOTES:

- a shower is included above a bath, refer to the quirements for shower area walls and penetrations.
- /A means not applicable. Wet areas waterproofing licensed and accredited installer (eg Wet Seal). ertification to be provided to the Building Surveyor.
- ontractor or builder to determine the appropriate aterproofing in accordance with NCC Volume 2, 4D2 & H4D3 and to notify the Building Surveyor r inspection arrangements during installation.
- ne above information is for general guidance and indicative only aterproofing installers to comply with all current odes of legislation which takes precedence over is specification.

NOTES TO THE OCCUPANT

Due to potential problems with condensation in residential buildings which can lead to structural damage over time and which may also be detrimental to the health of the occupants, the following strategies are recommended:

- 1. Open windows every day for a few minutes especially when showering and cooking. Not every window needs to be opened, just those required to provide cross ventilation and extraction of moisture laden air; 2. Ensure extractor fans are used every time when bathing,
- 3. Ensure extractor fans are ducted to the outside; *
- 4. Ensure non-condensing clothes dryers are ducted to the outside; **
- 5. Install a rangehood or limit steam from cooking activities. i.e. by keeping lids on pots etc;
- 6. Avoid the use of unflued gas heaters,
- 7. Do not store large quantities of firewood inside the home in unventilated spaces;
- 8. Avoid plants and water features in unventilated spaces;
- 9. Ensure covers are kept on aquariums;
- 10. Dry clothes in rooms that are warm, have adequate ventilation and are separated from the main house;
- these details are also noted on the plans for the builders.

** or install separate air extractor on ceiling. However, direct ducting is recommended.

BAL-12.5

See sheet 27 for Bushfire Attack Level construction requirements

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WET AREA SPECIFICATIONS 22/07/25 H1346 DA 150525.dgn

DWG No:

TIMBER DECKING SPECIFICATIONS

| TIMBER TYPE | THICKNESS (mm) | RECOMMENDED MAXIMUM JOIST SPACING (mm) |
|--------------------------------|-------------------------------|---|
| Kwila, jarrah, other hardwoods | 19 | 500 |
| Treated pine | 22 dressed | 450 |
| | 19 sawn (25 actual thickness) | 500 |
| Cypress | 21 | 400 |
| | 25 | 500 |

BOLTS FOR BEARER TO STUMP/POST CONNECTIONS

| | MAXIMUM ALLOWABLE DECK AREA SUPPORTED PER BOLT (m²) - REFER NOTES | | | | |
|--------------|---|----------------------------|---|----------------------------|--|
| BOLT TYPE | Seasoned Hardwood (F17) Minimum timber thickness: 35mm | | Treated Pine (F5) Minimum timber thickness: 35mm | | |
| | Bearer to one side only (fig. 18) | Spaced Bearer (fig. 19) | Bearer to one side only (fig. 18) | Spaced Bearer (fig. 19) | |
| M10 | 1.0 | 1.7 | 0.8 | 1.3 | |
| M12 | 1.3 | 2.0 | 1.0 | 1.5 | |
| M16 | 1.7 | 2.7 | 1.2 | 2.0 | |
| M20 | 2.1 | 3.4 | 1.5 | 2.5 | |

TIMBER STAIR TREADS

| | STAIR WIDTH (mm) | | | | |
|-------------------------|-------------------------------------|------|------|------|------|
| TIMBER TYPE | 750 | 1000 | 1200 | 1500 | 1800 |
| | RECOMMENDED THICKNESS OF TREAD (mm) | | | | |
| Treated Pine, Cypress | 45 | 50 | 55 | 65 | 80 |
| Jarrah, other hardwoods | 45 | 45 | 45 | 55 | 60 |
| | SCREW TYPE / NUMBER | | | | |
| | 3#10 3#10 3#10 3#12 3 ₇ | | | | |

STRINGER TO WALL FIXING


| INTERNAL | 14 gauge, 75mm bugle screws into wall studs |
|----------|--|
| EXTERNAL | M10 masonry anchors into masonry @ 600 centres |

19mm THICK DECKING BOARD FIXING REQUIREMENTS


| DECKING | JOIST | NAILING | | | | |
|--------------|-------------------------------|-----------------------|--------------------|-----------------------|--------------------|--|
| SPECIES | SPECIES | Machine Driven | | Hand Driven | | |
| Hardwood, | Hardwood, Cypress | 50 x 2.5 Flat Head | | 50 x 2.8 Flat Head | | |
| Cypress | Seasoned Treaded Pine, Oregon | 50 x 2.5 DS Flat Head | 65 x 2.5 Flat Head | 50 x 2.8 DS Flat Head | 65 x 2.8 Flat Head | |
| Seasoned | Hardwood, Cypress | 50 x 2.5 Flat Head | | 50 x 2.8 | Flat Head | |
| Treated Pine | Seasoned Treaded Pine, Oregon | 50 x 2.5 DS Flat Head | 65 x 2.5 Flat Head | 50 x 2.8 DS Flat Head | 65 x 2.8 Flat Head | |

- Nails to be hot dipped galvanised or stainless steel (mechanical galvanised plated not recommended). In areas subjected to extreme wetting and drying conditions (e.g. around swimming pools), consideration
- should be given to increasing the nail diameter and/or length.

 Dome head nails may be used in lieu of flat head nails.

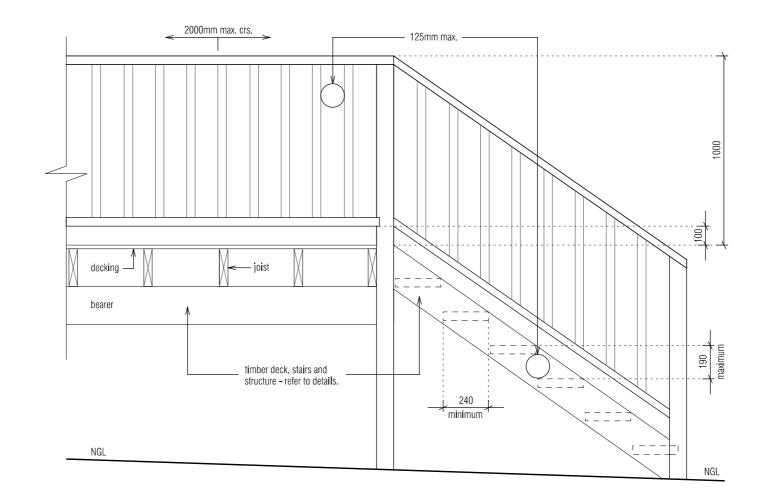

TREAD TO STRINGER FIXING OPTIONS

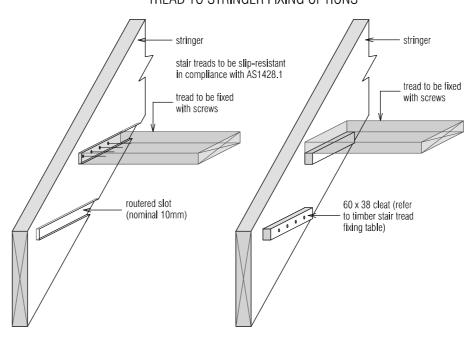

PROPOSED UNIT DEVELOPMENT FOR TASSIE HOMES AT 116 DOLINA DRIVE, ROKEBY



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BAL-12.5

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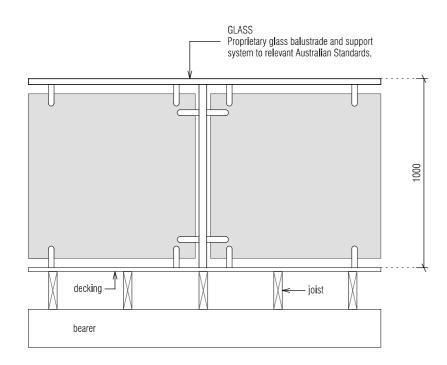
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DWG No:

Document Set ID: 5712079 Version: 1, Version Date: 07/10/2025

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TIMBER STRINGERS

| TIMBEROTTINGENO | | | | | | |
|--|---------------------------|--------------------------|------|------|------|------|
| | SECTION* SIZES (mm) | STAIR WIDTH (mm) | | | | |
| TIMBER TYPE | | 750 | 1000 | 1200 | 1500 | 1800 |
| | | MAXIMUM NUMBER OF RISERS | | | | |
| | 190 x 35 | 10 | 8 | 8 | 7 | 6 |
| | 190 x 45 | 11 | 10 | 9 | 8 | 7 |
| Treated Pine, | 240 x 35 | 12 | 11 | 10 | 9 | 8 |
| Cypress | 240 x 45 | 14 | 12 | 11 | 10 | 9 |
| | 290 x 35 | 15 | 13 | 12 | 11 | 10 |
| | 290 x 45 | 17 | 15 | 14 | 12 | 11 |
| Jarrah, other hardwoods or Kwila | 190 x 35 | 13 | 12 | 11 | 10 | 10 |
| | 190 x 45 | 14 | 13 | 12 | 11 | 11 |
| | 240 x 35 | 16 | 15 | 14 | 13 | 12 |
| | 240 x 45 | 18 | 16 | 15 | 14 | 13 |
| | 290 x 35 | 18 | 18 | 17 | 16 | 15 |
| | 290 x 45 | 18 | 18 | 8 | 17 | 16 |
| | | | | | | |

* Sizes stated are minimum sizes.

The building regulations limit the number of risers in a single flight of stairs to a maximum of 18.

90 x 45 F5 TRP top / bottom rails housed into posts. Intermediate newell posts 90 x 90 F5 TRP. Balusters 42 x 35 screwed to rails (1-No 8 Class 3 top & bottom). Alternative balusters 70 x 19 F5 TRP housed and screwed. (2-No 8 Class 3 top & bottom) into pre-formed handrail and bottom rail. All balusters max. aperture of 125mm. (refer table below for alternatives) 2400mm max. crs. 125mm max. decking bearer

SIZES OF HANDRAILS

| | SUPPORT SPACING (mm) | | | | | | |
|-------------------------|----------------------|---------------------------------|----------|----------|----------|--|--|
| HANDRAIL TIMBER | 900 | 1200 | 1500 | 1800 | 2400 | | |
| | | RECOMMENDED HANDRAIL SIZE* (mm) | | | | | |
| Treated Pine, | 70 x 35 | 120 x 35 | 170 x 35 | 290 x 35 | 240 x 45 | | |
| Cypress | 70 x 45 | 70 x 45 | 70 x 45 | 140 x 45 | | | |
| Jarrah, other hardwoods | 70 x 35 | 70 x 35 | 90 x 35 | 170 x 35 | 290 x 35 | | |
| | 70 x 45 | 70 x 45 | 70 x 45 | 90 x 45 | 140 x 45 | | |
| Kwila | 70 x 35 | 70 x 35 | 70 x 35 | 170 x 35 | 290 x 35 | | |
| | 70 x 45 | 70 x 45 | 70 x 45 | 70 x 45 | 120 x 45 | | |

^{*}Section sizes can be used in either a vertical or horizontal postion.

Refer to engineer's detail

- Handrails for 900, 1200 and 1500mm support spacings have been designed as continuous over two spans (continuous lengths of 1800, 2400 and 3000mm respectively).
- The sizes shown are minimum allowable dressed sections sizes. Sections sizes shall not be less than those stated.
- * WIRE HANDRAILS AS PER NCC Part 11.3.6
- * STAIR BALUSTRADES MIN 865mm ABOVE NOSE OF STAIR TREAD



38 x 25 x 1.6 RHS rails & end verticals. End verticals fixed to posts with 3-M8 stainless steel screws. Balusters 19 x 19 x 1.2 RHS at 110 crs.

All members powdercoated. 2400mm max. crs. 125mm max. decking – joist bearer 40 x 40 x 1.6 uprights at 2400 crs carried down beside

joist and through bolted with 2-M10 stainless steel bolts

TYPICAL SHRINKAGE VALUES FOR DECKING BOARDS

| BOARD WIDTH (mm) | APPROXIMATE SHRINKAGE (mm) | |
|---------------------|-------------------------------|--|
| 70 | 2 (unseasoned) | |
| C E | 0 (seasoned) | |
| 00 | 5 (unseasoned) | |
| 70 | 0 (seasoned) | |
| 70 | 2 (unseasoned) | |
| | WIDTH (mm) 70 65 70 | |

For a 6mm final gap using 70mm Kwila decking boards, the required spacer thickness would be 6 - 2 = 4mm

BAL-12.5

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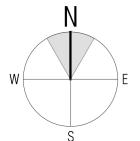
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BALUSTRADE NOTES 22/07/25 H1346 DA 150525.dgn

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Scale 1:1000

PROPOSED UNIT DEVELOPMENT FOR TASSIE HOMES AT 116 DOLINA DRIVE, ROKEBY



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DWG No:

26

CONSTRUCTION SCHEDULE BAL-12.5

Construction shall be in accordance with Bushfire Attack Level 12.5 (BAL-12.5) as specified in AS 3959-2018 Construction of Buildings in Bushfire Prone Areas, Sections 3 and 5.

SUBFLOOR shall be either slab-on-ground or timber on isolated piers with brick perimeter. The standard does not provide construction requirements for either of these subfloor construction methods. Refer section 5.3.1 for detail.

EXTERNAL WALLS shall be timber framing, externally lined with sarking and clad with brick veneer or Weathertex cladding respectively. (Weathertex is stated as having a density of 990kg/m3. Any exposed timber shall bushfire resistant timber (AS 3959-2018 Appendix E1 or Appendix F compliant). Compliant timbers include Tas Oak (as Messmate, Peppermint & Manna Gum) or Southern Blue Gum as long as the density is 750 kg/m3 or greater. Refer section 5.4.1 for detail.

JOINTS IN EXTERNAL WALLS are to be covered, sealed, overlapped, backed or butt-jointed to prevent gaps greater than 3mm. Refer section 5.4.2 for detail.

VENTS, WEEPHOLES AND GAPS IN EXTERNAL WALLS greater than 3mm are to be fitted with 2mm minimum aperture, corrosion resistant steel, bronze or aluminium mesh. Refer section 5.4.3 for detail.

BUSHFIRE SHUTTERS when used, shall protect the whole window/door assembly and shall be fixed to the building and be non-removable with gaps no greater than 3mm between the shutter and the wall, sill or head. They must be manually openable from either inside or outside. They shall be made of non-combustible material or bushfire resistant timber (AS 3959-2018 Appendix F compliant). Perforations must have an area no greater than 20% of the shutter and be uniformly distributed with gaps no greater than 3mm (or no greater than 2mm when the openable portion of the window is not screened).

SCREENS shall be fitted internally or externally to openable portions of windows. Screens shall be aluminium framed with 2mm minimum aperture, corrosion resistant steel, bronze or aluminium mesh. No gaps between the perimeter of the screen assembly and the building are to be greater than 3mm. Refer section 5.5.1A for detail. Alternatively, compliant bushfire shutters may be installed.

WINDOWS AND GLAZED SLIDING DOORS and their frames, joinery and architraves can be aluminium framed but can also be PVC which is shown to be bushfire resistant or bushfire resistant timber (AS 3959-2018 Appendix E2 or Appendix F compliant). Compliant timbers include Celery Top, Blackwood, Myrtle, Southern Blue Gum, some Tas Oak (as Messmate, Alpine Ash, Mountain Ash, Silvertop Ash, Peppermint & Manna Gum) or Plantation Ash (as Shining Gum) as long as the density is 650 kg/m3 or greater.

Windows less than 400mm from the ground or less than 400mm above decks, carport roofs, veranda roofs and awnings which have an angle less than 18 degrees shall be a minimum of 4mm Grade A safety glass. When using double glazing this requirement applies to the external face only. Windows above 400mm (when specific glazing is not required by other relevant Standards) may use annealed glass. Sliding doors shall be glazed with a minimum of Grade A safety glass. Refer section 5.5.2 for detail. Alternatively, compliant bushfire shutters may be installed. Care should be taken to ensure that the energy assessor for this project is aware of the minimum glazing requirements for this BAL classification so as to avoid conflict with glazing specifications.

SIDE HUNG EXTERNAL DOORS can be either non-combustible or solid timber with a minimum thickness of 35mm, or hollow core with a non-combustible kick plate on the outside for the first 400mm above the threshold. Glazed doors including French doors and bi-fold must have glazing that complies with the glazing requirements for windows and the frame can be aluminium framed or PVC which is shown to be bushfire resistant or bushfire resistant timber (AS 3959-2018 Appendix E2 or Appendix F compliant). Compliant timbers include Celery Top, Blackwood, Myrtle, Southern Blue Gum, some Tas Oak (as Messmate, Alpine Ash, Mountain Ash, Silvertop Ash, Peppermint & Manna Gum) or Plantation Ash (as Shining Gum) as long as the density is 650 kg/m3 or greater. Refer section 5.5.3 for detail.

DOOR JAMBS AND ARCHITRAVES can be aluminium framed or PVC which is shown to be bushfire resistant or bushfire resistant timber (AS 3959-2018 Appendix E2 or Appendix F compliant). Compliant timbers include Celery Top, Blackwood, Myrtle, Southern Blue Gum, some Tas Oak (as Messmate, Alpine Ash, Mountain Ash, Silvertop Ash, Peppermint & Manna Gum) or Plantation Ash (as Shining Gum) as long as the density is 650kg/m3 or greater. Doors must be tight-fitting to the door jamb (and to the abutting door where applicable). Weather strips or draught excluders shall be installed to all side-hung external doors.

GARAGE DOORS must be fully non-combustible or have the lower portion of the door which is within 400mm of the ground be non-combustible. Panel lift, tilt or side hung doors shall be fitted with weather strips, draught excluders or guide tracks as appropriate to the door type with gaps no greater than 3mm. Roller doors shall have guide tracks with gaps no greater than 3mm or fitted with a nylon brush that is in contact with the door. Refer section 5.5.5 for detail.

ROOF shall be timber framing, lined with sarking on the outside of the frame and clad with corrugated colorbond cladding. Any gaps under ribs or roof components such as roof eave, fascia and wall junctions are to be sealed with 2mm aperture corrosion resistant, steel, bronze or aluminium mesh, or filled with mineral wool to prevent openings greater than 3mm. Refer section 5.6.1, 5.6.2 & 5.6.3 for detail.

VERANDAH, CARPORT OR AWNING ROOFS forming part of the main roof shall meet the requirements of the main roof. Refer section 5.6.4 for detail.

ROOF PENETRATIONS such as skylights, vent pipes and aerials that penetrate the roof shall be sealed to prevent openings greater than 3mm. Openable and vented skylights or vent pipes shall be fitted with 2mm aperture corrosion resistant, steel, bronze or aluminium mesh ember guards. All overhead glazing shall be Grade A safety glass. PVC vent pipes are permitted. Refer section 5.6.5 for detail.

EAVES LINING, FASCIA AND GABLES shall be cement sheet or equivalent non-combustible material and sealed to prevent openings greater than 3mm. Refer section 5.6.6 for detail.

GUTTERS AND DOWNPIPE materials and requirements are not specified in the standard for BAL-12.5 with the exception of box gutters which shall be non-combustible. Gutter and valley leaf guards are not a requirement of the standard but they are strongly recommended. If installed, they must be non-combustible. Refer section 5.6.7 for detail.

VERANDAH AND DECK SUPPORTS AND FRAMING can be timber construction as there are no construction requirements in the standard for BAL-12.5. Decking may be spaced or un-spaced and the sub-floor either enclosed or unenclosed. If the decking is spaced it is assumed that the spacing shall be 3mm nominal spacing with an allowance of between 0-5mm due to seasonal changes. If the deck sub-floor is enclosed, then all materials less than 400mm from the ground shall be non-combustible. Refer section 5.7.1, 5.7.2 & 5.7.3 for detail.

VERANDAHS, DECKS, STEPS, LANDINGS AND RAMPS and their elements can be timber construction as there are no construction requirements for BAL-12.5 except for elements less than 300mm horizontally and 400mm vertically from glazed elements which must be bushfire resistant timber (AS 3959-2018 Appendix E1 or Appendix F compliant) or equivalent noncombustible material. Compliant timbers include Tas Oak (as Messmate, Peppermint & Manna Gum) or Southern Blue Gum as long as the density of 750kg/m3 or greater. An acceptable solution would be to line the area with cement sheet with ceramic tiles over. Refer section 5.7.2.4 for detail.

BALUSTRADES AND HANDRAILS can be timber construction as there are no construction requirements in the standard for BAL 12.5. Refer section 5.7.4 for detail.

WATER AND GAS SUPPLY PIPING where it is above ground and exposed shall be metal. Refer section 5.8 for detail.



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BAL-12.5

See sheet 27 for Bushfire Attack Level construction requirements

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DWG No:

BUSHFIRE ATTACK LEVEL CONSTRUCTION REQUIREMENTS 22/07/25 H1346 DA 150525.dan

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PROPOSED UNIT DEVELOPMENT FOR TASSIE HOMES AT 116 DOLINA DRIVE, ROKEBY

THIS PLAN IS ACCEPTED BY:

PLEASE NOTE: no variations will be permitted after plans are signed by the client (with exception of Council requirements / approvals).
SIGNATURE:

DATE:

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Version: 1, Version Date: 07/10/2025