

DEVELOPMENT APPLICATION PDPLANPMTD-2025/056290

PROPOSAL: Dwelling

LOCATION: 37 Kotona Street, Rokeby

RELEVANT PLANNING SCHEME: Tasmanian Planning Scheme - Clarence

ADVERTISING EXPIRY DATE: 10 November 2025

The relevant plans and documents can be inspected at the Council offices, 38 Bligh Street, Rosny Park, during normal office hours until 10 November 2025. In addition to legislative requirements, plans and documents can also be viewed at www.ccc.tas.gov.au during these times.

Any person may make representations about the application to the Chief Executive Officer, by writing to PO Box 96, Rosny Park, 7018 or by electronic mail to clarence@ccc.tas.gov.au. Representations must be received by Council on or before 10 November 2025.

To enable Council to contact you if necessary, would you please also include a day time contact number in any correspondence you may forward.

Any personal information submitted is covered by Council's privacy policy, available at www.ccc.tas.gov.au or at the Council offices.

Clarence City Council



APPLICATION FOR DEVELOPMENT / USE OR SUBDIVISION

The personal information on this form is required by Council for the development of land under the Land Use Planning and Approvals Act 1993. We will only use your personal information for this and other related purposes. If this information is not provided, we may not be able to deal with this matter. You may access and/or amend your personal information at any time. How we use this information is explained in our **Privacy Policy**, which is available at www.ccc.tas.gov.au or at Council offices.

December	
Proposal:	New Residential Dwelling
Location:	
Location.	Address 37 KOTONA STREET
	Suburb/Town ROKEBY, TAS Postcode 7019
Current	
Owners/s:	Personal Information Removed
Applicant:	
Tax Invoice for application fees to	
be in the name of: (if different from	
applicant)	
-	
	Is the property on the Tasmanian Heritage Register? Yes No
	(if yes, we recommend you discuss your proposal with Heritage Tasmania prior to lodgement as

If you had pre-application discussions with a Council Officer, please give their name		
Current Use of Site:		
Does the proposal involve land administered or owned by the Crown or Council?	d Yes No	/

Declaration:

- I have read the Certificate of Title and Schedule of Easements for the land and am satisfied that this application is not prevented by any restrictions, easements or covenants.
- I authorise the provision of a copy of any documents relating to this application to any person for the purposes of assessment or public consultation. I agree to arrange for the permission of the copyright owner of any part of this application to be obtained. I have arranged permission for Council's representatives to enter the land to assess this application
- I declare that, in accordance with Section 52 of the Land Use Planning and Approvals Act 1993, that I have notified the owner of the intention to make this application. Where the subject property is owned or controlled by Council or the Crown, their signed consent is attached. Where the application is submitted under Section 43A, the owner's consent is attached.
- I declare that the information in this declaration is true and correct.

Acknowledgement: •

I acknowledge that the documentation submitted in support of my application will become a public record held by Council and may be reproduced by Council in both electronic and hard copy format in order to facilitate the assessment process; for display purposes during public consultation; and to fulfil its statutory obligations. I further acknowledge that following determination of my application, Council will store documentation relating to my application in electronic format only.

Applicant's Signature:

Personal Information Removed

PLEASE REFER TO THE DEVELOPMENT/USE AND SUBDIVISION CHECKLIST ON THE FOLLOWING PAGES TO DETERMINE WHAT DOCUMENTATION MUST BE SUBMITTED WITH YOUR APPLICATION.

Clarence City Council



DEVELOPMENT/USE OR SUBDIVISION CHECKLIST

Documentation required:

1. MANDATORY DOCUMENTATION

This information is required for the application to be valid. An application lodged without these items is unable to proceed.
Details of the location of the proposed use or development.
A copy of the current Certificate of Title, Sealed Plan, Plan or Diagram and Schedule of Easements and other restrictions for each parcel of land on which the use or development is proposed.
Full description of the proposed use or development.
Description of the proposed operation. May include where appropriate: staff/student/customer numbers; operating hours; truck movements; and loading/unloading requirements; waste generation and disposal; equipment used; pollution, including noise, fumes, smoke or vibration and mitigation/management measures.
Declaration the owner has been notified if the applicant is not the owner.
Crown or Council consent (if publically-owned land).
Any reports, plans or other information required by the relevant zone or code.
Fees prescribed by the Council.
Application fees (please phone 03 6217 9550 to determine what fees apply). An invoice will be emailed
upon lodgement.

2. ADDITIONAL DOCUMENTATION

In addition to the mandatory information required above, Council may, to enable it to consider an application, request further information it considers necessary to ensure that the proposed use or development will comply with any relevant standards and purpose statements in the zone, codes or specific area plan, applicable to the use or development.

□ Site analysis plan and site plan, including where relevant:

- Existing and proposed use(s) on site.
- Boundaries and dimensions of the site.
- Topography, including contours showing AHD levels and major site features.
- Natural drainage lines, watercourses and wetlands on or adjacent to the site.
- Soil type.
- Vegetation types and distribution, and trees and vegetation to be removed.
- Location and capacity of any existing services or easements on/to the site.
- Existing pedestrian and vehicle access to the site.
- Location of existing and proposed buildings on the site.
- Location of existing adjoining properties, adjacent buildings and their uses.
- Any natural hazards that may affect use or development on the site.
- Proposed roads, driveways, car parking areas and footpaths within the site.
- Any proposed open space, communal space, or facilities on the site.
- Main utility service connection points and easements.
- Proposed subdivision lot boundaries.

Clarence City Council DEVELOPMENT/USE OR SUBDIVISION CHECKLIST



Where it is proposed to erect buildings, **detailed plan**s with dimensions at a scale of 1:100 or 1:200 showing:

- Internal layout of each building on the site.
- Private open space for each dwelling.
- External storage spaces.
- Car parking space location and layout.
- Major elevations of every building to be erected.
- Shadow diagrams of the proposed buildings and adjacent structures demonstrating the extent of shading of adjacent private open spaces and external windows of buildings on adjacent sites.
- Relationship of the elevations to natural ground level, showing any proposed cut or fill.
- Materials and colours to be used on rooves and external walls.
- ☐ Where it is proposed to erect buildings, a plan of the proposed **landscaping** showing:
 - Planting concepts.
 - Paving materials and drainage treatments and lighting for vehicle areas and footpaths.
 - Plantings proposed for screening from adjacent sites or public places.
- Any additional reports, plans or other information required by the relevant zone or code.

This list is not comprehensive for all possible situations. If you require further information about what may be required as part of your application documentation, please contact Council's Planning Officers on (03) 6217 9550 who will be pleased to assist.



RESULT OF SEARCH

RECORDER OF TITLES

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SEARCH OF TORRENS TITLE

VOLUME	FOLIO
185338	62
EDITION 1	DATE OF ISSUE 20-Jul-2023

SEARCH DATE : 16-Jul-2025 SEARCH TIME : 04.26 PM

DESCRIPTION OF LAND

City of CLARENCE

Lot 62 on Sealed Plan 185338

Derivation: Part of Lot 37617, 56.81ha Gtd. to The

Director-General of Housing & Construction

Prior CT 184319/501

SCHEDULE 1

M535627 TRANSFER to DAESUNGTAS PTY LTD Registered 03-Nov-2015 at noon

SCHEDULE 2

Reservations and conditions in the Crown Grant if any SP185338 EASEMENTS in Schedule of Easements SP185338 COVENANTS in Schedule of Easements SP185338 FENCING PROVISION in Schedule of Easements SP142549 & SP184319 COVENANTS in Schedule of Easements SP184319 FENCING PROVISION in Schedule of Easements SP184319 FENCING COVENANT in Schedule of Easements SP142549 FENCING COVENANT in Schedule of Easements SP142549 WATER SUPPLY RESTRICTION SP142549 SEWERAGE AND/OR DRAINAGE RESTRICTION N111707 MORTGAGE to Butler McIntyre Investments Ltd Registered 06-Apr-2023 at 12.05 PM

UNREGISTERED DEALINGS AND NOTATIONS

No unregistered dealings or other notations



OWNER

DAESUNGTAS PTY LTD

FOLIO REFERENCE: CT.184319-501

FOLIO PLAN

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PLAN OF SURVEY

BY SURVEYOR TIMOTHY LEIGH GOWLLAND ROGERSON AND BIRCH SURVEYORS
UNIT 1 - 2 KENNEDY DRIVE, CAMBRIDGE PARK PH 6248-5898


CITY OF CLARENCE

REGISTERED NUMBER **S**P185338

APPROVED EFFECTIVE

2 0 JUL 2023 FROM ...

Len

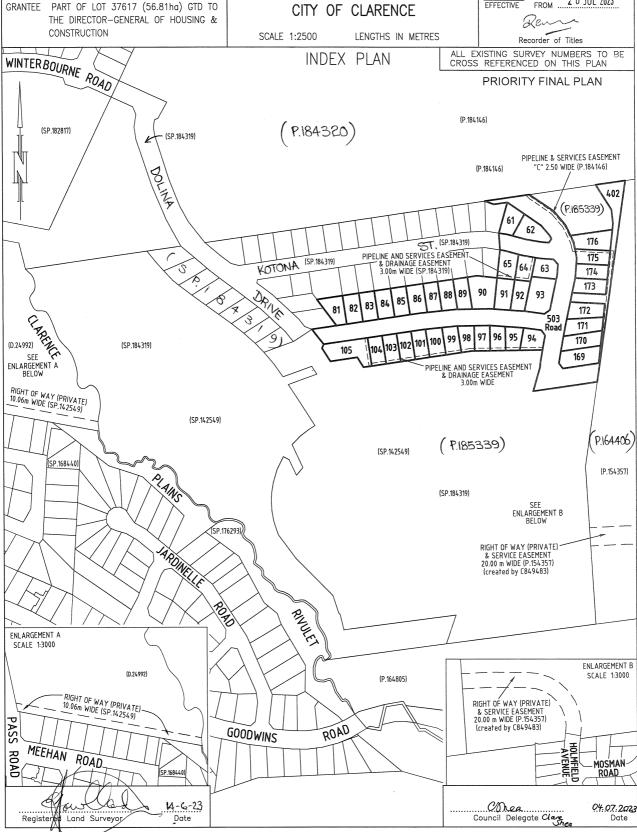

Search Date: 16 Jul 2025

Search Time: 04:26 PM

Volume Number: 185338

Revision Number: 01

Page 1 of 3




FOLIO PLAN

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Search Date: 16 Jul 2025

Search Time: 04:26 PM

Volume Number: 185338

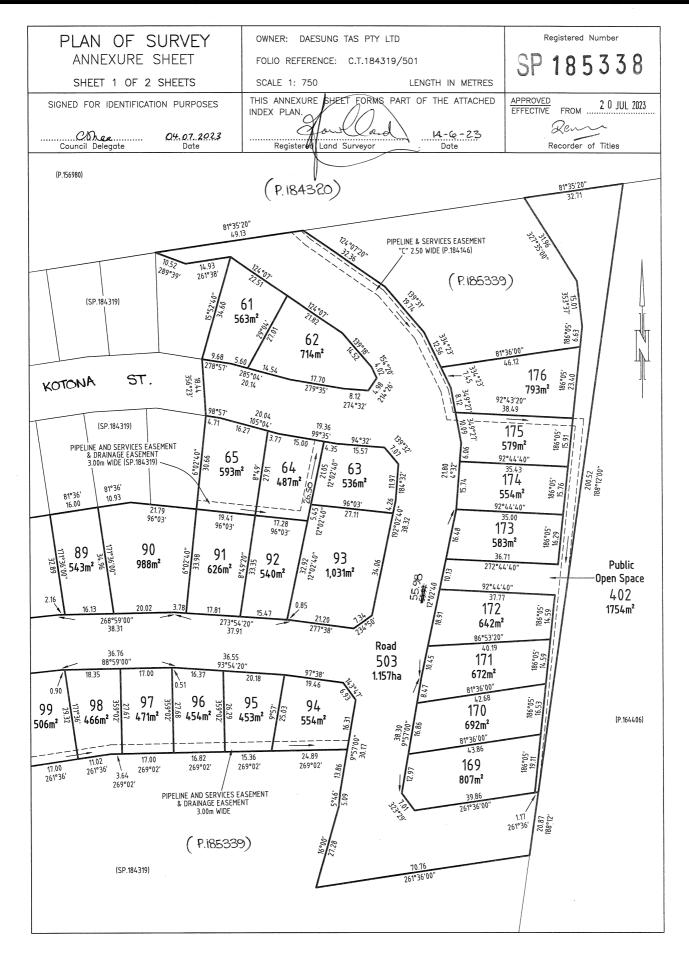Revision Number: 01

Page 2 of 3




FOLIO PLAN

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Search Date: 16 Jul 2025

Search Time: 04:26 PM

Volume Number: 185338

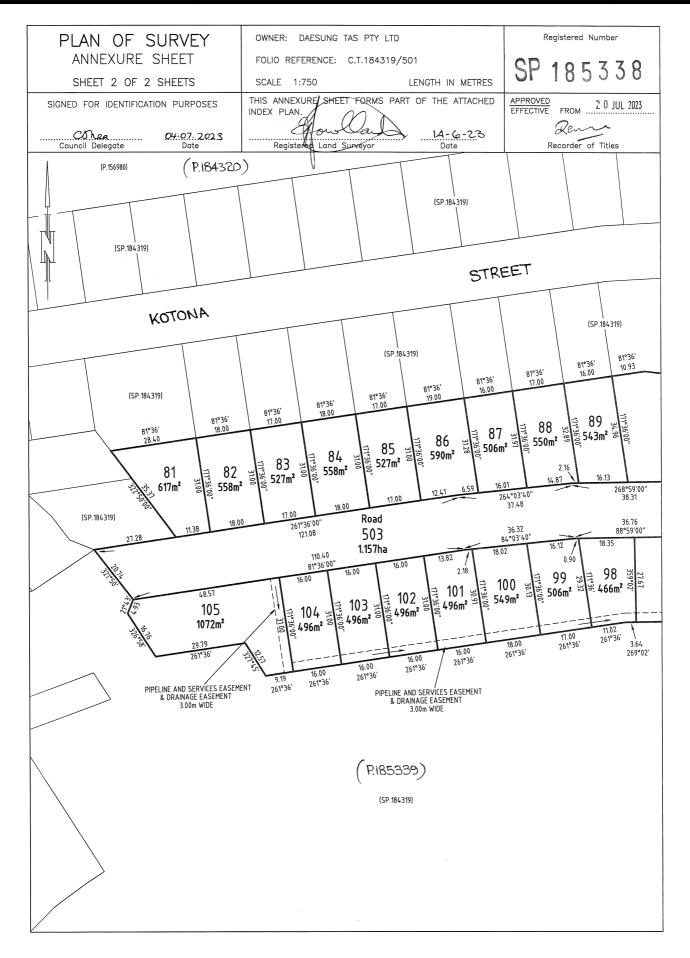Revision Number: 01

Page 3 of 3



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SCHEDULE OF EASEMENTS

NOTE: THE SCHEDULE MUST BE SIGNED BY THE OWNERS &

MORTGAGEES OF THE LAND AFFECTED. SIGNATURES MUST BE ATTESTED.

Registered Number

SP

185338

PAGE 1 OF 6 PAGES

EASEMENTS AND PROFITS

Each lot on the plan is together with:

- (1) such rights of drainage over the drainage easements shown on the plan (if any) as may be necessary to drain the stormwater and other surplus water from such lot; and
- (2) any easements or profits a prendre described hereunder.

Each lot on the plan is subject to:

- (1) such rights of drainage over the drainage easements shown on the plan (if any) as passing through such lot as may be necessary to drain the stormwater and other surplus water from any other lot on the plan; and
- (2) any easements or profits a prendre described hereunder.

The direction of the flow of water through the drainage easements shown on the plan is indicated by arrows.

EASEMENTS

Lots 64 and 65 ("the Lots") are subject to a PIPELINE AND SERVICES EASEMENT (as defined herein) in gross in favour of TasWater over the land marked PIPELINE AND SERVICES EASEMENT & DRAINAGE EASEMENT 3.00m WIDE (SP.184319) shown on the Plan ("the Easement Land").

Lots 64 and 65 on the Plan are subject to a Drainage Easement (as defined herein) in gross in favour of the Clarence City Council over the land marked PIPELINE AND SERVICES EASEMENT & DRAINAGE EASEMENT 3.00m WIDE (SP.184319) on the Plan.

Lots 94 to 105 (inclusive) ("the Lots") are subject to a PIPELINE AND SERVICES EASEMENT (as defined herein) in gross in favour of TasWater over the land marked **PIPELINE AND SERVICES EASEMENT & DRAINAGE EASEMENT 3.00m WIDE** shown on the Plan ("the Easement Land").

Lots 94 to 105 (inclusive) on the Plan are subject to a Drainage Easement (as defined herein) in gross in favour of the Clarence City Council over the land marked PIPELINE AND SERVICES EASEMENT & DRAINAGE EASEMENT 3.00m WIDE on the Plan.

Director

Director/Secretary

(USE ANNEXURE PAGES FOR CONTINUATION)

SUBDIVIDER: DAESUNGTAS PTY LTD

FOLIO REF: 184319/501

SOLICITOR

& REFERENCE: Page Seager (DAS 221111)

PLAN SEALED BY: Clarence City Council

DATE: 4th July 2023

Stage 4,5+6

REF NO. SD-2016/31

Council Delegate She

NOTE: The Council Delegate must sign the Certificate for the purposes of identification.

Search Date: 14 Jun 2025 Search Time: 09:15 AM Volume Number: 185338 Revision Number: 01 Page 1 of 6



RECORDER OF TITLES

Issued Pursuant to the Land Titles Act 1980



ANNEXURE TO SCHEDULE OF EASEMENTS

PAGE 2 OF 6 PAGES

Registered Number

SP 185338

SUBDIVIDER: DAESUNGTAS PTY LTD

FOLIO REFERENCE: 184319/501

402

Lots 503, 175 and 403 ("the Lots") are subject to a PIPELINE AND SERVICES EASEMENT in gross in favour of TasWater created by and described in E295588 over the land marked PIPELINE AND SERVICES EASEMENT "C" 2.50m WIDE (P.184146) shown on the Plan ("the Easement Land").

Each lot on the Plan is together with a right of way created by and fully described in the Schedule of Easements to SP 142549 over the land marked RIGHT OF WAY (PRIVATE) 10.06m WIDE (SP.142549) on the Plan

Each lot on the Plan is together with a right of carriageway and service easement created by and fully described in C849483 over the land marked RIGHT OF WAY (PRIVATE) & SERVICE EASEMENT 20.00m WIDE (P.154357) (created by C849483) on the Plan.

COVENANTS

The owner of each Lot on the Plan covenants with the Vendor (Daesungtas Pty Ltd) and the Owner or Owners for the time being of every other Lot shown on the Plan to the intent that the burden of these covenants may run with and bind the covenantor's Lot and every part thereof and that the benefit thereof shall be annexed to and devolve with each and every part of every other Lot shown on the plan to observe the following stipulations:

- 1. Not to subdivide that Lot at any time without the prior consent in writing of the Corporation.
- 2. Not to erect on that Lot more than a single residence, which may include an ancillary apartment together with usual outbuildings as may be permitted by the Corporation, without the consent of the Corporation.
- 3. Not to use the land for any purpose except as a residence or the for the purpose of house occupation without the prior consent of the Corporation in writing.
- 4. Not to use any engine or machinery in any trade of business, nor erect or use or permit to be used on any part of any lot shown on the Plan nor to conduct or permit to be conducted any trade or business on or from any part of the same, including but not limited to mining, quarrying, or market gardening.

Director

Director/Secretary

NOTE: Every annexed page must be signed by the parties to the dealing or where the party is a corporate body be signed by the persons who have attested the affixing of the seal of that body to the dealing.

Search Date: 14 Jun 2025 Search Time: 09:15 AM Volume Number: 185338 Revision Number: 01 Page 2 of 6

O



RECORDER OF TITLES

Issued Pursuant to the Land Titles Act 1980



ANNEXURE TO SCHEDULE OF EASEMENTS

PAGE 3 OF 6 PAGES

Registered Number

SP 185338

SUBDIVIDER: DAESUNGTAS PTY LTD

FOLIO REFERENCE: 184319/501

The leasing of the property for private residential purposes is not deemed to be a breach of this covenant.

- 5. Not to keep any animals other than domestic pets on any lot shown on the Plan and not to make any application for a kennel licence in respect of any lot shown on the Plan nor to keep or establish or permit to be kept or established any licensed kennel upon any lot or any part of any lot shown on the Plan nor to keep at one time more than two adult canines on any lot shown on the Plan.
- 6. The Vendor may, at the Vendor's absolute discretion, waive the burden of any covenant contained in this Schedule of Easements in favour of any lot by notice in writing to the registered proprietor of that lot.

FENCING PROVISION

In respect of the Lots shown on the Plan, the Vendor (Daesungtas Pty Ltd) shall not be required to fence.

DEFINITIONS

"Corporation" means the Warden Councillors and Electors of the City of Clarence.

"Drainage Easement" means a right of drainage (including the right of construction of drains) for Clarence City Council with which the right shall be capable of enjoyment for the purpose of carrying away stormwater and other surplus water from any land over or under the land herein indicated as the land over which the right is to subsist, and through all sewers and drains which may hereafter be made or passing under, through, and along the last-mentioned land and the right for Clarence City Council and its employees, agents and contractors from time to time and at all times hereafter if it or they should think fit to enter into and upon the last-mentioned land and to inspect, repair, cleanse, and amend any such sewer or drain without doing unnecessary damage to the said land.

"Pipeline and Services Easement" is defined as follows:-

Director

Director/Secretary

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Search Date: 14 Jun 2025 Search Time: 09:15 AM Volume Number: 185338 Revision Number: 01 Page 3 of 6

Q



RECORDER OF TITLES

Issued Pursuant to the Land Titles Act 1980



ANNEXURE TO SCHEDULE OF EASEMENTS

PAGE 4 OF 6 PAGES

Registered Number

SP

185338

SUBDIVIDER: DAESUNGTAS PTY LTD

FOLIO REFERENCE: 184319/501

FIRSTLY, THE FULL AND FREE RIGHT AND LIBERTY for TasWater and its employees, contractors, agents and all other persons duly authorised by it, at all times to:

- (1) enter and remain upon the Easement Land with or without machinery, vehicles, plant and equipment;
- (2) investigate, take soil, rock and other samples, survey, open and break up and excavate the Easement Land for any purpose or activity that TasWater is authorised to do or undertake;
- (3) install, retain, operate, modify, relocate, maintain, inspect, cleanse, repair, remove and replace the Infrastructure;
- run and pass sewage, water and electricity through and along the Infrastructure;
- (5) do all works reasonably required in connection with such activities or as may be authorised or required by any law:
 - (a) without doing unnecessary damage to the Easement Land; and
 - (b) leaving the Easement Land in a clean and tidy condition;
- (6) if the Easement Land is not directly accessible from a highway, then for the purpose of undertaking any of the preceding activities TasWater may with or without employees, contractors, agents and any other persons authorised by it, and with or without machinery, vehicles, plant and equipment enter the Lot from the highway at any vehicle entry and cross the Lot to the Easement Land; and
- (7) use the Easement Land as a right of carriageway for the purpose of undertaking any of the preceding purposes on other land, TasWater reinstating any damage that it causes in doing so to any boundary fence of the Lot.

SECONDLY, the benefit of a covenant in gross for TasWater with the registered proprietor/s of the Easement Land and their successors and assigns not to erect any building, or place any structures, objects, vegetation, or remove any thing that supports, protects or covers any Infrastructure on or in the Easement Land, without the prior written consent of TasWater to the intent that the burden of the covenant may run with and bind the servient land and every part thereof and that the benefit thereof may be annexed to the easement herein described.

Director

X7 3/2

Director/Secretary

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Search Date: 14 Jun 2025 Search Time: 09:15 AM Volume Number: 185338 Revision Number: 01 Page 4 of 6



RECORDER OF TITLES

Issued Pursuant to the Land Titles Act 1980



ANNEXURE TO SCHEDULE OF EASEMENTS

PAGE 5 OF 6 PAGES

Registered Number

SP 185338

SUBDIVIDER: DAESUNGTAS PTY LTD

FOLIO REFERENCE: 184319/501

Interpretation:

"Infrastructure" means infrastructure owned or for which TasWater is responsible and includes but is not limited to:

- (a) sewer pipes and water pipes and associated valves;
- (b) telemetry and monitoring devices;
- (c) inspection and access pits;
- (d) electricity assets and other conducting media (excluding telemetry and monitoring devices);
- (e) markers or signs indicating the location of the Easement Land or any other Infrastructure or any warnings or restrictions with respect to the Easement Land or any other Infrastructure;
- (f) anything reasonably required to support, protect or cover any other Infrastructure;
- (g) any other infrastructure whether of a similar nature or not to the preceding which is reasonably required for the piping of sewage or water, or the running of electricity, through the Easement Land or monitoring or managing that activity; and
- (h) where the context permits, any part of the Infrastructure.

"TasWater" means Tasmanian Water & Sewerage Corporation Pty Ltd (ACN 162 220 653), its successors and assigns.

Director

Director/Secretary

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Search Date: 14 Jun 2025 Search Time: 09:15 AM Volume Number: 185338 Revision Number: 01 Page 5 of 6



RECORDER OF TITLES



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ANNEXURE TO SCHEDULE OF EASEMENTS

PAGE 6 OF 6 PAGES

EXECUTED by DAESUNGTAS PTY LTD (ACN 607)

Registered Number

185338

SUBDIVIDER: DAESUNGTAS PTY LTD FOLIO REFERENCE: 184319/501

472 131) as registered proprietor of the land comprised in)
Folio of the Register Volume 184319 Folio 501 in)
accordance with section 127 of the Corporations Act 2001)
by:)
Director Signature Joseph Jury G Director Full Name/(print)	
Director/ Secretary Signature	
DONGKEUN YON *Director/Secretary Full Name (print)	

Director/Secretary Director

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Search Date: 14 Jun 2025

Search Time: 09:15 AM

Volume Number: 185338

Revision Number: 01

Page 6 of 6

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(*please strike out inapplicable)



Direction to submit a Development Application

This document confirms the direction from Bianca Callinan & Homes Tasmania, owner/s of 37 Kotona Street, Rokeby to Wilson Homes Tasmania Pty Limited to act as their agent within the meaning of the *Land Use Planning and Approvals Act 1993* (Tasmania) and Building Act 2016.

Signature	Signature
asla las Date of signature	Date of signature
Important Owner Confirmation	
The owners acknowledge that Wilson Homes proposal acceptance fee already paid, includir Structural engineering fees Hydraulic engineering fees Development application fees Overlay reports Arborist reports Bushfire reports Farm management reports; and Dispersive soil reports depending on the requirements of your council	
The owners acknowledge that in the unlikely of the owners to Wilson Homes.	event that they do not proceed to a contract, these fees will be payable by
Pgu.	
Signature	Signature
25/9/25	
Date of signature	Date of signature



1300 595 050 wilsonhomes.com.au

Southern Head Office 250 Murray Street, Hobart Tasmania **Northern Head Office** Level 1, 78–96 Wellington Street, Launceston Tasmania

TASMANIAN PLANNING SCHEME

1	COVER SHEET
2	SITE PLAN
3	SOIL & WATER MANAGEMENT PLAN
4	GROUND FLOOR PLAN
5	ELEVATIONS / SECTION
6	ELEVATIONS
7	WINDOW & DOOR SCHEDULES
8	CALCULATIONS
9	DETAILS (FACE BRICKWORK)
10	DETAILS (CLADDING)
11	ROOF DRAINAGE PLAN
12	FLOOR COVERINGS
13	KITCHEN DETAILS
14	BATHROOM DETAILS
15	WC DETAILS
16	ENSUITE DETAILS
17	LAUNDRY DETAILS
18	STANDARD SHOWER & WATERPROOFING
19	3D VIEWS
20	GENERAL NOTES
21	WET AREA & ENERGY EFFICIENCY NOTES
22	BUILDING ACT BUSHFIRE HAZARD AREAS
23	BAL 12.5 NOTES
24	BAL 12.5 - BAL 40 ROOF DETAILS

TOTAL FLOOR AREAS

GARAGE

PORCH

MAIN DWELLING, GROUND FLOOR

AS & NCC COMPLIANCE

ALL CONSTRUCTION TO BE IN ACCORDANCE WITH NCC 2022 AND APPLICABLE AUSTRALIAN STANDARDS AT TIME OF APPROVAL

- SLAB IN ACCORDANCE WITH AS 2870. REFER TO ENGINEERS DETAILS FOR ALL SLAB DETAILS. BRICK CONTROL JOINTS PROVIDED IN ACCORDANCE WITH NCC 2022.
- ALL STEEL FRAMING TO BE DESIGNED TO AS 4100-2020 OR AS/NZS 4600-2018.
- INSULATION TO BE INSTALLED IN ACCORDANCE WITH NCC 2022 AND ALL APPLICABLE AUSTRALIAN STANDARDS.
- TERMITE PROTECTION IN ACCORDANCE WITH AS 3660 AND NCC 2022. GLAZING IN ACCORDANCE WITH AS 1288 AND NCC 2022.
- SMOKE ALARMS IN ACCORDANCE WITH AS 3786 AND NCC 2022. INTERNAL WATERPROOFING IN ACCORDANCE WITH NCC 2022 HOUSING PROVISIONS PART 10.2.
- EXTERNAL WATERPROOFING IN ACCORDANCE WITH AS 3740 AND AS
- WET AREA FLOORS TO FALL TO FLOOR WASTES AT MIN. 1:80 AND MAX.
- 1:50 GRADE (IF APPLICABLE). CONDENSATION MANAGEMENT IN ACCORDANCE WITH NCC 2022
- HOUSING PROVISIONS PART 10.8.
 BUILDING SEALING IN ACCORDANCE WITH NCC 2022.
- SERVICES IN ACCORDANCE WITH NCC 2022. EARTHWORKS IN ACCORDANCE WITH AS 3798-2007.

30.48 128.54

2.48

161.50 m

- EXTERNAL WALL WRAP (SARKING) IN ACCORDANCE WITH NCC 2022 (IF
- EXHAUST FANS DUCTED TO OUTSIDE AIR (IF APPLICABLE).


SITE SPECIFIC CONTI	ROLS
CONTROL	DETAILS
ACID SULPHATE SOIL	NO
BIODIVERSITY	NO
BUILDING ENVELOPE	YES
BUSHFIRE	BAL-12.5
CLIMATE ZONE (NCC)	ZONE 7 - COOL TEMPERATE
DESIGN WIND CLASSIFICATION	N2 (EXPOSED TBC)
ESTATE/DEVELOPER GUIDELINES	NO
FLOOD OVERLAY	NO
HERITAGE	NO
LANDSLIP HAZARD	NO
MINIMUM FLOOR LEVEL	NO
NATURAL ASSET CODE	NO
NOISE ATTENUATION	NO
SALINE SOIL	NO
SHIELDING FACTOR	PS - PARTIAL SHIELDING
SITE CLASSIFICATION	A
SPECIFIC AREA PLAN OVERLAY	YES
PARANVILLE SPECIFIC AREA PLA	AN
TERRAIN CATEGORY	TC2
TOPOGRAPHIC CLASSIFICATION	T3
WATERWAY & COASTAL OVERLAY	NO
WIND REGION	A - NORMAL
WITHIN 1km CALM SALT WATER	NO
WITHIN 50km BREAKING SURF	4.02km
ZONING	GENERAL RESIDENTIAL
AIRPORT OBSTACLE LIMITATION	AREA

BUILDING CONTROLS & COMPLIANCE				
CONTROL	REQUIRED	PROPOSED		
SETBACKS				
FRONT	MIN. 4,500mm	5,017mm		
SECONDARY	MIN. 3,000mm	4,524mm		
SIDE	MIN. 1,500mm	2,100mm		
BULK & SCALE				
SITE AREA	714m²			
SITE COVERAGE	MAX. 50%	22.62%		
LANDSCAPE				
NO APPLICABLE CONTROLS				
EARTHWORKS				
CUT DEPTH	MAX. 2,000mm	298mm		
FILL DEPTH	MAX. 1,000mm	0mm		
ACCESS & AMENITY				
PARKING SPACES	MIN. 2 SPACES	2 SPACES		

3D PERSPECTIVE

NOTE TO OWNER

THESE PLANS MAY FEATURE WORKS THAT ARE EXCLUDED FROM THE SCOPE OF WORKS WITH THE BUILDER, BUT THEY HAVE BEEN INCLUDED IN THESE DRAWINGS TO ASSIST IN THE OVERALL PLANNING AND ASSESSMENT OF THE BUILDING PROJECT. EXAMPLES OF SOME REGULARLY EXCLUDED WORKS INCLUDE DRIVEWAYS, RETAINING WALLS, SOLAR PANEL SPACING AND SITE DRAINAGE, PLEASE REFER TO YOUR SCOPE OF WORKS AND COLOUR SELECTIONS DOCUMENTATION FOR DETAILS OF INCLUDED WORKS. SOME DETAILS ARE INDICATIVE ONLY FOR EXAMPLE FLOORING, TILING, BRICKWORK AND CLADDING (EXPANSION JOINTS, ORIENTATION AND LAYOUT) AND ARE SUBJECT TO CHANGE.

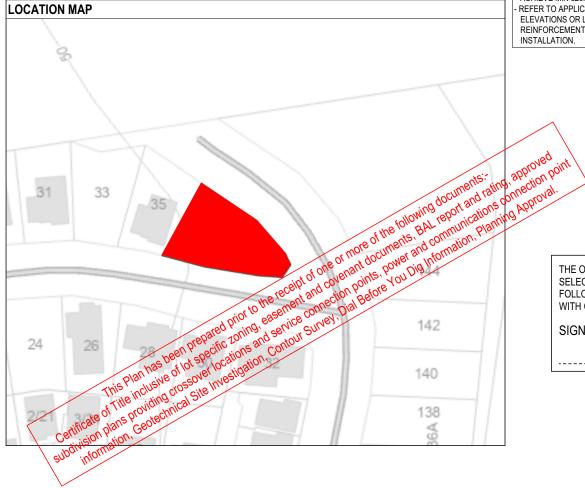

BUILDING INFORMATION

	GROUND FLOOR TOP OF WALL HEIGHT(S)	2445mm
	NOTE: CEILING HEIGHT 45mm LOWER THAI	N TOP OF WALL
	ROOF PITCH (U.N.O.)	23.0°
	ELECTRICITY SUPPLY	SINGLE PHASE
	GAS SUPPLY	NONE
	ROOF MATERIAL	SHEET METAL
	ROOF COLOUR	N/A
	WALL MATERIAL	BRICK VENEER
		CLADDING
1	SLAB CLASSIFICATION	TBC

INSULATION

ROOF	MIN. 60mm FOIL FACED BLANKET UNDER ROOFING
CEILING	R4.1 BATTS (EXCL. GARAGE, ALFRESCO)
EXT. WALLS	R2.0 BATTS (EXCL. GARAGE) WALL WRAP TO ENTIRE HOUSE
INT. WALLS	R2.0 BATTS ADJACENT TO GARAGE AND AS PER PLAN
FLOOR	BIAX SLAB R0.60

NCC 2022 LIVABLE HOUSING COMPLIANCE

ACCESSIBLE SANITARY COMPARTMENT: WC ACCESSIBLE SHOWER LOCATION: BATH

GENERAL NOTES:

- THRESHOLD OF ACCESSIBLE SHOWER ENTRY TO BE
- EXTERIOR DOOR NOMINATED AS 870 OR GREATER TO ACHIEVE MIN 820MM CLEAR OPENING
- REFER TO APPLICABLE WET AREA PLANS AND INTERIOR ELEVATIONS OR LOCATIONS OF REQUIRED WALL REINFORCEMENT FOR FUTURE GRAB RAIL INSTALLATION.

BUSHFIRE REQUIREMENTS - BAL-12.5

THE BUILDER USES MATERIALS THAT COMPLY WITH AS 3959-2018, NASH STANDARD STEEL FRAMED CONSTRUCTION IN BUSHFIRE AREAS 2014 OR HAVE BEEN TESTED TO AS 1530.8.1 IN ACCORDANCE WITH AS 3959-2018 (CLAUSE 3.8).

- PROVIDE FOIL FACED BLANKET INSULATION TO ALL COLORBOND SHEET ROOFING
- PROVIDE SARKING TO ALL TILED ROOFING INCLUDING PRESSTITE TO
- VALLEYS. PROVIDE BAL-12.5 RATED DEKTITE TO ALL AIR VENTS ON ROOF PROVIDE BAL-12.5 RATED ALUMINIUM MESH TO ALL SOFFIT AND EAVE
- PROVIDE BAL-12.5 RATED ALUMINIUM MESH TO ALL EXHAUST VENTS.

VALLS, POSTS AND BEAMS: PROVIDE SPARK ARRESTORS TO ALL EXTERNAL BRICKWORK.

- EXTERNAL TIMBER POSTS WITHIN 400mm OF ADJACENT FINISHED FLOOR LEVEL TO BE BUSHFIRE-RESISTING TIMBER UNLESS MOUNTED
- ON STIRRUPS TO PROVIDE MIN. 75mm CLEARANCE ABOVE ADJACENT FINISHED FLOOR LEVEL.

WINDOWS AND DOORS

- PROVIDE FLYSCREENS WITH CORROSION RESISTANT MESH TO ALL OPERABLE WINDOW SASHES (NO REQUIREMENT TO SCREEN BI-FOLD.)
- FRENCH / SLIDING / STACKER DOORS).
 PROVIDE BAL-12.5 RATED ALUMINIUM WINDOWS AND EXTERNAL GLASS
- SLIDING / STACKER DOORS.
 SPECIFIED ALUMINIUM FRENCH DOORS HAVE BEEN TESTED TO AS
- 1530.8.1 WITHOUT SCREENS. SPECIFIED ALUMINIUM WINDOWS HAVE BEEN TESTED TO AS 1530.8.1
- WITHOUT SCREENS TO FIXED PANELS.
 PROVIDE ALUMINIUM DOOR JAMBS TO ALL EXTERNAL TIMBER DOORS.
- PROVIDE SAFETY SCREENS WITH CORROSION RESISTANT MESH TO EXTERNAL TIMBER HUNG DOORS (IF REQUIRED)
- PROVIDE SEAL TO ALL GARAGE PANELIFT / ROLLER DOORS.

PROVIDE COPPER WATER PIPES FROM WATER TANK TO HOUSE.

THE OWNERS ACKNOWLEDGE THAT THESE CONTRACT PLANS MAY NOT REFLECT ALL THE SELECTIONS THAT HAVE BEEN MADE OR CHANGES REQUESTED. THE OWNERS AGREE THAT FOLLOWING THE COLOUR SELECTIONS VARIATION OR UPDATING OF PLANS. THEY WILL BE PROVIDED WITH CONSTRUCTION PLANS FOR SIGNATURE PRIOR TO COMMENCEMENT OF CONSTRUCTION.

SIGNATURE: DATE:

SUBJECT TO NCC 2022 (1 MAY 2023)

WATERPROOFING & PLUMBING **CONDENSATION MANAGEMENT**

PLAN ACCEPTANCE BY OWNER SIGNATURE: DATE: SIGNATURE: DATE:

PLEASE NOTE THAT VARIATIONS WILL NOT BE ACCEPTED AFTER THIS PLAN ACCEPTANCE HAS BEEN SIGNED.

PRELIMINARY PLAN SET

PRELIMINARY PLAN SET - INITIAL ISSUE

AMENDMENT

No.

ECIFICATION:		REVISION	
SCOVERY	3	DRAFT SALES PLAN - CT1 AMENDMENT	JII
PYRIGHT:	4	DRAFT SALES PLAN - CT1 - RE-SITING	JII
2025	5	DRAFT SALES PLAN - CT2	JII
	6	PRELIM PLANS - INITIAL ISSUE	TRV

ALL

SHEET

2025.10.09

DATE

25/09/2025 ADDRESS: 62 / - / 185338

TRV

DRAWN CHECK

11/09/2025 BIANCA JANELLE CALLINAN 01/10/2025 37 KOTONA STREET, ROKEBY TAS 7019 09/10/2025 LOT / SECTION / CT: COUNCIL .

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IN ANY WAY REPRODUCE, COPY, MODIFY, USE OR TAKE ADVANTAGE OF THE DRAWING TO BUILD A HOUSE BASED ON THIS PLAN (WHETHER IN WHOLE OR IN PART) WITHOUT THE PRIOR WRITTEN CONSENT OF WILSON HOMES PTY LTD.

CLARENCE

OUSE DESIGN HOUSE CODE PERTH 16 H-WDCPTH10SA FACADE DESIGN: FACADE CODE **CONTEMPO** F-WDCPTH10CTPOA SHEET TITLE: SHEET No.: SCALES:

1 / 24

1:100

COVER SHEET

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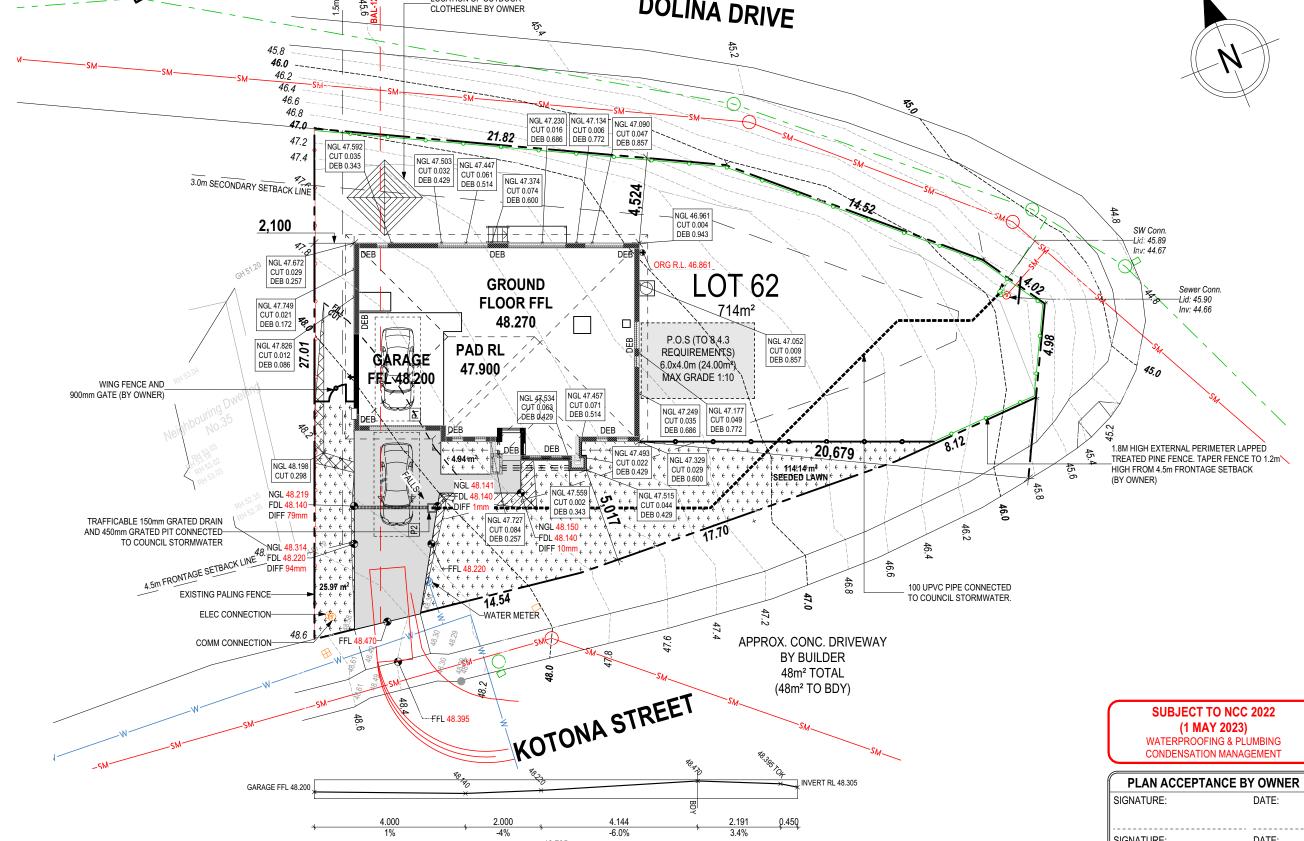
REFER TO SHEET 1 (COVER SHEET) FOR ALL BUILDING INFORMATION REGARDING: SUSTAINABILITY REQUIREMENTS SITE CLASSIFICATION GENERAL BUILDING INFORMATION

APPROX. CUT/FILL

114 TONNES OF IMPORT FILL								
DIFFERENCE	50.82m³	114.35t						
FILL	55.09m³	123.95t						
CUT	4.27m³	9.61t						

LOT SIZE: 714m² HOUSE (COVERED AREA): 161.50m² SITE COVERAGE: 22.62%

BAL-12.5 BUSHFIRE REQUIREMENTS SEE SHEET 1 (COVER SHEET) FOR DETAILS **DOLINA DRIVE** LOCATION OF OUTDOOR CLOTHESLINE BY OWNER



-0.8% AUSTRALIAN STANDARD DRIVEWAY PROFILE

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(1 MAY 2023)

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WILSON
HOMES

	SPECIFICATION:	REVISION	DRAWN CLIENT:		HOUSE DESIGN:		HOUSE CODE:	DO NOT SCALE DRAWINGS, USE	
\cap	DISCOVERY	3 DRAFT SALES PLAN - CT1 AMENDMENT	JII 11/09/2025 BIANCA JANELLE CALLI	INAN	PERTH 16 H-WDCPTH10SA FACADE DESIGN: FACADE CODE:		H-WDCPTH10SA	FIGURED DIMENSIONS ONLY. CHECK AND VERIFY DIMENSIONS AND LEVELS PRIOR TO THE	1.04
ш	COPYRIGHT:	4 DRAFT SALES PLAN - CT1 - RE-SITING	JII 25/09/2025 ADDRESS:					COMMENCEMENT OF ANY WORK. ALL	
	© 2025	5 DRAFT SALES PLAN - CT2	JII 01/10/2025 37 KOTONA STREET, RO	OKEBY TAS 7019	CONTEMPO		F-WDCPTH10CTPOA	DISCREPANCIES TO BE REPORTED TO THE DRAFTING OFFICE.	/ersic
		6 PRELIM PLANS - INITIAL ISSUE		COUNCIL:	SHEET TITLE:	SHEET No.:	SCALES:	71///0	ate
		7	62 / - / 185338	CLARENCE	SITE PLAN	2 / 24	1:200	714448 	dua

ALL VEGETATION OUTSIDE THE BUILDING ZONE WILL BE MAINTAINED.

OWNER TO STABILISE THE SITE ON COMPLETION OF THE BUILD WITH TURF LAWNS, GRASS SEEDS, NATIVE GROUND COVERS AND/ OR MULCH SPREAD TO A DEPTH OF 75-100mm

THE FOLLOWING IS A STANDARD APPROACH. SEDIMENT AND EROSION CONTROL MEASURES WILL BE REVIEWED PRIOR TO COMMENCING WORK AND INSTALLED BASED ON THE OUTCOME OF THAT REVIEW.

1. ALL EROSION AND SEDIMENT CONTROL STRUCTURES TO BE INSPECTED EACH WORKING DAY AND MAINTAINED IN GOOD WORKING ORDER.

- 2. ALL GROUND COVER VEGETATION OUTSIDE THE IMMEDIATE BUILDING AREA TO BE PRESERVED DURING THE BUILDING
- 3. ALL EROSION AND SEDIMENT CONROL MEASURES TO BE INSTALLED PRIOR TO COMMENCEMENT OF MAJOR EARTHWORKS.
- 4. STOCKPILES OF CLAYEY MATERIAL TO BE COVERED WITH AN IMPERVIOUS SHEET. 5. ROOF WATER DOWNPIPES TO BE CONNECTED TO THE PERMAMENT UNDERGROUND STORMWATER DRAINAGE SYSTEM AS SOON AS PRACTICAL AFTER

THE ROOF IS LAID.

50 x 25 x 1000

STAR PICKET

NATURAL SURFACE

DOWNHILL OF MEMBRANE

NOT TO BE DISTURBED

STAKE OR

MEMBRANE TO BE BIDIM U24

OR APPROVED EQUIVALENT

BURY APPROXIMATELY 150mm

NATURAL SURFACE LEVEL


SILT FENCING DETAIL

OF MEMBRANE AND TEMPORARILY
BACKFILL TO RESTORE PRIOR


GEOTEXTILE

FABRIC

6. DIVERSION DRAINS ARE TO BE CONNECTED TO A LEAGAL DISCHARGE POINT (COUNCIL STORMWATER SYSTEM, WATERCOURSE OR ROAD DRAIN). 7. SEDIMENT RETENTION TRAPS INSTALLED AROUND THE INLETS TO THE STORMWATER SYSTEM TO PREVENT SEDIMENT & OTHER DEBRIS BLOCKING THE DRAINS.

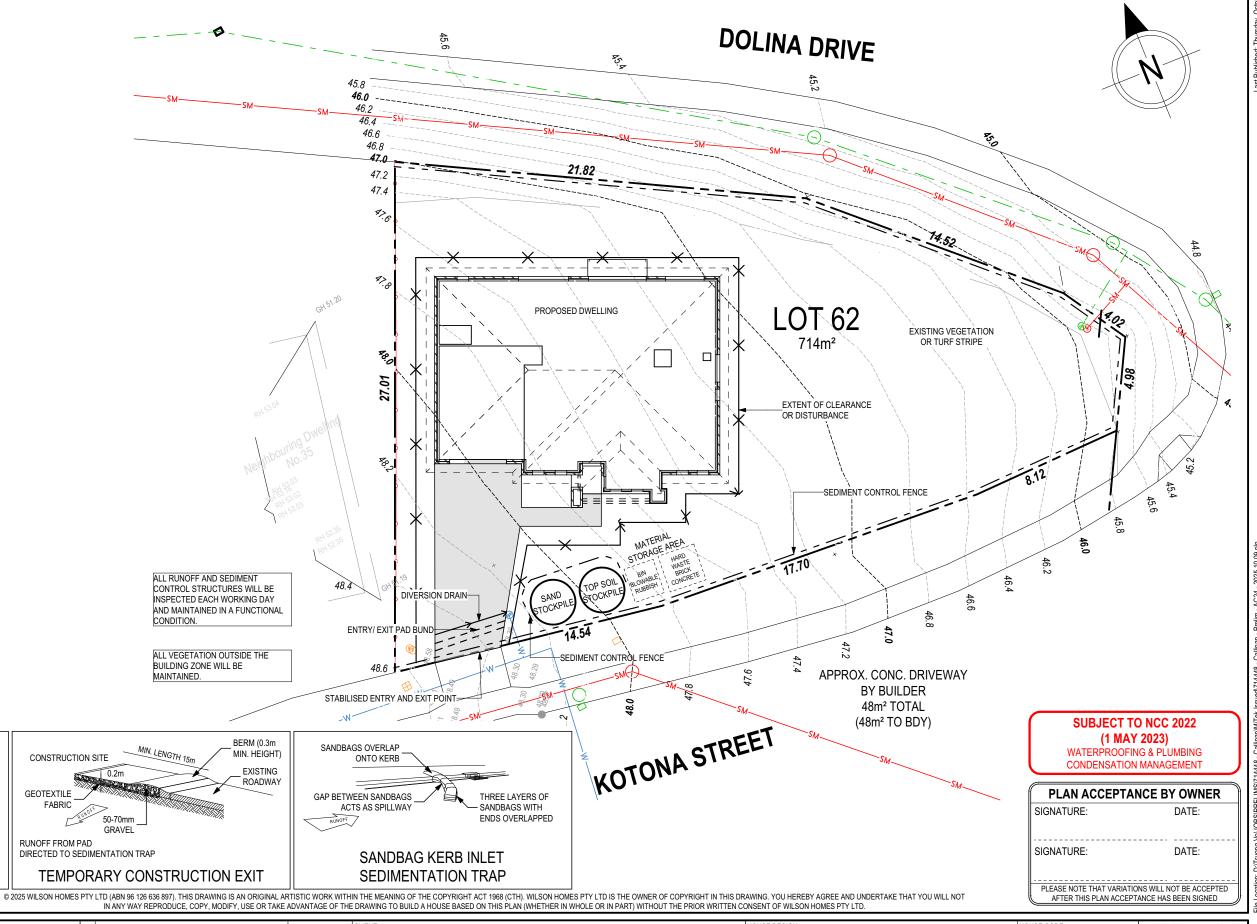

HOUSE CODE DO NOT SCALE DRAWINGS, USE REVISION FIGURED DIMENSIONS ONLY, CHEC DISCOVERY JII 11/09/2025 BIANCA JANELLE CALLINAN PERTH 16 H-WDCPTH10SA 3 DRAFT SALES PLAN - CT1 AMENDMENT AND VERIFY DIMENSIONS AND I EVELS PRIOR TO THE JII 25/09/2025 ADDRESS: FACADE DESIGN: FACADE CODE: COMMENCEMENT OF ANY WORK. AL DISCREPANCIES TO BE REPORTED TO THE DRAFTING OFFICE. 4 DRAFT SALES PLAN - CT1 - RE-SITING F-WDCPTH10CTPOA JII 01/10/2025 37 KOTONA STREET, ROKEBY TAS 7019 **CONTEMPO** 5 DRAFT SALES PLAN - CT2 TRV 09/10/2025 LOT / SECTION / CT: SHEET TITLE: 6 PRELIM PLANS - INITIAL ISSUE COUNCIL: SHEET No.: SCALES: 714448 3 / 24 1:200 62 / - / 185338 CLARENCE SOIL & WATER MANAGEMENT PLAN

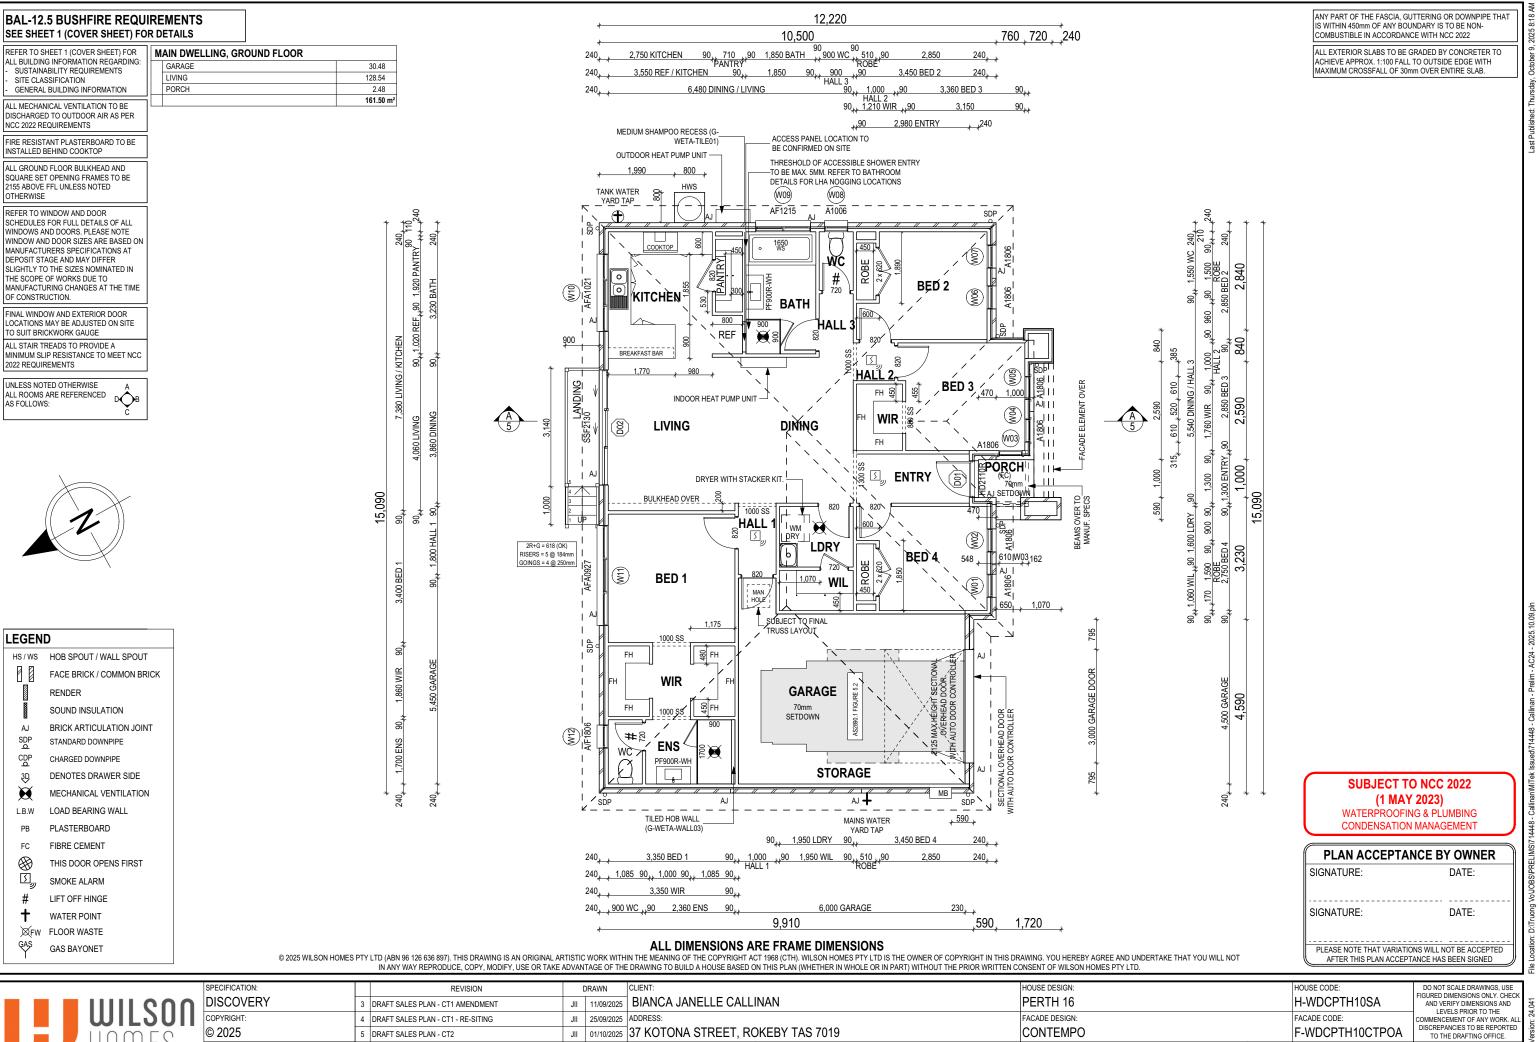

COUNCIL:

CLARENCE

SHEET TITLE:

GROUND FLOOR PLAN

SHEET No.:

4 / 24

SCALES


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TRV 09/10/2025 LOT / SECTION / CT:

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6 PRELIM PLANS - INITIAL ISSUE

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REFER TO SHEET 1 (COVER SHEET) FOR ALL BUILDING INFORMATION REGARDING: **BAL-12.5 BUSHFIRE REQUIREMENTS** SEE SHEET 1 (COVER SHEET) FOR DETAILS SOME DETAILS ON THIS SHEET ARE INDICATIVE ONLY FOR EXAMPLE BUILDING ENVELOPE BENEATH TO BE RESTRICTED AS REQUIRED BY NCC 11.3.7 (VOLUME RL 53.052 - RIDGE LEVEL COLORBOND CORRUGATED / -COLORBOND CAPPING CUSTOM ORB METAL ROOFING + _590 x 1070mm FACE BRICK PIER WITH 90mm GAL, SHS TO CORE RL 50.715 - TOP OF WALL RL 48.270 - GROUND FLOOR RL 47.900 - PAD LEVEL -ARTICULATED FACE BRICKWORK SINGLE PHASE METER BOX-SELECTED N.C.C. COMPLIANT EXISTING GROUND LEVEL BALUSTRADE MIN. 1000mm OFF FFL NORTH WEST ELEVATION SCALE: 1:100 RL 53.052 - RIDGE LEVEL COLORBOND CAPPING COLORBOND CORRUGATED /
-CUSTOM ORB METAL ROOFING + FOIL FACED BLANKET RL 50.715 - TOP OF WALL RL 48.270 - GROUND FLOOR RL 47.900 - PAD LEVEL DEB HOT WATER SERVICE-SELECTED N.C.C. COMPLIANT

BALUSTRADE MIN. 1000mm OFF _JAMES HARDIE FINE TEXTURE CLADDING ARTICULATED FACE BRICKWORK-EXISTING GROUND LEVEL SOUTH EAST ELEVATION SCALE: 1:100 WINDOW TYPE LEGEND PLAN ACCEPTANCE BY OWNER SIGNATURE: **GLASS TYPE LEGEND** SIGNATURE: LOW REFLECTANCE GLAZING TO BE USED ON WINDOWS AND GLAZED DOORS AS DOUBLE OBSCURE FIXED SLIDING LOUVRE REQUIRED BY CLA-S4.7.1 HUNG

SUBJECT TO NCC 2022 (1 MAY 2023)

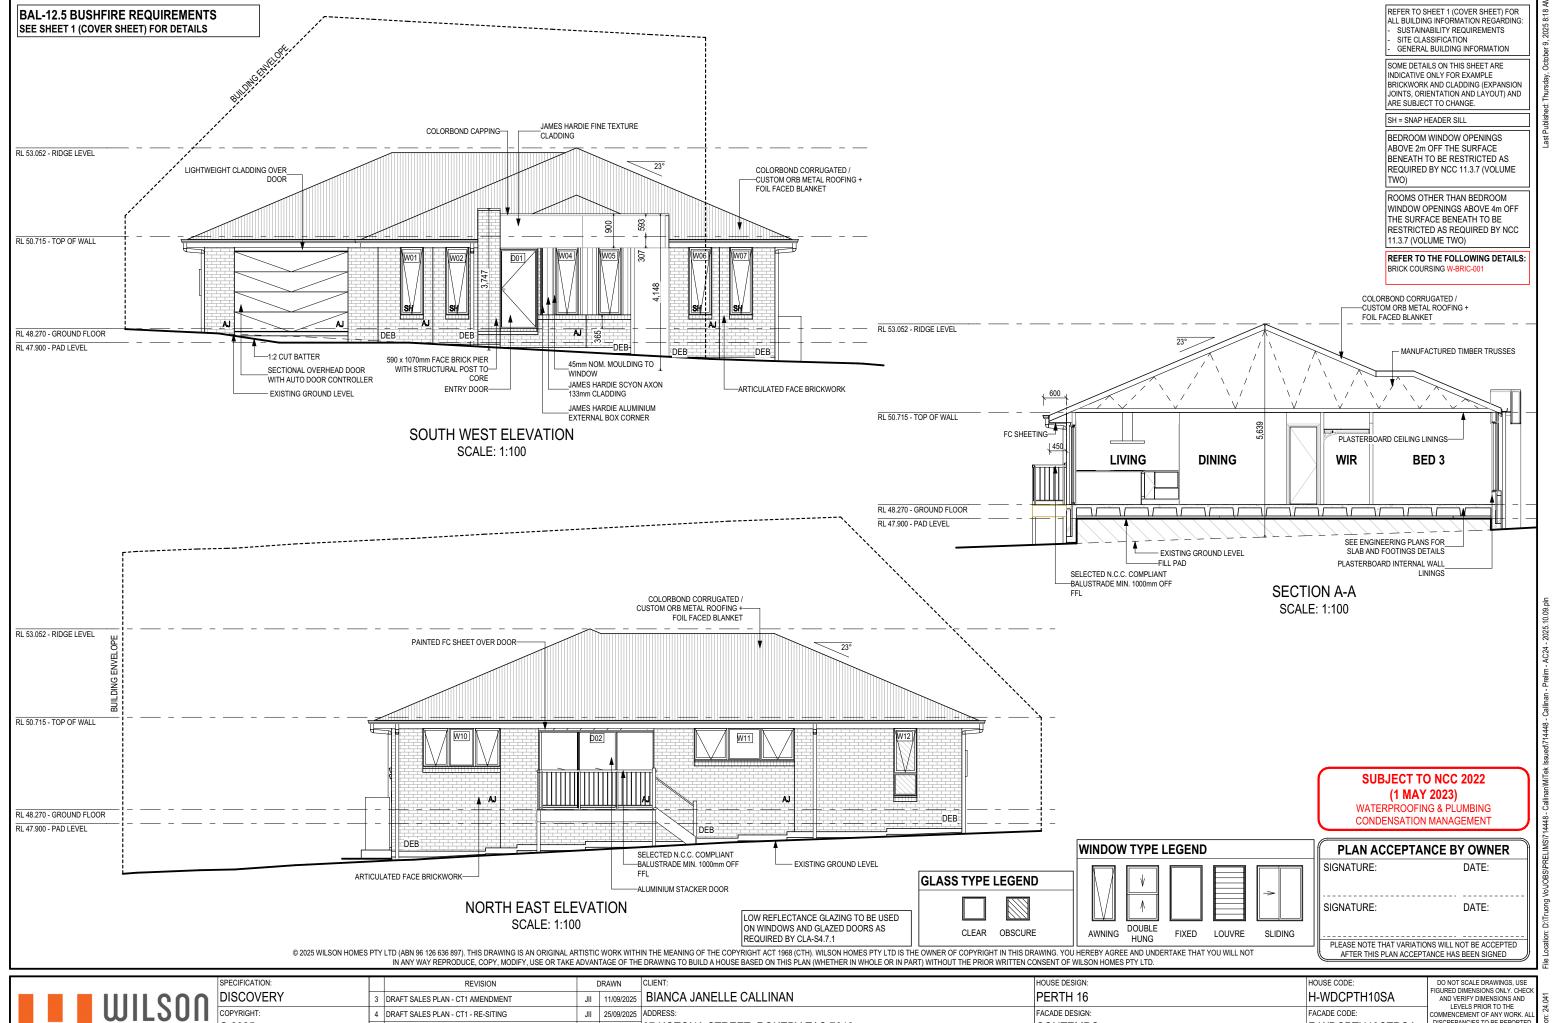SUSTAINABILITY REQUIREMENTS SITE CLASSIFICATION GENERAL BUILDING INFORMATION

BRICKWORK AND CLADDING (EXPANSION JOINTS, ORIENTATION AND LAYOUT) AND

BEDROOM WINDOW OPENINGS ABOVE 2m OFF THE SURFACE

ROOMS OTHER THAN BEDROOM

11.3.7 (VOLUME TWO)

WINDOW OPENINGS ABOVE 4m OFF THE SURFACE BENEATH TO BE RESTRICTED AS REQUIRED BY NCC

REFER TO THE FOLLOWING DETAILS: BRICK COURSING W-BRIC-001

ARE SUBJECT TO CHANGE. SH = SNAP HEADER SILL

WATERPROOFING & PLUMBING CONDENSATION MANAGEMENT

DATE:

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714448

DATE:

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PECIFICATION:	REVISION	[DRAWN	CLIENT:		HOUSE DESIGN:		HOUSE CODE:		
DISCOVERY	3 DRAFT SALES PLAN - CT1 AMENDMENT	JII	11/09/2025	BIANCA JANELLE CALL	INAN	PERTH 16		H-WDCPTH10SA		
OPYRIGHT:	4 DRAFT SALES PLAN - CT1 - RE-SITING	JII	25/09/2025	ADDRESS:		FACADE DESIGN:		FACADE CODE:		
2025	5 DRAFT SALES PLAN - CT2	JII	01/10/2025	37 KOTONA STREET, RO	DKEBY TAS 7019	CONTEMPO		F-WDCPTH10CTP		
	6 PRELIM PLANS - INITIAL ISSUE	TRV	09/10/2025	LOT / SECTION / CT:	COUNCIL:	SHEET TITLE:	SHEET No.:	SCALES:		
	7			62 / - / 185338	CLARENCE	ELEVATIONS	6 / 24	1:100		

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NOTE:

Provide BAL-12.5 rated aluminium windows and external glass sliding doors in lieu of standard.

Provide flyscreens with corrosion resistant mesh to all opening window sashes only.

LOW REFLECTANCE GLAZING TO BE USED ON WINDOWS AND GLAZED DOORS AS REQUIRED BY CLA-S4.7.1

No BAL / BAL 12.5			
Window Type	WERS Code	U Value	SHGC
Sliding Window	DOW-022-003	2.9	0.64
Awning Window	DOW-005-001	3.9	0.58
Fixed External Window	DOW-038-001	3.03	0.71
Sliding Door	DAR-034-001	3.97	0.63
Stacking Door	DAR-034-001	3.97	0.63
Hinged Door	DOW-017-001	4.1	0.55
Bi-Fold Door	DOW-020-001	4.1	0.54
BAL 19			
Window Type	WERS Code	U Value	SHGC
Sliding Window	TND-034-001	3.1	0.61
Awning Window	STG-001-066	3.91	0.54
Fixed External Window	DOW-038-005	3.02	0.66
Sliding Door	AUW-009-009	4.03	0.58
Stacking Door	AUW-009-009	4.03	0.58
Hinged Door	GRN-009-001	4.25	0.53
Bi-Fold Door	DOW-020-001	4.1	0.54
BAL 29			
Window Type	WERS Code	U Value	SHGC
Sliding Window	TND-034-001	3.1	0.61
Awning Window	STG-001-066	3.91	0.54
Fixed External Window	DOW-038-005	3.02	0.66
Olidia a Dana	AMJ-007-005	4.03	0.59
Sliding Door			
Stacking Door	AMJ-007-005	4.03	0.59

Window Manufacturer: Dowell Windows

INTERIOR WINDOW & DOOR SCHEDULE

STOREY	QTY	CODE	TYPE	HEIGHT	WIDTH	GLAZING TYPE	ADDITIONAL INFORMATION						
DOOR													
GROUND FLOOR	4	1000 SS	SQUARE SET OPENING	2,155	1,000	N/A							
GROUND FLOOR	1	1300 SS	SQUARE SET OPENING	2,155	1,300	N/A							
GROUND FLOOR	2	2 x 620	SWINGING	2,040	1,240	N/A							
GROUND FLOOR	1	720	SWINGING	2,040	720	N/A							
GROUND FLOOR	2	720	SWINGING	2,040	720	N/A	LIFT-OFF HINGES						
GROUND FLOOR	8	820	SWINGING	2,040	820	N/A							
GROUND FLOOR	1	850 SS	SQUARE SET OPENING	2,155	850	N/A							

PICTURE, TV RECESS AND SS WINDOW OPENINGS

QTY | TYPE | HEIGHT | WIDTH | AREA (m²)

their openability restricted as per N.C.C 11.3.6.

Windows supplied MUST HAVE Uw better and or equal to stated figures

and SHGC within +/- 5% of stated figures. Restricted windows to have

BAL-12.5 BUSHFIRE REQUIREMENTS

NOTE: INTERNAL DOORS TO WET AREAS WITH MECHANICAL VENTILATION TO BE UNDERCUT 20mm

SEE SHEET 1 (COVER SHEET) FOR DETAILS

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SUBJECT TO NCC 2022 (1 MAY 2023)

WATERPROOFING & PLUMBING CONDENSATION MANAGEMENT

PLAN ACCEPTANCE BY OWNER SIGNATURE: DATE:

SIGNATURE: DATE:

PLEASE NOTE THAT VARIATIONS WILL NOT BE ACCEPTED
AFTER THIS PLAN ACCEPTANCE HAS BEEN SIGNED



REFER TO SHEET 1 (COVER SHEET) FOR

SUSTAINABILITY REQUIREMENTS

GENERAL BUILDING INFORMATION

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	SPECIFICATION:	REVISION	[DRAWN	CLIENT:			HOUSE DESIGN:		HOUSE CODE:	DO NOT SCALE DRAWINGS, USE	i
1	DISCOVERY	3 DRAFT SALES PLAN - CT1 AMENDMENT	JII	11/09/2025	BIANCA JANELLE CALL	IANCA JANELLE CALLINAN PE		PERTH 16		H-WDCPTH10SA	FIGURED DIMENSIONS ONLY. CHECK AND VERIFY DIMENSIONS AND LEVELS PRIOR TO THE	1.04
ı		DRAFT SALES PLAN - CT1 - RE-SITING	1	25/09/2025		DRESS: F		FACADE DESIGN:			COMMENCEMENT OF ANY WORK. ALL	
	© 2025 5	DRAFT SALES PLAN - CT2	JII	01/10/2025	37 KOTONA STREET, RO	KOTONA STREET, ROKEBY TAS 7019		CONTEMPO		F-WDCPTH10CTPOA	DISCREPANCIES TO BE REPORTED TO THE DRAFTING OFFICE.	/ersic
	6	PRELIM PLANS - INITIAL ISSUE	TRV	09/10/2025		COUNCIL:		SHEET TITLE:	SHEET No.:	SCALES:	711110	late \
	7	7			62 / - / 185338	CLARENCE		WINDOW & DOOR SCHEDULES	7 / 24		714448	i iii

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NATURAL LIGHT AND VENTILATION										
ROOM	AREA (m2)	WINDOW ID	LIGHT REQUIRED (m2)	LIGHT ACHIEVED (m2)	VENTILATION REQ`D (m2)	VENTILATION ACH'D (m2)				
OPEN KITCHEN/ LIVING/ DINING	35.32 m²	W10, D02	3.53 m²	7.26 m²	1.77 m²	5.27 m²				
BED 1	11.39 m²	W11	1.14 m²	1.74 m²	0.57 m²	1.38 m²				
BED 2	9.46 m²	W06, W07	0.95 m²	1.62 m²	0.47 m²	2.00 m ²				
BED 3	9.19 m²	W03, W04, W05	0.92 m²	2.43 m²	0.46 m²	3.00 m²				
BED 4	9.14 m²	W01, W02	0.91 m²	1.62 m²	0.46 m²	2.00 m²				

PART 10.5.1 LIGHT: Minimum 10% of the floor area of a habitable room required (natural light)

PART 10.6 VENTILATION: Minimum 5% of the floor area of a habitable room required. (An exhaust fan may be used for sanitary compartment, laundry or bathroom provided contaminated air discharges directly to the outside of the building by way of ducts).

> **SUBJECT TO NCC 2022** (1 MAY 2023)

WATERPROOFING & PLUMBING CONDENSATION MANAGEMENT

PLAN ACCEPTANCE BY OWNER						
SIGNATURE:	DATE:					
SIGNATURE:	DATE:					
PLEASE NOTE THAT VARIATIONS	WILL NOT BE ACCEPTED					
AFTER THIS PLAN ACCEPTAN	CE HAS BEEN SIGNED					

SUSTAINABILITY REQUIREMENTS SITE CLASSIFICATION GENERAL BUILDING INFORMATION

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© 2025	5 DRAFT SALES PLAN - CT2	JII 01/10/2025 37 KOTONA STREE	ET, ROKEBY TAS 7019	CONTEMPO	F-WDCPTH10CTPC	DISCREPANCIES TO BE REPORTED TO THE DRAFTING OFFICE.							
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	7	62 / - / 185338	CLARENCE	CALCULATIONS	8 / 24	114440							

SCALE: 1:10


5 DRAFT SALES PLAN - CT2

6 PRELIM PLANS - INITIAL ISSUE

STANDARD BRICK STANDARD BRICK															
BRICKWORI	K DIMENSIC	NS Bricks p	er m² in wall	= 48.5 appro	ox.	all dimen	sions in mm	n BRICKWORK DIMENSIONS Bricks per m² in wall = 48.5 approx. all dimensions in mn					sions in mm		
				AL GAUGE: s to 600mm		FORMAT SIZ 240x120x86r		MANUFACTURING SIZE: 230x110x76mm			VERTICAL GAUGE: 7 Courses to 600mm				
NO. OF BRICKS	LENGTH	OPENING	HEIGHT	NO. OF BRICKS	LENGTH	OPENING	HEIGHT	NO. OF BRICKS	LENGTH	OPENING	HEIGHT	NO. OF BRICKS	LENGTH	OPENING	HEIGHT
1	230	250	86	26	6230	6250	2229	11	2630	2650	943	36 ¹ 2	8630		3086
1 ¹ 2	350	370		26 ¹ ₂	6350	6370		11 ¹ 2	2750	2770		36 ¹ 2	8750		
2	470	490	172	27	6470	6490	2314	12	2870	2890	1029	37	8870		3172
212	590	610		27 ¹ ₂	6590	6610		12 ¹ 2	2990	3010		37 ¹ 2	8990	i	
3	710	730	257	28	6710	6730	2400	13	3110	3130	1114	38	9110	LENGTH.	3257
3 ¹ 2	830	850		28 ¹ ₂	6830	6850		13 ¹ 2	3230	3250		38 ¹ ₂	9230	N. I	
4	950	970	343	29	6950	6970	2486	14	3350	3370	1200	39	9350		3343
412	1070	1090		29 ¹ ₂	7070	7090		1412	3470	3490		39 ¹ ₂	9470	2	
5	1190	1210	429	30	7190	7210	2572	15	3590	3610	1286	40	9590	20 .	3429
5 ¹ 2	1310	1330		30 ¹ ₂	7310	7330		15 ¹ 2	3710	3730		40 ¹ ₂	9710		
6	1430	1450	514	31	7430	7450	2657	16	3830	3850	1372	41	9830	AD	3514
6 ¹ 2	1550	1570		31 ¹ 2	7550	7570		16 ¹ 2	3950	3970		41 ¹ 2	9950		
7	1670	1690	600	32	7670	7690	2743	17	4070	4090	1457	42	10070	NEEDED	3600
712	1790	1810		32 ¹ 2	7790	7810		1712	4190	4210		42 ¹ 2	10190	Ш	
8	1910	1930	686	33	7910	7930	2829	18	4310	4330	1543	43	10310		3686
812	2030	2050		33 ¹ 2	8030	8050		18 ¹ 2	4430	4450		43 ¹ ₂	10430	Ľ	
9	2150	2170	772	34	8150	8170	2914	19	4550	4570	1629	44	10550	G	3772
9 ¹ ₂	2270	2290		34 ¹ 2	8270	8290		19 ¹ 2	4670	4690		44 ¹ 2	10670	REQUIRED.	
10	2390	2410	857	35	8390	8400	3000	20	4790	4810	1714	45	10790	2	3857
								2012	4910	4930		45 ¹ ₂	10910	Ä	
								21	5030	5050	1800	46	11030		3943
								21 ¹ 2	5150	5170		46 ¹ ₂	11150	OFTEN	
								22	5270	5290	1886	47	11270	J-C	4029
								22 ¹ ₂	5390	5410		47 ¹ ₂	11390		
								23	5510	5530	1972	48	11510	NOT	4114
								2312	5630	5650		48 ¹ ₂	11630		
								24	5750	5770	2057	49	11750		4200
								2412	5870	5890		49 ¹ ₂	11870		
								25	5990	6010	2143	50	11990]	4286

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CONTEMPO

DETAILS (FACE BRICKWORK)

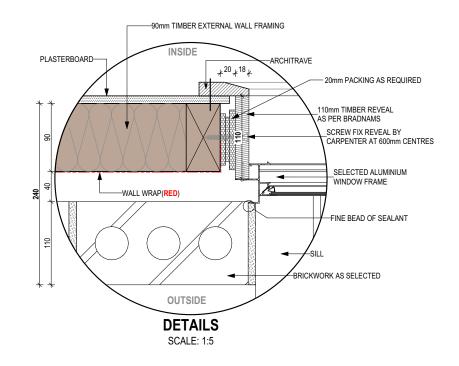SHEET TITLE:

SUBJECT TO NCC 2022 (1 MAY 2023)

100 23990

8572

WATERPROOFING & PLUMBING CONDENSATION MANAGEMENT

PLAN ACCEPTANCE BY OWNER						
SIGNATURE:	DATE:					
SIGNATURE:	DATE:					
	ONS WILL NOT BE ACCEPTED TANCE HAS BEEN SIGNED					

HOUSE CODE:

FACADE CODE:

SHEET No.: SCALES:

9 / 24

H-WDCPTH10SA

REFER TO SHEET 1 (COVER SHEET) FOR ALL BUILDING INFORMATION REGARDING: SUSTAINABILITY REQUIREMENTS SITE CLASSIFICATION

SEE SHEET 1 (COVER SHEET) FOR DETAILS

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GENERAL BUILDING INFORMATION


	,			
SPECIFICATION:	REVISION	DRAWN	CLIENT:	HOUSE DESIGN:
DISCOVERY	3 DRAFT SALES PLAN - CT1 AMENDMENT	JII 11/09/2025	BIANCA JANELLE CALLINAN	PERTH 16
COPYRIGHT:	4 DRAFT SALES PLAN - CT1 - RE-SITING	JII 25/09/2025	ADDRESS:	FACADE DESIGN:

JII 01/10/2025 37 KOTONA STREET, ROKEBY TAS 7019

TRV 09/10/2025 LOT / SECTION / CT:

62 / - / 185338

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THIS PLAN ACCEPTED BY: PLEASE NOTE: NO VARIATIONS WILL BE ACCEPTED ON THIS PLAN AFTER SIGNING SIGNATURE:

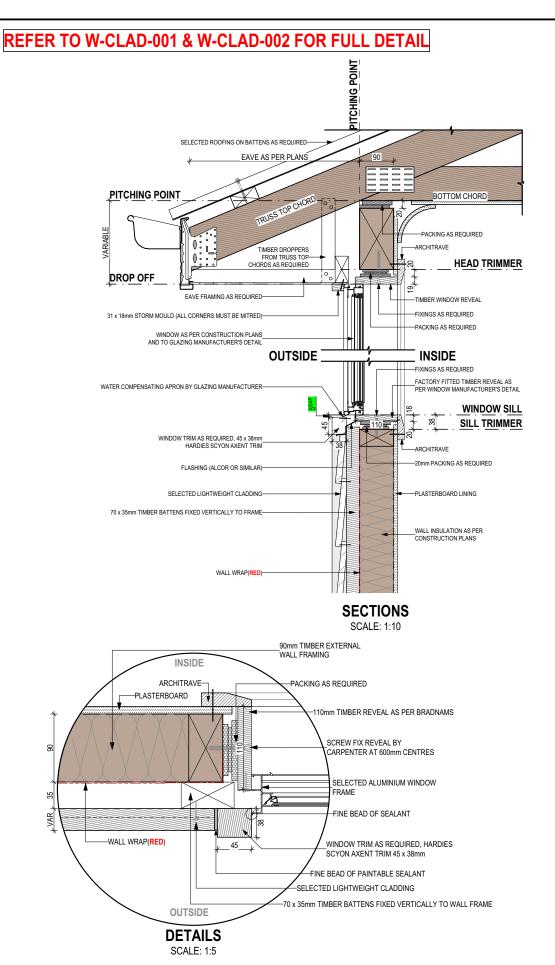
DATE:

SHEET CLADDING

THIS DWELLING IS BEING CONSTRUCTED IN A BAL-12.5 AREA © 2025 WILSON HOMES PTY LTD (ABN 96 126 636 897). THIS DRAWING IS AN ORIGINAL ARTISTIC WORK WITHIN THE MEANING OF THE COPYRIGHT ACT 1968 (CTH). WILSON HOMES PTY LTD IS THE OWNER OF COPYRIGHT IN THIS DRAWING. YOU HEREBY AGREE AND UNDERTAKE THAT YOU WILL NOT RESTRICTIONS FOR CONSTRUCTION METHODS/ MATERIALS APPLY. REFER TO NOTES IN ANY WAY REPRODUCE, COPY, MODIFY, USE OR TAKE ADVANTAGE OF THE DRAWING TO BUILD A HOUSE BASED ON THIS PLAN (WHETHER IN WHOLE OR IN PART) WITHOUT THE PRIOR WRITTEN CONSENT OF WILSON HOMES PTY LTD.



	SPECIFICATION:	REVISION	DRAWN	CLIENT:		HOUSE DESIGN:		HOUSE CODE:	DO NOT SCALE DRAWINGS, USE FIGURED DIMENSIONS ONLY, CHECK	
)	DISCOVERY	DRAFT SALES PLAN - CT1 AMENDMENT	JII 11/09	BIANCA JANELLE CALL	INAN	PERTH 16		H-WDCPTH10SA	AND VERIFY DIMENSIONS AND LEVELS PRIOR TO THE	.04 -
	COPYRIGHT: 4	DRAFT SALES PLAN - CT1 - RE-SITING		2025 ADDRESS:		FACADE DESIGN:			COMMENCEMENT OF ANY WORK. ALL	77. :UC
	© 2025	DRAFT SALES PLAN - CT2	JII 01/10	2025 37 KOTONA STREET, RO	OKEBY TAS 7019	CONTEMPO		F-WDCPTH10CTPOA	DISCREPANCIES TO BE REPORTED TO THE DRAFTING OFFICE.	/ersic
	6	PRELIM PLANS - INITIAL ISSUE	TRV 09/10	2025 LOT / SECTION / CT:	COUNCIL:		SHEET No.:	SCALES:	711110	ate
	7			62 / - / 185338	CLARENCE	DETAILS (CLADDING)	10 / 24		714448	Lemp

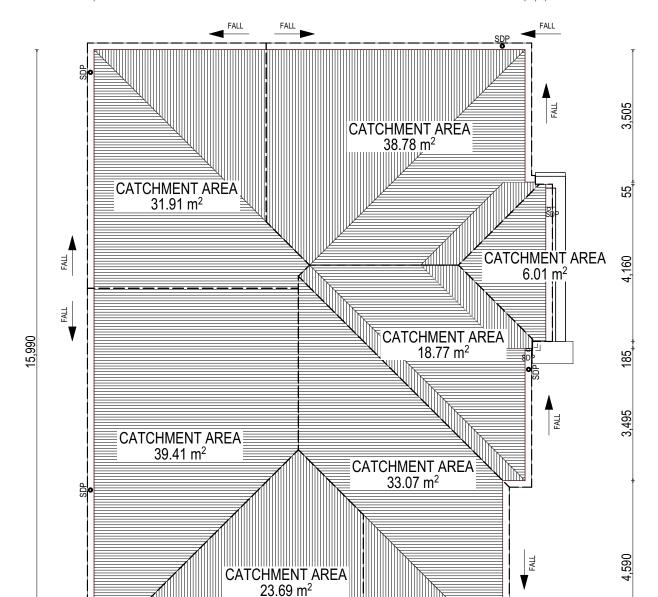

FALL

10,810

590 550

WHERE DOWNPIPES ARE FURTHER THAN 1.2m AWAY FROM VALLEY REFER TO N.C.C. 7.3.5(2)

POSITION AND QUALITY OF DOWNPIPES ARE NOT TO BE ALTERED WITHOUT CONSULTATION WITH DESIGNER.

AREA'S SHOWN ARE SURFACE AREAS/ CATCHMENT AREAS, NOT PLAN AREAS

Roofi	ng Data	
	181.92	Flat Roof Area (excluding gutter and slope factor) (m²)
	197.66	Roof Surface Area (includes slope factor, excludes gutter) (m²)
Dowr	pipe roof	calculations (as per AS/NZA3500.3:2021)
Ah	191.65	Area of roof catchment (including 115mm Slotted Quad Gutter) (m²)
Ac	231.90	Ah x Catchment Area Multiplier for slope (Table 3.4.3.2 from AS/NZS 3500.3:2021) (1.21 for 23° pitch) (m²)
Ae	6300	Cross sectional area of 57 x 115 Slotted Quad Gutter (mm²)
DRI	XX	Design Rainfall Intensity (determined from Table E1 from AS/NZS 3500.3:2021)
Acdp	64	Catchment area per Downpipe (determined from Figure 3.5(A) from AS/NZS 3500.3:2021) (m²)
Required Downpipes	3.62	Ac / Acdp
Downpipes Provided	7	

SOFFIT EAVE VENT PROPOSED LOCATION TO BE MIN. 1M FROM CORNER JOINT

SUBJECT TO NCC 2022 (1 MAY 2023)

WATERPROOFING & PLUMBING CONDENSATION MANAGEMENT

PLAN ACCEPTA	ANCE BY OWNER
SIGNATURE:	DATE:
SIGNATURE:	DATE:
	TIONS WILL NOT BE ACCEPTED

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	SPECIFICATION:	REVISION		DRAWN	CLIENT:			HOUSE DESIGN:		HOUSE CODE:	DO NOT SCALE DRAWINGS, USE	1
\cap	DISCOVERY	3 DRAFT SALES PLAN - CT1 AMENDMENT	JII	11/09/2025	BIANCA JANELLE CALL	INAN		PERTH 16		H-WDCPTH10SA	FIGURED DIMENSIONS ONLY. CHECK AND VERIFY DIMENSIONS AND	140
Ш	COPYRIGHT:	4 DRAFT SALES PLAN - CT1 - RE-SITING			ADDRESS:			FACADE DESIGN:			LEVELS PRIOR TO THE COMMENCEMENT OF ANY WORK. ALL	
	© 2025	5 DRAFT SALES PLAN - CT2	JII	01/10/2025	37 KOTONA STREET, RO	OKEBY TAS 7019		CONTEMPO		F-WDCPTH10CTPOA	DISCREPANCIES TO BE REPORTED TO THE DRAFTING OFFICE.	/ersic
		6 PRELIM PLANS - INITIAL ISSUE	TRV	09/10/2025		COUNCIL:		SHEET TITLE:	SHEET No.:		714448	late \
	[7			62 / - / 185338	CLARENCE		ROOF DRAINAGE PLAN	11 / 24	1:100	<i>I</i> 14440	Jemp

- SITE CLASSIFICATION
- GENERAL BUILDING INFORMATION

FLOOR TILES SHOWN ON PLAN DO NOT INDICATE THE SIZE OR JOINT LOCATIONS OF THE ACTUAL FLOOR TILES.
TIMBER FLOORING SHOWN ON PLAN DOES

NOT INDICATE THE BOARD SIZE OR DIRECTION OF THE ACTUAL FLOORING.

COVERINGS LEGEND

NO COVERING

COVER GRADE CONCRETE

CARPET


LAMINATE

LAMII

TILE (STANDARD WET AREAS)

TILE (UPGRADED AREAS)

DECKING

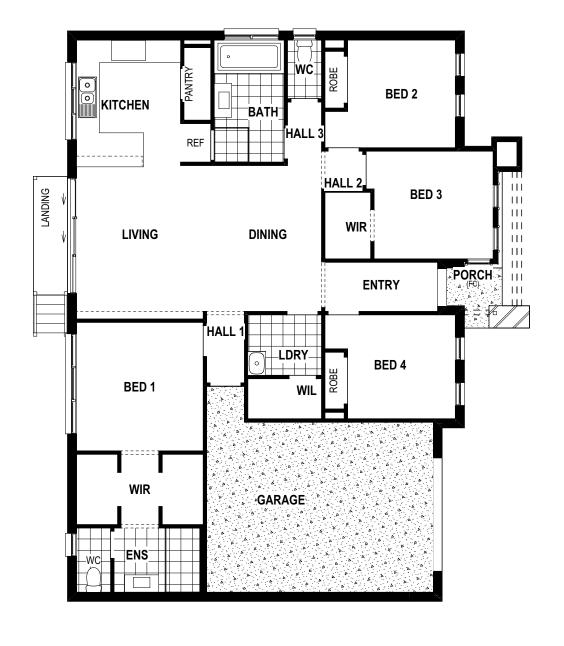

SUBJECT TO NCC 2022 (1 MAY 2023)

CONDENSATION MANAGEMENT

PLAN ACCEPTANCE BY OWNER SIGNATURE: DATE:

SIGNATURE: DATE:

PLEASE NOTE THAT VARIATIONS WILL NOT BE ACCEPTED
AFTER THIS PLAN ACCEPTANCE HAS BEEN SIGNED

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AND VERIFY DIMENSIONS AND LEVELS PRIOR TO THE COMMENCEMENT OF ANY WORK. AL DISCREPANCIES TO BE REPORTED TO THE DRAFTING OFFICE.

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BAL-12.5 BUSHFIRE REQUIREMENTS
SEE SHEET 1 (COVER SHEET) FOR DETAILS

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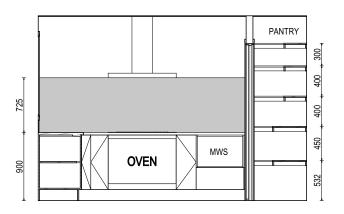


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CATION:	REVISION	DRAWN	CLIENT:		HOUSE DESIGN:		HOUSE CODE:	ĺ
OVERY	3 DRAFT SALES PLAN - CT1 AMENDMENT	JII 11/09/202	BIANCA JANELLE CAL	LINAN	PERTH 16		H-WDCPTH10SA	FI
SHT:	4 DRAFT SALES PLAN - CT1 - RE-SITING		5 ADDRESS:		FACADE DESIGN:		FACADE CODE:	CC
5	5 DRAFT SALES PLAN - CT2	JII 01/10/202	37 KOTONA STREET, F	ROKEBY TAS 7019	CONTEMPO		F-WDCPTH10CTPOA	ا ا
	6 PRELIM PLANS - INITIAL ISSUE	TRV 09/10/202	LOT / SECTION / CT:			SHEET No.:	SCALES:	1
	7		62 / - / 185338	CLARENCE	FLOOR COVERINGS	12 / 24	1:100	ĺ


ate Version: 24.041 File Location: D:\Truong Vo\UOBS\PRELIMS\7144

SITE CLASSIFICATION GENERAL BUILDING INFORMATION


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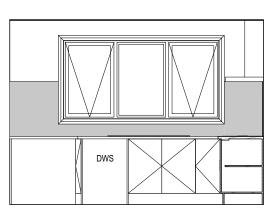
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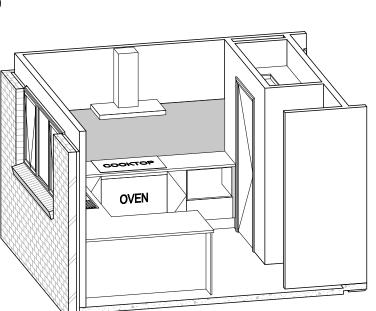
ELEVATION B SCALE: 1:50




ELEVATION C SCALE: 1:50

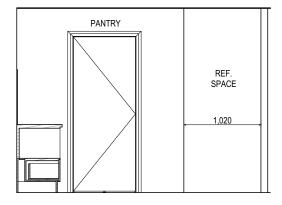

ELEVATION D SCALE: 1:50

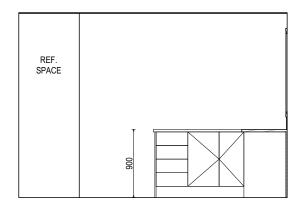

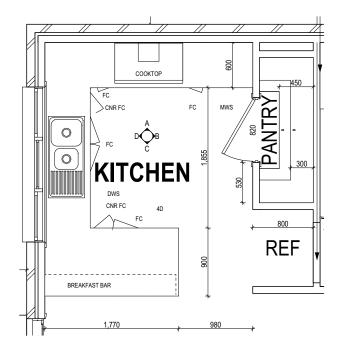

KITCHEN PLAN

PLAN ACCEPTANCE BY OWNER						
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	IONS WILL NOT BE ACCEPTED PTANCE HAS BEEN SIGNED					

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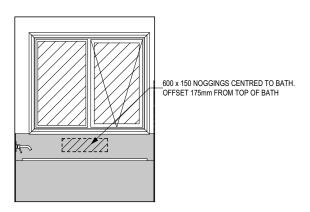
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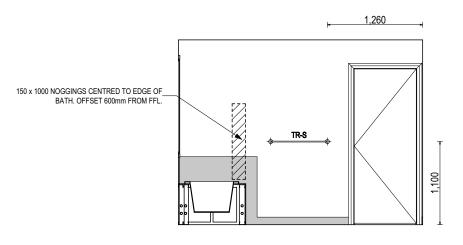
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SPECIFICATION:	REVISION	DRAWN	CLIENT:	HOUSE DESIGN:		HOUSE CODE:	DO NOT SCALE DRAWINGS, USE
DISCOVERY	3 DRAFT SALES PLAN - CT1 AMENDMENT	JII 11/09/2025	BIANCA JANELLE CALLINAN	PERTH 16		H-WDCPTH10SA	FIGURED DIMENSIONS ONLY. CHECK AND VERIFY DIMENSIONS AND
COPYRIGHT:	4 DRAFT SALES PLAN - CT1 - RE-SITING	JII 25/09/2025		FACADE DESIGN:		FACADE CODE:	LEVELS PRIOR TO THE COMMENCEMENT OF ANY WORK. ALL
© 2025	5 DRAFT SALES PLAN - CT2	JII 01/10/2025	37 KOTONA STREET, ROKEBY TAS 7019	CONTEMPO		F-WDCPTH10CTPOA	DISCREPANCIES TO BE REPORTED TO THE DRAFTING OFFICE.
	6 PRELIM PLANS - INITIAL ISSUE	TRV 09/10/2025	LOT / SECTION / CT: COUNCIL:	SHEET TITLE:	SHEET No.:		711110
	7		62 / - / 185338 CLARENCE	KITCHEN DETAILS	13 / 24	1:50	714448

DETAILS DEPICTED ON THIS SHEET ARE A REPRESENTATION ONLY






ELEVATION A SCALE: 1:50




ELEVATION B SCALE: 1:50

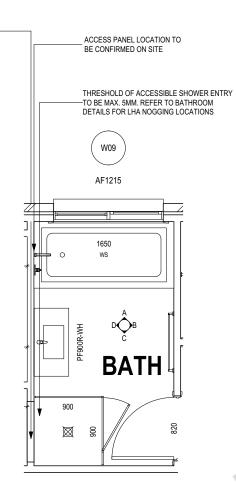


MEDIUM SHAMPOO RECESS (G-

WETA-TILE01)

RSHR RAIL SHOWER ROSE SHOWER ROSE SHOWER ELBOW ELBW CONNECTION MIX MIXER TAP HT HOT TAP CT COLD TAP HS HOB SPOUT WS WALL SPOUT SC STOP COCK TRH TOILET ROLL HOLDER TOWEL RAIL - SINGLE TR-D TOWEL RAIL - DOUBLE TL TOWEL LADDER TH TOWEL HOLDER TR TOWEL RACK TMB TUMBLER HOLDER RNG TOWEL RING RH ROBE HOOK SHLF SHELF SR SHAMPOO RECESS SOAP SOAP HOLDER

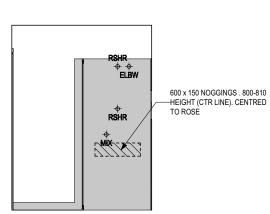

ELEVATION C SCALE: 1:50

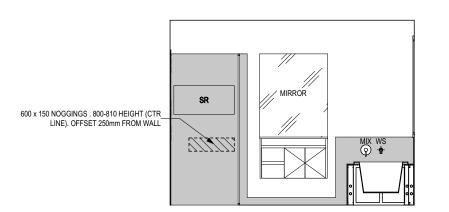

ELEVATION D SCALE: 1:50

BATHROOM PLAN SCALE: 1:50

SHAMPOO	RECESS SIZE	STRUCTU	RAL DIMENSIONS
		WIDTH	HEIGHT
"SMALL"	470 x 380mm	548mm	446mm
"MEDIUM"	800 x 380mm	878mm	446mm
"LARGE"	1500 x 380mm	1578mm	446mm

SUBJECT TO NCC 2022 (1 MAY 2023)

WATERPROOFING & PLUMBING CONDENSATION MANAGEMENT

PLAN ACCEPTA	NCE BY OWNER	۱
SIGNATURE:	DATE:	
SIGNATURE:	DATE:	
	IONS WILL NOT BE ACCEPTED	

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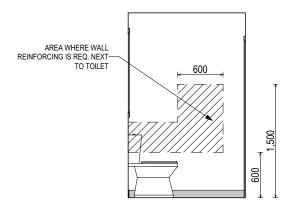
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LIV	310113	IN ANY WAY REPRODUCE, COPY, MODIFY, USE OR TAKE A	ADVANTAGE OF THE DRAWING TO BUILD A HOUSE BASED ON THIS PLAN (WHETHER IN WHOLE OR IN PART) WITHOU	UT THE PRIOR WRITTEN CONSENT OF WILSON HOMES PTY LTD.			:
	SPECIFICATION: DISCOVERY 3	REVISION	DRAWN CLIENT: JII 11/09/2025 BIANCA JANELLE CALLINAN	HOUSE DESIGN: PERTH 16		HOUSE CODE:	DO NOT SCALE DRAWINGS, USE FIGURED DIMENSIONS ONLY. CHECK AND VERIFY DIMENSIONS AND
L	COPYRIGHT: 4	DRAFT SALES PLAN - CT1 AMENDMENT DRAFT SALES PLAN - CT1 - RE-SITING	JII 25/09/2025 ADDRESS:	FACADE DESIGN:		FACADE CODE:	AND VERIFY DIMENSIONS AND LEVELS PRIOR TO THE COMMENCEMENT OF ANY WORK. ALL DISCREPANCIES TO BE REPORTED
		DRAFT SALES PLAN - CT2 PRELIM PLANS - INITIAL ISSUE	JII 01/10/2025 37 KOTONA STREET, ROKEBY TAS 7019 TRV 09/10/2025 LOT/SECTION/CT: COUNCIL:	CONTEMPO SHEET TITLE:	SHEET No.:	F-WDCPTH10CTPOA scales:	TO THE DRAFTING OFFICE.
	7		62 / - / 185338 CLARENCE	BATHROOM DETAILS	14 / 24	1:50	714448


DETAILS DEPICTED ON THIS SHEET ARE A REPRESENTATION ONLY


LEGE	ND
RSHR	RAIL SHOWER
ROSE	SHOWER ROSE
ELBW	SHOWER ELBOW CONNECTION
MIX	MIXER TAP
HT	HOT TAP
CT	COLD TAP
HS	HOB SPOUT
WS	WALL SPOUT
SC	STOP COCK
TRH	TOILET ROLL HOLDER
TR-S	TOWEL RAIL - SINGLE
TR-D	TOWEL RAIL - DOUBLE
TL	TOWEL LADDER
TH	TOWEL HOLDER
TR	TOWEL RACK
TMB	TUMBLER HOLDER
RNG	TOWEL RING
RH	ROBE HOOK
SHLF	SHELF

SR SHAMPOO RECESS SOAP SOAP HOLDER




ELEVATION B SCALE: 1:50

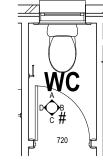

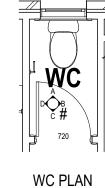


SCALE: 1:50

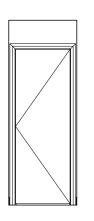

ELEVATION A SCALE: 1:50

ELEVATION C SCALE: 1:50

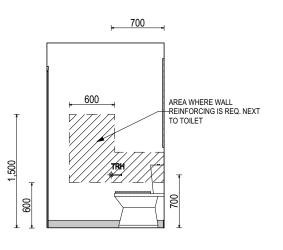

ELEVATION D SCALE: 1:50

SUBJECT TO NCC 2022 (1 MAY 2023)

WATERPROOFING & PLUMBING CONDENSATION MANAGEMENT

PLAN ACCEPTA	ANCE BY OWNER
SIGNATURE:	DATE:
SIGNATURE:	DATE:
PLEASE NOTE THAT VARIAT	IONS WILL NOT BE ACCEPTED

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							,				
SPECIFICATION:		REVISION	[RAWN	CLIENT:			HOUSE DESIGN:		HOUSE CODE:	DO NOT SCALE DRAWINGS, USE
DISCOVERY	3	DRAFT SALES PLAN - CT1 AMENDMENT	JII	11/09/2025	BIANCA JANELLE CALLI	INAN		PERTH 16		H-WDCPTH10SA	FIGURED DIMENSIONS ONLY. CHECK AND VERIFY DIMENSIONS AND LEVELS PRIOR TO THE
COPYRIGHT:	4	DRAFT SALES PLAN - CT1 - RE-SITING	JII	25/09/2025	ADDRESS:			FACADE DESIGN:		FACADE CODE:	COMMENCEMENT OF ANY WORK. ALL
© 2025	5	DRAFT SALES PLAN - CT2	JII	01/10/2025	37 KOTONA STREET, RO	OKEBY TAS 7019		CONTEMPO		F-WDCPTH10CTPOA	DISCREPANCIES TO BE REPORTED TO THE DRAFTING OFFICE.
	6	PRELIM PLANS - INITIAL ISSUE	TRV	09/10/2025	LOT / SECTION / CT:	COUNCIL:		SHEET TITLE:	SHEET No.:	SCALES:	711110
	7				62 / - / 185338	CLARENCE		WC DETAILS	15 / 24	1:50	714448

STANDARD BATH HOB D-WETA-BATH003
WET AREA TILING LAYOUTS D-WETA-TILE002 SQUARE SET WINDOWS G-WIND-SSET02 FULL HEIGHT TILING D-LINI-WETA


REFER TO SHEET 1 (COVER SHEET) FOR ALL BUILDING INFORMATION REGARDING: SUSTAINABILITY REQUIREMENTS SITE CLASSIFICATION GENERAL BUILDING INFORMATION

DETAILS DEPICTED ON THIS SHEET ARE A REPRESENTATION ONLY


LEGEND RSHR RAIL SHOWER ROSE SHOWER ROSE ELBW SHOWER ELBOW CONNECTION MIX MIXER TAP HT HOT TAP CT COLD TAP HS HOB SPOUT WS WALL SPOUT SC STOP COCK TRH TOILET ROLL HOLDER TR-S TOWEL RAIL - SINGLE TR-D TOWEL RAIL - DOUBLE TL TOWEL LADDER TH TOWEL HOLDER TR TOWEL RACK TMB TUMBLER HOLDER RNG TOWEL RING ROBE HOOK SHLF SHELF SR SHAMPOO RECESS SOAP SOAP HOLDER

SS. OPENING ,


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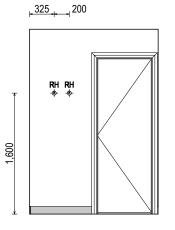
ELEVATION B SCALE: 1:50

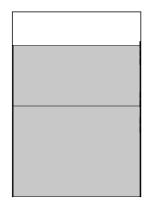

ENSUITE PLAN SCALE: 1:50

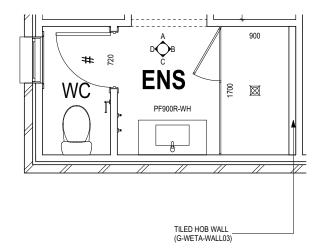

ELEVATION C SCALE: 1:50

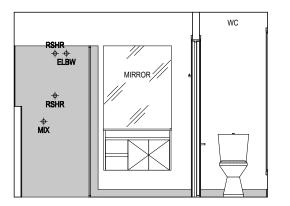

ELEVATION D SCALE: 1:50

SHAMPOO	RECESS SIZE	STRUCTUE	RAL DIMENSIONS		
		WIDTH	HEIGHT		
"SMALL"	470 x 380mm	548mm	446mm		
"MEDIUM"	800 x 380mm	878mm	446mm		
"LARGE"	1500 x 380mm	1578mm	446mm		
REFER WILSON HOMES' DETAIL G-WETA-TILE01 FOR FURTHER DETAIL PRIOR TO INSTALLATION.					

SUBJECT TO NCC 2022 (1 MAY 2023)

WATERPROOFING & PLUMBING CONDENSATION MANAGEMENT

PLAN ACCEPTANCE BY OWNER			
SIGNATURE:	DATE:		
SIGNATURE:	DATE:		
	TIONS WILL NOT BE ACCEPTED		

ALL DIMENSIONS ARE FRAME DIMENSIONS


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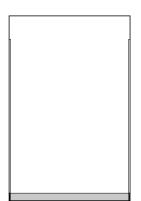
	010110	IN ANT WAT REPRODUCE, COPT, MODIFT, USE OR TAKE A	ADVANTAGE OF THE DRAWING TO BUILD A HOUSE BASED (ON THIS PLAN (WHETHER IN WHOLE OR IN PART) WITHOUT THE PRIOR WRITTEN	CONSENT OF WILSON HOMES PTT LTD.			
	SPECIFICATION:	REVISION	DRAWN CLIENT:		HOUSE DESIGN:		HOUSE CODE:	DO NOT SCALE DRAWINGS, USE FIGURED DIMENSIONS ONLY. CHECK
	DISCOVERY	3 DRAFT SALES PLAN - CT1 AMENDMENT	JII 11/09/2025 BIANCA JANELLE CALL	INAN	PERTH 16		H-WDCPTH10SA	AND VERIFY DIMENSIONS AND LEVELS PRIOR TO THE
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	© 2025	5 DRAFT SALES PLAN - CT2	JII 01/10/2025 37 KOTONA STREET, RO	OKEBY TAS 7019	CONTEMPO		F-WDCPTH10CTPOA	DISCREPANCIES TO BE REPORTED TO THE DRAFTING OFFICE.
		6 PRELIM PLANS - INITIAL ISSUE	TRV 09/10/2025 LOT / SECTION / CT:	COUNCIL:	SHEET TITLE:	SHEET No.:	SCALES:	711110
		7	62 / - / 185338	CLARENCE	ENSUITE DETAILS	16 / 24	1:50	714448

- SITE CLASSIFICATION - GENERAL BUILDING INFORMATION


DETAILS DEPICTED ON THIS SHEET ARE A REPRESENTATION ONLY




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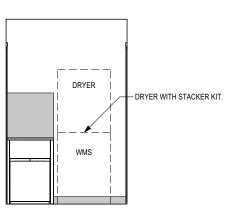
ELEVATION B SCALE: 1:50

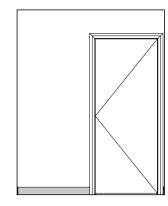

LAUNDRY PLAN SCALE: 1:50

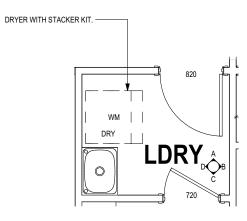

ELEVATION C SCALE: 1:50

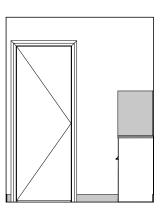

ELEVATION D

SCALE: 1:50

(1 MAY 2023)
WATERPROOFING & PLUMBING

WATERPROOFING & PLUMBING CONDENSATION MANAGEMENT

PLAN ACCEPTA	ANCE BY OWNER
SIGNATURE:	DATE:
SIGNATURE:	DATE:
	IONS WILL NOT BE ACCEPTED PTANCE HAS BEEN SIGNED

ALL DIMENSIONS ARE FRAME DIMENSIONS

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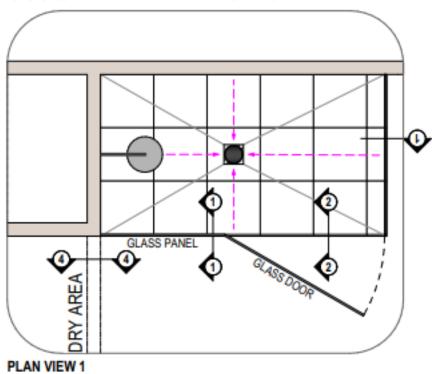



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	[7			62 / - / 185338	CLARENCE		LAUNDRY DETAILS	17 / 24	1:50	714448	Lemp

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STANDARD SHOWER & WATERPROOFING DETAIL

- ALL PLANS ARE DIAGRAMATIC, REFER TO THE CONSTRUCTION PLANS FOR THE BATHROOM & SHOWER LAYOUTS.
- DO NOT SILICON THE BOTTOM OF THE FRAME ON THE SHOWER SIDE.



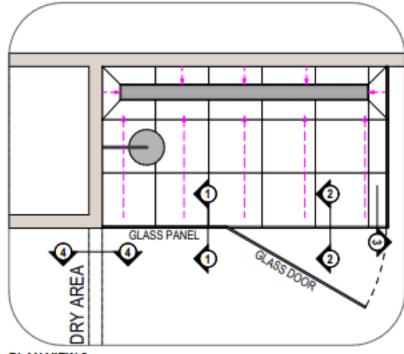

BATHROOM AREA DRY AREA SQUARE SET OPENING 12x20mm ALUMINUM WATERSTOP ANGLE-DOTING MEMBRANE CONTINUOUS WATER SELECTED TILES-ADHESIVE LAYER BETWEEN TILE AND SLAB-SECTION 04-I (UPGRADE) SCALE: 1:2

SHOWER SCREEN

SHOWER SCREEN FRAME

SCREED BEDDING

SECTION 03 - THROUGH GLASS SCREEEN

SCALE: 1:2

DOOR LEAF

DOOR FRAME REVEAL

BOND BREAKER

ODOR REVEAL TO BE CUT AROUND THE WATERSTOP

SCALE: 12

DRY AREA

-SELECTED FLOORING

BATHROOM AREA

IF NECESSARY)

12x20mm MATCHING COVER ANGLE OVER

ADHESIVE LAYER BETWEEN TILE AND SLAB

SELECTED BATHROOM FLOOR

TILES, DIRECT STICK TO SLAB

CONCRETE SLAB TO ENGINEER'S DETAIL:

TOP/OUT TO FOLLOW SCREED FALL

SECTION 04-

(STANDARD)

BATHROOM AREA


SELECTED TILES-


12:20mm ALUMINIUM WATERSTOP ANGLE-CONTINUOUS WATERPROOFING MEMBRANE

(STANDARD FW)



PLAN VIEW 2 (CHANNEL DRAIN) SCALE: 1:20

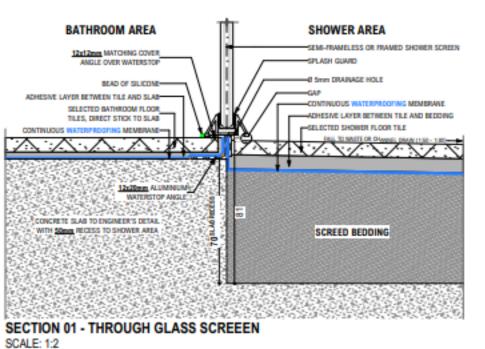

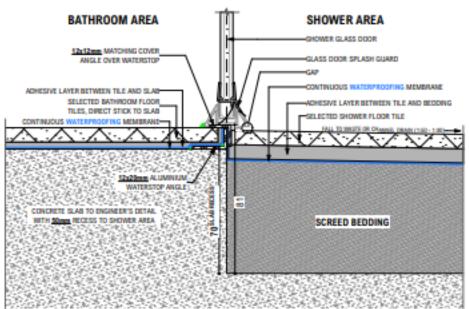


SECTION 02 - THROUGH GLASS DOOR


SCALE: 1:2

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	6	PRELIM PLANS - INITIAL ISSUE	TRV	09/10/2025	LOT / SECTION / CT:	COUNCIL:		SHEET TITLE:	SHEET No.	: SCALES:	744440	ate \
	7				62 / - / 185338	CLARENCE		STANDARD SHOWER & WATERPROOFING	G 18 / 24		714448	Templ





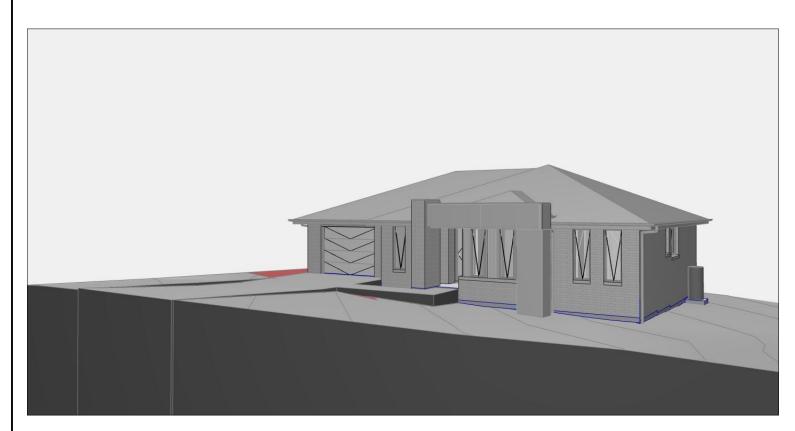

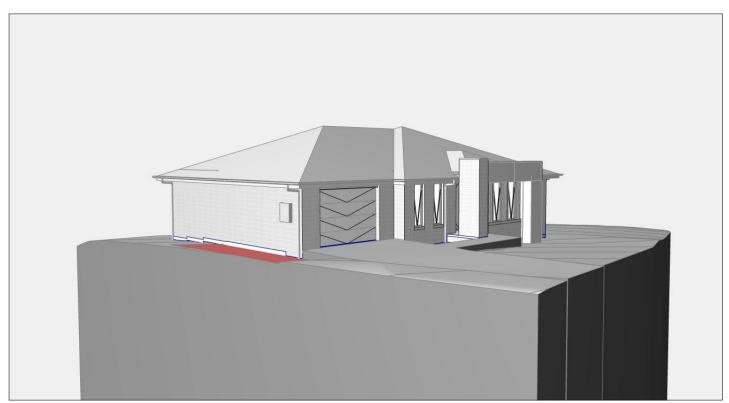

FRONT LEFT



REAR RIGHT

REAR LEFT

NOTE: SITE LEVELS AND SETBACKS SHOWN ARE INDICATIVE ONLY AND SUBJECT TO A FINAL CONTOUR SURVEY AND REGISTERED REPORTS BEING COMPLETED. 3D IMAGES ARE FOR ILLUSTRATIVE PURPOSES ONLY AND ARE SUBJECT TO CHANGE.

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	SPECIFICATION:		REVISION		RAWN	CLIENT:
)	DISCOVERY	3	DRAFT SALES PLAN - CT1 AMENDMENT	JII	11/09/2025	BIANCA JANELI
	COPYRIGHT:	4	DRAFT SALES PLAN - CT1 - RE-SITING	JII	25/09/2025	ADDRESS:
	© 2025	5	DRAFT SALES PLAN - CT2	JII	01/10/2025	37 KOTONA STF
		6	PRELIM PLANS - INITIAL ISSUE	TRV	09/10/2025	LOT / SECTION / CT:
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	CLIENT:		HOUSE DESIGN:	HOUSE CODE:	
	BIANCA JANELLE CALLI	NAN	PERTH 16	H-WDCPTH10SA	
	ADDRESS:		FACADE DESIGN:	FACADE CODE:	
37 KOTONA STREET, ROKEBY TAS 7019			CONTEMPO		F-WDCPTH10CTPOA
	LOT / SECTION / CT:	COUNCIL:	SHEET TITLE:	SHEET No.:	SCALES:
	62 / - / 185338	CLARENCE	3D VIEWS	19 / 24	

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GENERAL BUILDER TO VERIFY ALL DIMENSIONS AND LEVELS ON SITE

- PRIOR TO COMMENCEMENT OF WORK ALL WORK TO BE CARRIED OUT IN ACCORDANCE WITH THE
- NATIONAL CONSTRUCTION CODE (NCC)
- INTERNAL DIMENSIONS ARE TO WALL FRAMING ONLY AND DO NOT INCLUDE WALL LININGS

SITE WORKS

- CUT AND FILL BATTERS ARE INDICATIVE ONLY. BATTER TO COMPLY WITH THE NCC TABLE 3.2.1
- ALL CUTS AND FFL'S SHOWN (DA DRAWINGS) ARE SUBJECT TO ENGINEERING ADVICE ONCE À SATISFACTORY SOIL TEST HAS BEEN RECEIVED AND REVIEWED
- ALL EMBANKMENTS THAT ARE LEFT EXPOSED MUST BE STABILISED WITH VEGETATION OR SIMILAR TO PREVENT
- EMBANKMENTS CANNOT EXCEED 2.0m IN HEIGHT WITHOUT THE AID OF RETAINING WALLS OR OTHER APPROVED TYPES OF SOIL RETAINING METHODS
- ALL UNPROTECTED EMBANKMENTS MUST COMPLY WITH THE SLOPE RATIOS FOR SOIL TYPE IN TABLE 3.2.1 OF THE NCC

SOIL TYPE /	EMBANKMENT OF SLOPE				
CLASSIFICATION	COMPACTED FILL	CUT			
STABLE ROCK (A)	3:3	8:1			
SAND (A)	1:2	1:2			
SILT (P)	1:4	1:4			
FIRM CLAY	1:2	1:1			
SOFT CLAY	NOT SUITABLE	2:3			
SOFT SOILS (P)	NOT SUITABLE	NOT SUITABLE			

MASONRY

- ALL MASONRY TO BE CONSTRUCTED IN ACCORDANCE WITH AS3700
- EXTERNAL WALLS TO BE 110mm BRICKWORK UNLESS NOTED OTHERWISE
- MORTAR MIXED @ 1:1:6 CEMENT:LIME:SAND UNLESS STATED OTHERWISE BY ENGINEER
- DAMP-PROOF COURSE IN ALL PERIMETER WALLS CUT INTO EXTERNAL WALLS BELOW FLOOR LEVEL WITH WEEP HOLES @ 1200 CTRS IN ACCORDANCE WITH AS2904
- VERTICAL ARTICULATION JOINTS TO BE PROVIDED @ 6m MAX. CTRS FOR UNREINFORCED MASONARY WALLS EXCEPT WHERE BUILT ON CLASS A OR S SOIL AND SPACED AS PER AS3700 SECTION 12.6.4. WILSON HOMES REQUEST THAT @ 5M
- WHERE NECESSARY, STEEL LINTELS ARE TO BE PROVIDED IN ACCORDANCE WITH AS4100 AND AS3700a

TIMBER FRAMING

- ALL WORK TO BE CARRIED OUT IN ACCORDANCE WITH THE CURRENT NCC
- ALL TIMBER FRAMING TO BE CARRIED OUT IN ACCORDANCE **WITH AS1684**
- MGP10 PINE FRAMING OR F17 SOLID AND FINGER JOINED FRAMING TO ALL STRUCTURAL COMPONENTS. 90 x 35mm FRAMING TO INTERNAL AND EXTERNAL WALLS. TIMBER COMPOSITE ENGINEERED ROOF TRUSSES WITH HARDWOOD AND MGP COMPONENTS
- GALVANISED WALL TIES TO MASONRY @ 450 CTRS HORIZONTALLY AND 600 CTRS VERTICALLY, WITH SPACING REDUCED BY 50% AROUND OPENINGS

BRACING / LINTELS

- WALL BRACING AS PER AS1684-2 2021 AND AS1170 WIND
- WALL BRACING AS SHOWN ON PLAN IS A MINIMUM ONLY. BUILDER TO PROVIDE ADDITIONAL BRACING TO SUIT THE CONSTRUCTION OF WALL FRAMES IN ACCORDANCE WITH GOOD BUILDING PRACTICE.
- PLYWOOD BRACING IN ACCORDANCE WITH AS1684 TABLE 8.18 (H) METHOD B. 900 WIDE SHEET PLY BRACING PANELS (6mm THICK F11 OR 4mm THICK F14) TO BE FIXED TO STUD FRAME WITH 2.8mm DIA x 30mm LONG MIN. FLAT HEAD NAILS.
- 65 x 19mm HW DIAGONAL TIMBER BRACING CHECKED INTO STUDS AND FIXED IN ACCORDANCE WITH AS1684

TIMBER LINTELS FOR SINGLE (OR UPPER STORY) TO BE F17 HARDWOOD AS FOLLOWS:

0 - 1500 120 x 35 1500 - 2400 140 x 35 2400 - 2700 190 x 35

TIEDOWN AND FIXING CONNECTIONS TO COMPLY WITH AS1684

STEEL LINTELS FOR SINGLE (OR UPPER STOREY) TO BE AS FOLLOWS:

0 - 2700 90 x 90 x 6 EA 2700 - 3200 100 x 100 x 8 EA 3200 - 4000 150 x 90 x 8 EA

*LINTELS REQUIRE 150mm BEARING EITHER SIDE OF OPENING

ALL LINTEL SIZES SHOWN ARE SUBJECT TO ENGINEERS DETAILS

CONCRETE

- CONCRETE FOOTING AND SLABS TO BE IN ACCORDANCE WITH AS2870
- CONCRETE TO BE MANUFACTURED TO COMPLY WITH AS3600 AND:
- HAVE A STRENGTH @ 28 DAYS OF NOT LESS THAN 25MpA (N25 GRADE)
- HAVE A 20mm NOMINAL AGGREGATE SIZE
- HAVE A NOMINAL 80mm SLUMP
- CONCRETE SLAB TO BE LAID OVER 0.2mm POLYTHENE MEMBRANE, 50mm WELL BEDDED SAND AND MINIMUM COMPACTED FCR (20mm)
- SLAB THICKNESS AND REINFORCEMENT TO BE AS PER ENGINEERS DESIGN

WINDOWS

- WINDOWS TO BE ALUMINIUM FRAMED SLIDING UNLESS NOTED OTHERWISE
- ALL WINDOWS TO BE FABRICATED AND INSTALLED IN ACCORDANCE WITH AS1288 AND AS2047 TO SPECIFIC WIND SPEED AS PER ENGINEERS REPORT
- ALL OPENING WINDOWS TO COMPLY WITH NCC 8 **REQUIREMENTS**
- AS PER NCC 11.3.6 ALL BEDROOM WINDOWS WHERE THE LOWEST OPENABLE PORTION OF THE WINDOW IS WITHIN 1.7m OF FFL AND THE FFL IS 2m OR MORE ABOVE NGL. REQUIRE A PERMANANTLY FIXED DEVICE RESTRICTING ANY OPENINGS OF THE WINDOW OR SCREEN SO THAT A 125mm SPHERE CANNOT PASS THROUGH: AND RESISTING OUTWARDS HORIZONTAL ACTION OF 250N AGAINST THE WINDOW. WHERE THE DEVICE OR SCREEN CAN BE REMOVED, UNLOCKED OR OVER-RIDDEN, THE DEVICE OR SCREEN MUST HAVE A CHILD RESISTANT RELEASE MECHANISM INSTALLED AND BARRIER BELOW THE WINDOW THAT IS 865mm HIGH ABOVE FFL AND RESTRICTS ANY OPENING WITHIN THE BARRIER SO THAT A 125mm SPHERE CANNOT PASS THROUGH, AND HAS NO HORIZONTAL OR NEAR HORIZONTAL ELEMENTS BETWEEN 150mm AND 760mm FROM FFL.
- GLAZING INSTALLED IN AREAS WITH HIGH POTENTIAL FOR **HUMAN IMPACT TO COMPLY WITH NCC PART 8.4**

DRAINAGE / WATER

- DRAINAGE TO BE DESIGNED AND CONSTRUCTED IN ACCORDANCE WITH AS3500 AND LOCAL AUTHORITY
- STORMWATER PIPES TO BE UPVC CLASS HD
- SEWER PIPES TO BE UPVC CLASS SH
- PROVIDE Ø20mm K2 POLYETHYLENE WATER RETICULATION
- TYPE B STOP VALVE TO BE LOCATED ADJACENT TO ENTRY
- BACKFILL ALL TRENCHES BENEATH VEHICLE PAVEMENT AND SLABS ON GRADE TO FULL DEPTH WITH 20 FCR
- PROVIDE OVERFLOW RELIEF GULLY WITH TAP OVER. INVERT LEVEL TO BE 150 MIN. BELOW LOWEST SANITARY DRAINAGE POINT
- CUT AND BATTER ARE INDICATIVE. BATTER TO COMPLY WITH **CURRENT NCC TABLE 3.1.1.1**
- AG DRAIN REQUIRED AROUND PERIMETER OF DWELLING FOR ALL CLASS M, H, E SITES. LOCATE AG DRAIN NOT CLOSER THAN 1.5m FROM FOOTINGS IN ACCORDANCE WITH AS2870 SECTION 5.6
- PROVIDE SURFACE DRAINAGE IN ACCORDANCE WITH AS2870 SECTION 5.6.3
- PROVIDE FLEXIBLE JOINTS IN ALL DRAINAGE EMERGING FROM UNDERNEATH OR ATTACHED TO BUILDING IN ACCORDANCE WITH AS2870 SECTION 5.6.4 FOR ALL CLASS H AND E SITES. REFER TO GEOTECH FOR FURTHER INFORMATION
- DOWNPIPES AND GUTTERS DESIGNED IN ACCORDANCE WITH AS/NZS 3500 3

STAIRCASES / BALUSTRADES / HANDRAILS

STAIR TREADS 240mm MIN. - 355mm MAX. STAIR RISERS 115mm MIN. - 190mm MAX.

- HANDRAIL REQUIRED WHERE CHANGE OF LEVEL BETWEEN FLOOR / LANDINGS > 1m AS PER CURRENT NCC 11.3.5
- NO GAPS IN STAIRCASES OR BALUSTRADE TO BE GREATER THAN 125mm
- BALUSTRADE REQUIRED WHERE LEVEL OF LANDING OR DECK IS GREATER THAN 1000mm ABOVE ADJACENT GROUND LEVEL
- BALUSTRADE TO BE MINIMUM 1000mm ABOVE FFL (INCLUDING ANY FLOOR COVERINGS)
- DOORS OPENING OUTWARDS EXTERNALLY MUST OPEN TO A LANDING (MIN. 750mm WIDE) WHERE THE DIFFERENCE IN LEVELS IS GREATER THAN 570mm
- NON-SLIP TREADS TO ALL TREADS AND TO COMPLY WITH NCC 11.2.4
- WHERE LANDINGS ARE NOT NOMINATED TO EXTERNAL DOORS. OPERATING DOOR LEAFS ARE TO BE SCREWED FIXED SHUT, OR PROVIDED WITH A FORMED FCR LANDING NOMINALLY 180mm BELOW FLOOR LEVEL.
- GLAZED BALUSTRADE AND HANDRAILS TO COMPLY WITH NCC PART 8.4, 11.3 AND AS1288 REQUIREMENTS

ROOFING

- ROOF TO BE COLORBOND 'CUSTOM ORB' METALDECK UNLESS NOTED OTHERWISE. PROVIDED AND INSTALLED IN ACCORDANCE WITH AS1562.1 (IF TILED REFER TO AS2050)
- PREFABRICATED ROOF TRUSSES TO BE SUPPLIED AND INSTALLED TO MANUFACTURERS SPECIFICATIONS, TRUSS MANUFACTURER TO CONFIRM LINTEL SIZES.

ELECTRICAL

- EXHAUST FAN TO COMPLY WITH CURRENT NCC PART 10.6.2 SECTION C
- EXHAUST FANS TO BE SEALED AND DUCTED TO OUTSIDE OF DWELLING IN ACCORDANCE WITH NCC VOLUME 2, PARTS 10.8.2 AND 10.8.3
- IF VENTING OCCURS DIRECTLY THROUGH WALLS/ROOF ADJACENT TO FAN. THEN UNIT REQUIRES SELF CLOSING BAFFLES TO BE CLASSIFIED AS A SEALED UNIT
- ELECTRICIAN IS TO ENSURE THAT ALL GPO'S IN WET AREAS MEET ALL STANDARD AND CODE REQUIREMENTS - ALL GPO'S TO BE 300mm FROM FFL UNLESS NOTED OTHERWISE

WET AREAS

- WALLS TO WET AREAS TO BE FINISHED WITH WET AREA PLASTERBOARD
- COMPLIANCE WITH NCC PART 10.2 AND AS3740
- ALL UNENCLOSED SHOWERS ABOVE BATHS TO HAVE MINIMUM 900mm SHOWER SCREEN OR FLOORWASTE WITHIN 1500mm OF SHOWER CONNECTION AS PER AS3740

CONDENSATION

- WHERE RAKED CEILINGS EXIST, IT IS HIGHLY RECCOMENDED THAT SUITABLE SPACING BETWEEN SARKING AND BULK INSULATION EXISTS. (NO CONTACT BETWEEN PRODUCTS). THE BUILDER IS TO ENSURE ADEQUATE SIZED TIMBER IS USED TO ENSURE THIS SEPARATION IS PROVIDED.
- IN STANDARD ROOF SPACES. IT IS HIGHLY RECOMMENDED TO PROVIDE SEPARATION BETWEEN SARKING AND CEILING INSULATION AROUND THE BUILDING PERIMETER, TO ENSURE AIRFLOW FROM EAVE VENTS IS MAINTAINED
- IT IS HIGHLY RECOMMENDED THAT ALL LIGHTWEIGHT CLADDING IS BATTENED OUT FROM STUDS (METAL / FC SHEET / TIMBER)

WOOD HEATERS

- ALL WOOD HEATERS ARE TO COMPLY WITH MANUFACTURERS SPECIFICATION AND NCC PART 12.4

FIRE SAFETY

- SMOKE ALARMS TO BE MAINS POWERED AND INSTALLED AS PER AS3786. LOCATIONS AS PER NCC 9.5.
- SMOKE ALARMS TO BE INTERCONNECTED WHERE THERE IS MORE THAN ONE ALARM
- INSTALLATION OF WOOD HEATERS TO COMPLY WITH AS2918. PROVIDE LOCAL AUTHORITIES WITH INSULATION AND **COMPLIANCE CERTIFICATES**

SUBJECT TO NCC 2022 (1 MAY 2023) WATERPROOFING & PLUMBING

CONDENSATION MANAGEMENT

PLAN ACCEPTANCE	BY OWNER
SIGNATURE:	DATE:
SIGNATURE:	DATE:
PLEASE NOTE THAT VARIATIONS WI AFTER THIS PLAN ACCEPTANCE	
-	

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CLARENCE



SPECIFICATION REVISION DISCOVERY 3 DRAFT SALES PLAN - CT1 AMENDMENT 4 DRAFT SALES PLAN - CT1 - RE-SITING 5 DRAFT SALES PLAN - CT2 6 PRELIM PLANS - INITIAL ISSUE

DRAWN JII 25/09/2025 ADDRESS: TRV 09/10/2025 LOT / SECTION / CT: 62 / - / 185338

JII 11/09/2025 BIANCA JANELLE CALLINAN JII 01/10/2025 37 KOTONA STREET, ROKEBY TAS 7019 COUNCIL .

PERTH 16 FACADE DESIGN: **CONTEMPO** SHEET TITLE:

GENERAL NOTES

OUSE DESIGN

H-WDCPTH10SA FACADE CODE F-WDCPTH10CTPOA SHEET No : SCALES: 20 / 24

HOUSE CODE

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shed: Thursday October 9, 202
shed: Thursd

WET AREA NOTES

	T			
VESSELS OR AREA WHERE THE FIXTURE IS INSTALLED	FLOORS AND HORIZONTAL SURFACES	WALLS	WALL JUNCTIONS AND JOINTS	PENETRATIONS
ENCLOSED SHOWER WITH HOB	WATERPROOF ENTIRE ENCLOSED SHOWER AREA INCLUDING HOB.	WATERPROOF TO NOT LESS THAN 150mm ABOVE THE SHOWER FLOOR SUBSTRATE OR NOT LESS THAN 25mm ABOVE THE MAXIMUM RETAINED WATER LEVEL WHICH EVER IS THE GREATER WITH THE REMAINDER BEING WATERPROOF TO A HEIGHT OF NOT LESS THAN 1800mm ABOVE THE FINISHED FLOOR LEVEL.	WATERPROOF INTERNAL AND EXTERNAL CORNERS AND HORIZONTAL JOINTS WITHIN A HEIGHT OF 1800mm ABOVE THE FLOOR LEVEL WITH NOT LESS THAN 40mm WIDTH EITHER SIDE OF THE JUNCTION.	WATERPROOF ALL PENETRATIONS.
ENCLOSED SHOWER WITHOUT HOB	WATERPROOF ENTIRE ENCLOSED SHOWER AREA, INCLUDING WATERSTOP.	WATERPROOF TO NOT LESS THAN 150mm ABOVE THE SHOWER FLOOR SUBSTRATE WITH THE REMAINDER BEING WATERPROOF TO A HEIGHT OF NOT LESS THAN 1800mm ABOVE THE FINISHED FLOOR LEVEL.	WATERPROOF INTERNAL AND EXTERNAL CORNERS AND HORIZONTAL JOINTS WITHIN A HEIGHT OF 1800mm ABOVE THE FLOOR LEVEL WITH NOT LESS THAN 40mm WIDTH EITHER SIDE OF THE JUNCTION.	WATERPROOF ALL PENETRATIONS.
ENCLOSED SHOWER WITH STEPDOWN	WATERPROOF ENTIRE ENCLOSED SHOWER AREA INCLUDING THE STEPDOWN.	WATERPROOF TO NOT LESS THAN 150mm ABOVE THE SHOWER FLOOR SUBSTRATE OR NOT LESS THAN 25mm ABOVE THE MAXIMUM RETAINED WATER LEVEL WHICHEVER IS THE GREATER WITH THE REMAINDER BEING WATERPROOF TO A HEIGHT OF NOT LESS THAN 1800mm ABOVE THE FINISHED FLOOR LEVEL.	WATERPROOF INTERNAL AND EXTERNAL CORNERS AND HORIZONTAL JOINTS WITHIN A HEIGHT OF 1800mm ABOVE THE FLOOR LEVEL WITH NOT LESS THAN 40mm WIDTH EITHER SIDE OF THE JUNCTION.	WATERPROOF ALL PENETRATIONS.
ENCLOSED SHOWER WITH PRE-FORMED SHOWER BASE	N/A	WATERPROOF TO A HEIGHT OF NOT LESS THAN 1800mm ABOVE FINISHED FLOOR LEVEL.	WATERPROOF INTERNAL AND EXTERNAL CORNERS AND HORIZONTAL JOINTS WITHIN A HEIGHT OF 1800mm ABOVE THE FLOOR LEVEL WITH NOT LESS THAN 40mm WIDTH EITHER SIDE OF THE JUNCTION.	WATERPROOF ALL PENETRATIONS.
UNENCLOSED SHOWERS	WATERPROOF ENTIRE UNCLOSED SHOWER AREA.	WATERPROOF TO NOT LESS THAN 150mm ABOVE THE SHOWER FLOOR SUBSTRATE OR NOT LESS THAN 25mm ABOVE THE MAXIMUM RETAINED WATER LEVEL WHICH EVER IS THE GREATER WITH THE REMAINDER BEING WATERPROOF TO A HEIGHT OF NOT LESS THAN 1800mm ABOVE THE FINISHED FLOOR LEVEL.	WATERPROOF INTERNAL AND EXTERNAL CORNERS AND HORIZONTAL JOINTS WITHIN A HEIGHT OF 1800mm ABOVE THE FLOOR LEVEL WITH NOT LESS THAN 40mm WIDTH EITHER SIDE OF THE JUNCTION.	WATERPROOF ALL PENETRATIONS.
AREAS OUTSIDE THE SHOWER AREA FOR CONCRETE AND COMPRESSED FIBRE CEMENT SHEET FLOORING	WATER RESISTANT TO ENTIRE FLOOR.	N/A	WATERPROOF ALL WALL/FLOOR JUNCTIONS. WHERE A FLASHING IS USED THE HORIZONTAL LEG MUST BE NOT LESS THAN 40mm.	N/A
AREAS OUTSIDE THE SHOWER AREA FOR TIMBER FLOORS INCLUDING PARTICLEBOARD, PLYWOOD AND OTHER TIMBER BASED FLOORING MATERIALS	WATERPROOF ENTIRE FLOOR.	N/A	WATERPROOF ALL WALL/FLOOR JUNCTIONS. WHERE A FLASHING IS USED THE HORIZONTAL LEG MUST BE NOT LESS THAN 40mm.	N/A
AREAS ADJACENT TO BATHS AND SPAS FOR CONCRETE AND COMPRESSED FIBRE CEMENT SHEET FLOORING.	WATER RESISTANT TO ENTIRE FLOOR.	WATERPROOF TO A HEIGHT OF NOT LESS THAN 150mm ABOVE THE VESSEL AND EXPOSED SURFACES BELOW THE VESSEL LIP TO FLOOR LEVEL.	WATERPROOF EDGES OF THE VESSEL AND JUNCTION OF BATH ENCLOSURE WITH FLOOR. WHERE THE LIP OF THE BATH IS SUPPORTED BY A HORIZONTAL SURFACE, THIS MUST BE WATERPROOF FOR SHOWERS OVER BATH AND WATER RESISTANT FOR ALL OTHER CASES.	WATERPROOF ALL TAP AND SPOUT PENETRATIONS WHERE THEY OCCUR IN A HORIZONTAL SURFACE.
AREAS ADJACENT TO BATHS AND SPAS (SEE NOTE 1) FOR TIMBER FLOORS INCLUDING PARTICLEBOARD, PLYWOOD AND OTHER TIMBER BASED FLOORING MATERIALS.	WATERPROOF ENTIRE FLOOR.	WATERPROOF TO A HEIGHT OF NOT LESS THAN 150mm ABOVE THE VESSEL AND EXPOSED SURFACES BELOW THE VESSEL LIP TO FLOOR LEVEL.	WATERPROOF EDGES OF THE VESSEL AND JUNCTION OF BATH ENCLOSURE WITH FLOOR. WHERE THE LIP OF THE BATH IS SUPPORTED BY A HORIZONTAL SURFACE, THIS MUST BE WATERPROOF FOR SHOWERS OVER BATH AND WATER RESISTANT FOR ALL OTHER CASES.	WATERPROOF ALL TAP AND SPOUT PENETRATIONS WHERE THEY OCCUR IN A HORIZONTAL SURFACE.
INSERTED BATHS	N/A FOR FLOOR UNDER BATH. ANY SHELF AREA ADJOINING THE BATH OR SPA MUST BE WATERPROOF AND INCLUDE A WATERSTOP UNDER THE VESSEL LIP.	N/A FOR WALL UNDER BATH. WATERPROOF TO NOT LESS THAN 150mm ABOVE THE LIP OF THE BATH.	N/A FOR WALL UNDER BATH. WATERPRROF TO NOT LESS THAN 150 mm ABOVE THE LIP OF A BATH OR SPA.	WATERPROOF ALL TAP AND SPOUT PENETRATIONS WHERE THEY OCCUR IN A HORIZONTAL SURFACE.
WALLS ADJOINING OTHER VESSELS (EG. SINKS, LAUNDRY TUBS AND BASINS)	N/A	WATERPROOF TO A HEIGHT OF NOT LESS THAN 150mm ABOVE THE VESSEL IF THE VESSEL IS WITHIN 75mm OF THE WALL.	WHERE THE VESSEL IS FIXED TO A WALL, WATERPROOF EDGES FOR EXTENT OF VESSEL.	WATERPROOF ALL TAP AND SPOUT PENETRATIONS WHERE THEY OCCUR IN A HORIZONTAL SURFACE.
LAUNDRIES AND WCS	WATER RESISTANT TO ENTIRE FLOOR.	WATERPROOF ALL WALL/FLOOR JUNCTIONS TO NOT LESS THAN 25mm ABOVE THE FINISHED FLOOR LEVEL, SEALED TO FLOOR.	WATERPROOF ALL WALL/FLOOR JUNCTIONS. WHERE A FLASHING IS USED THE HORIZONTAL LEG MUST BE NOT LESS THAN 40mm.	N/A

THE ABOVE INFORMATION IS FOR GENERAL GUIDANCE AND IS INDICATIVE ONLY. WATERPROOFING INSTALLERS TO COMPLY WITH ALL CURRENT CODES OF LEGISLATION WHICH TAKE PRECEDENCE OVER THIS SPECIFICATION.

WET AREA WAERPROOFING BY LICENSED AND ACCREDITED INSTALLER. CERTIFICATION TO BE PROVIDED TO BUILDING SURVEYOR. CONTRACTOR OR BUILDER TO DETERMINE THE APPROPRIATE WATERPROOFING IN ACCORDANCE WITH AS3740 PART 10.2 OF N.C. CAND TO NOTIFY THE BUILDING SURVEYOR FOR INSPECTION ARRANGEMENTS DURING INSTALLATION.

ENERGY EFFICIENCY - GENERAL

STATED R VALUES ARE FOR ADDITIONAL INSULATION REQUIRED AND ARE NOT RT VALUES (TOTAL SYSTEM VALUE)

INSULATION TO BE INSTALLED TO MANUFACTURERS SPECIFICATIONS AND ANY RELEVANT STANDARDS

BULK INSULATION IS NOT TO BE COMPRESSED AS THIS REDUCES THE EFFECTIVE R RATING

N.C.C 2022 TAS PART H6

IN TASMANIA. FOR NCC PART H6 REFER TO NCC 2019 AMENDMENT 1 PART 2.6; FOR NCC PART 13.1 REFER TO NCC 2019 PART 3.12

N.C.C 2019 3.12.0 (A)

AND BE INSTALLED TO N.C.C 3.12.1.1.

PERFORMANCE REQUIREMENT P2.6.1 FOR THE THERMAL PERFORMANCE OF THE BUILDING IS SATISFIED BY COMPLYING WITH:

3.12.0.1 - FOR REDUCING THE HEATING AND COOLING LOADS TO REDUCE HEATING AND COOLING LOADS MUST ACHIEVE AN ENERGY RATING USING HOUSING ENERGY RATING SOFTWARE OF NOT LESS THAN 6

3.12.1.1 - FOR BUILDING FABRIC THERMAL INSULATION BUILDER TO ENSURE THAT ALL INSULATION COMPLIES WITH AS/NZS 4859.1

3.12.1.2(e) - FOR COMPENSATING FOR A LOSS OF CEILING INSULATION REFER TO ATTACHED THERMAL PERFORMANCE CERTIFICATE

- (i) IF ALLOWANCE HAS BEEN MADE FOR CEILING PENERATIONS IN NATHERS (FIRST RATE 5) CERTIFICATION PROCESS THEN NO FURTHER ACTION REQUIRED.
- (ii) IF NO ALLOWANCE HAS BEEN MADE FOR CEILING PENETRATIONS IN NATHERS (FIRST RATE 5) CERTIFICATION PROCESS THEN CEILING PENETRATION AREA MUST BE CALCULATED AND THE NECESSARY ADJUSTMENT MADE TO THE SPECIFIED INSULATION AS PER TABLE 3.12.1.1B OF NCC

3.12.1.5(c) AND 3.12.1.5(d) - FOR FLOOR EDGE INSULATION FOR CONCRETE SLAB ON GROUNG WITH IN SLAB HEATING OR COOLING.

3.12.3 - FOR BUILDING SEALING 3.12.3.1 - CHIMNEYS AND FLUES

THE CHIMNEY OR FLUE OF AN OPEN SOLID FUEL BURNING APPLIANCE MUST BE PROVIDED WITH A DAMPER OR FLAP THAT CAN BE CLOSED TO SEAL THE

3.12.3.2 - ROOF LIGHTS

- (a) A ROOF LIGHT MUST BE SEALED, OR CAPABLE OF BEING SEALED WHEN
- (i) A CONDITIONED SPACE; OR
- ii) A HABITABLE ROOM IN CLIMATE ZONES 4, 5, 6, 7 OR 8
- (b) A ROOF LIGHT REQUIRED BY (a) TO BE SEALED, OR CAPABLE OF BEING SEALED MUST BE CONSTRUCTED WITH: (i) AN IMPEREORATE CEILING DIFFUSER OR THE LIKE INSTALLED AT A
 - CEILING OR INTERNAL LINING LEVEL; OR
- (ii) A WATERPROOF SEAL; OR
- (iii) A SHUTTER SYSTEM READILY OPERATED MANUALLY, MECHANICALLY OR ELECTRONICALLY BY THE OCCUPANT

- 3.12.0.1 EXTERNAL WINDOWS AND DOORS

 (a) A SEAL TO RESTRIC AIR INFILTRATION MUST BE FITTED TO EACH OF AN EXTERNAL DOOR, OPENABLE WINDOW AND OTHER SUCH OPENING:
- (I) WHEN SERVING A CONDITIONED SPACE; OR
- (II) IN CLIMATE ZONES 4, 5, 6, 7 OR 8, WHEN SERVING A HABITABLE ROOM
- (b) A WINDOW COMPLYING WITH THE MAXIMUM AIR INFILTRATION RATES SPECIFIED IN AS2047 NEED NOT COMPLY WITH (a).
- (c) A SEAL REQUIRED BY (a)

WAFFLE POD ALLOWANCES:

 R0.6 - 175mm DEEP - R0 7 - 225mm DEEP

- R0.8 - 300mm DEEP

- R0.9 - 375mm DEEP

- (i) FOR THE BOTTOM EDGE OF AN INTERNAL SWING DOOR, MUST BE A DRAFT PROTECTION DEVICE; AND
- (ii) FOR THE OTHER EDGES OF AN EXTERNAL SWING DOOR OR THE EDGES OF AN OPENABLE WINDOW OR OTHER SUCH OPENING, MAY BE A FOAM OR RUBBER COMPRESSIBLE STRIP, FIBROUS SEAL OR

3.12.3.4 - EXHAUST FANS

AN EXHAUST FAN MUST BE FITTED WITH A SEALING DEVICE SUCH AS A SELF CLOSE DAMPER, FILTER OR THE LIKE WHEN SERVING:

(a) A CONDITIONED SPACE: OR

(b) A HABITABLE ROOM IN THE CLIMATE ZONES 4, 5, 6, 7 OR 8.

3.12.3.5 - CONSTRUCTION OF ROOF, WALLS AND FLOORS

- (a) ROOFS, EXTERNAL WALLS, EXTERNAL FLOORS AND AN OPENING SUCH AS A WINDOW FRAME, DOOR FRAME, ROOF LIGHT FRAME OR THE LIKE MUST BE CONSTRUCTED TO MINIMISE AIR LEAKAGE IN ACCORDANCE WITH (b) WHEN FORMING PART OF THE EXTERNAL FABRIC OF:
 - (i) A CONDITIONED SPACE; OR
 - (ii) A HABITABLE ROOM IN CLIMATE ZONE 4, 5, 6, 7 OR 8.
- (b) CONSTRUCTION REQUIRED BY (a) MUST BE:
- (i) ENCLOSED BY AN INTERNAL LINING SYSTEM THAT ARE CLOSE FITTING AT CEILING, WALL AND FLOOR JUNCTIONS; OR
- (ii) SEALED BY CAULKING, SKIRTING, ARCHITRAVES, CORNICES OR THE

3.12.3.6 - EVAPORATIVE COOLERS

AN EVAPORATIVE COOLER MUST BE FITTED WITH A SELF CLOSING DAMPER OR THE LIKE WHEN SERVING:

(a) A HEATED SPACF: OR

(b) A HABITABLE ROOM IN CLIMATE ZONES 4 5 6 7 OR 8

3.12.5.5 - ARTIFICIAL LIGHTING

- (a) LAMP POWER DENSITY OR ILLUMINATION POWER DENSITY OF AN ARTIFICIAL LIGHT, EXCLUDING HEATING THAT EMITS LIGHT, MUST NOT EXCEED THE ALLOWANCE OF:
- (i) 5W/m2 IN A CLASS 1 BUILDING
- (ii) 4W/m² ON A VERANDAH, BALCONY OR THE LIKE ATTACHED TO A CLASS 1 BUILDING (NOT EXCLUDING EAVE PERIMETER LIGHTS);
- (iii) 3W/m2 IN A CLASS 10A BUILDING ASSOCIATED WITH A CLASS 1 BUILDING.
- (b) THE ILLUMINATION POWER DENSITY ALLOWANCE IN (a) MAY BE INCREASED BY DIVIDING IT BY THE ILLUMINATION POWER DENSITY ADJUSTMENT FACTOR FOR A CONTROL DEVICE AS PER N.C.C TABLE 3.12.5.3.

SUBJECT TO NCC 2022 (1 MAY 2023)

WATERPROOFING & PLUMBING **CONDENSATION MANAGEMENT**

PLAN ACCEPTAN	CE BY OWNER	W
SIGNATURE:	DATE:	O-Trium (A) IORS/DREI IMS
SIGNATURE:	DATE:	
PLEASE NOTE THAT VARIATION		ocation.
AFTER THIS PLAN ACCEPTA	NCE HAS BEEN SIGNED	-

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1	DISCOVERY	3 DRAFT SALES PLAN - CT1 AMENDMENT	JII 11/09/2025 BIANCA JANELLE CALL	INAN	PERTH 16		H-WDCPTH10SA	AND VERIFY DIMENSIONS AND LEVELS PRIOR TO THE	
	COPYRIGHT:	4 DRAFT SALES PLAN - CT1 - RE-SITING	JII 25/09/2025 ADDRESS:		FACADE DESIGN:		FACADE CODE:	COMMENCEMENT OF ANY WORK. ALL	
-	© 2025	5 DRAFT SALES PLAN - CT2	JII 01/10/2025 37 KOTONA STREET, RO	37 KOTONA STREET, ROKEBY TAS 7019			F-WDCPTH10CTPOA	DISCREPANCIES TO BE REPORTED TO THE DRAFTING OFFICE.	
		6 PRELIM PLANS - INITIAL ISSUE	TRV 09/10/2025 LOT / SECTION / CT:	COUNCIL:	SHEET TITLE:	SHEET No.:	SCALES:	744440	
		7	62 / - / 185338	CLARENCE	WET AREA & ENERGY EFFICIENCY NOTES	21 / 24		714448	

Requirements for Building In Bushfire Hazard Areas Building Act 2016

Directors Determination - Bushfire Hazard Areas V1.1, dated 08 April 2021

Deemed-to-Satisfy Requirements (Part 2.3)

2.3.1 Design and construction

(1) Building work in a bushfire-prone area must be designed and constructed in accordance with either: -

(b)Standard for Steel Framed Construction in Bushfire Areas published (b)Standard for Steel Framed Construction in Bushire Areas published by the National Association of Steel Framed Housing Inc. (NASH). as appropriate for a BAL determined for that site using table 2.6 of AS 3959. (2) Subclause (1)(a) is only applicable to the following:

(a) a Class 1, 2 or 3 building; or

(b) a Class 10a building or deck associated with a Class 1, 2 or 3 building.

(3) Subclause (1)(b) is only applicable to the following:

(a) a Class 1 building; or (b) a Class 10a building or deck associated with a Class 1 building.

(4) Despite subsection (1) permissible, variations from requirements specified in 1(a) and 1(b) are as specified in Table 1.
(5) Despite subsections (1) and (4), performance requirements

for buildings subject to BAL 40 or BAL Flame Zone (BAL-FZ) are not satisfied by compliance with subsections (1) or (4).

2.3.2 Property Access

2.3.2 Property Access

(1) A new building in a bushfire-prone area must be provided with property access to the building area and the firefighting water point, accessible by a carriageway, designed and constructed as specified in subclause (4).

(2) For an addition or alteration to an existing building in a bushfire-prone area, if there is no property access awailable property access must be provided to the building area and the firefighting water point accessible by a carriageway as specified in subclause (4).

(3) An addition or alteration to an existing building in a bushfire-prone area must not restrict any existing property access to the building area or to water supply for firefighting.

(4) Vehicular access from a public road to a building must:

(a) comply with the property access requirements specified in Table 2;

(b) include access from a public road to within 90 metres of the furthest part of the building measured as a hose lay; and

(c) include access to the hardstand area for the firefighting water point.

2.3.3 Water Supply for Fire fighting

(1) A new building constructed in a bushfire-prone area, must be provided with a water supply dedicated for fire fighting purposes as specified in Table 3A or Table 3B.

(2) For an addition or alteration to an existing building in a bushfire-prone area, if there is no water supply for firefighting available the building must be provided with a water supply dedicated for firefighting purposes which complies with the requirements specified in Table 3A or Table 3B.

2.3.4 Hazard Management Areas

2.3.4 Hazard Management Areas
(1) A new building, and an existing building in the case of an addition or alteration to a building, in a bushfire-prone area must be provided with a hazard management area.
(2) The hazard management area must comply with the requirements specified in Table 4.
(3) The hazard management area for a particular BAL must have the minimum dimensions required for the separation distances specified for that BAL in Table 2.6 of AS. 3959.

(4) The hazard management area must be established and maintained such that fuels are reduced sufficiently, and other hazards are removed such that the fuels and other hazards do not significantly contribute to the bushfire attack.

2.3.5 Bushfire emergency plan

2.3.5 Bushfire emergency plan
(1) An emergency plan must be provided for:
(a) a new building;
(b) an existing building in the case of an addition or alteration to a building;
(c) an existing building in the case of a change of building class;
(d) a building associated with the use, handling, generation or storage of a hazardous chemical or explosive; in a bushfire-prone area.
(2) A bushfire emergency plan must comply with the requirements specified in Table 5.

7. Interpretation of Tables

7. Interpretation of Tables (1) For the purposes of the deemed-to-satisfy provisions in clause 2.3 of this Determination, Tables 1, 2, 3A, 3B, 4, and 5 must be complied with in the following way: (a) for a particular element specified in column 1, the corresponding requirement specified in column 2 must be complied with.

Table 1 - Construction Requirements & Construction Variations

Column 1 ELEMENT		Column 2			
		REQUIREMENT			
A. Straw Bale Construction		May be used in exposures up to and including BAL 19.			
В.	Shielding provisions under Section 3.5 of AS3959-2018	To reduce construction requirements due to shielding, building plans must include suitable detailed elevations or plans that demonstrate that the requirements of Section 3.5 of the Standard can be met.			
		Comment: Application of Section 3.5 of the Standard cannot result in and assessment of BAL-LOW.			

Table 2 - Requirements for Property Access

Column 1				
	ELEMENT	REQUIREMENT		
Property access length is less than 30 metres; or access is not for a fire appliance to access a water connection point.		There are no specified design and construction requirements.		
В.	Property access length is 30 metres or greater; or access for a fire appliance to a water connection point.	The following design and construction requirements apply to property access: (1) All-weather construction; (2) Load capacity of at least 20 tonnes, including for bridges and culverts; (3) Minimum carriageway widths of 4 metres; (4) Minimum vertical clearance of 4 metres; (5) Minimum horizontal clearance of 0.5 metres from the edge of the carriageway; (6) Cross falls of less than 3° (1:20 or 5%); (7) Dips less than 7° (1:8 or 12.5%) entry and exit angle; (8) Curves with a minimum inner radius of 10 metres; (9) Maximum gradient of 15° (1:3.5 or 28%) for sealed roads, and 10° (1:5.5 or 18%) for unsealed roads; and (10) Terminate with a turning area for fire appliances provided by one of the following: (a) A turning circle with a minimum inner radius of 10 metres; (b) A property access encircling the building; or (c) A hammerhead "T" or "Y" turning head 4 metres wide and 8 metres long.		
C.	Property access length is 200 metres or greater.	The following design and construction requirements apply to property access: (1) The Requirements for B above; and (2) Passing bays of 2 metres additional carriageway width and 20 metres length provided every 200 metres.		
D.	Property access length is greater than 30 metres, and access is provided to 3 or more properties.	The following design and construction requirements apply to property access: (1) Complies with Requirements for B above; and (2) Passing bays of 2 metres additional carriageway width and 20 metres length must be provided every 100 metres.		

Table 3A - Reticulated Water Supply for Firefighting

6 PRELIM PLANS - INITIAL ISSUE

Column 1

ELEMENT A. Distance between building area to be protected and water supply					
		REQUIREMENT			
		The following requirements apply: (1) The building area to be protected must be located within 120 metres of a fire hydrant; and (2) The distance must be measured as a hose lay, between the water connection point and the furthest part of the building area.			
В.	Design criteria for fire hydrants	The following requirements apply: (1) Fire hydrant system must be designed and constructed in accordance with TasWater Supplement to Water Supply Code of Australia WSA 03 - 2011-3.1 MRWA Edition 2.0; and (2) Fire hydrants are not installed in parking areas.			
C.	Hardstand	A hardstand area for fire appliances must be provided: (1) no more than three metres from the hydrant, measured as a hose lay; (2) No closer than six metres from the building area to be protected; (3) With a minimum width of three metres constructed to the same standard as the carriageway; and (4) Connected to the property access by a carriageway equivalent to the standard of the property access			

Column 2

Table 3B - Static Water Supply for Firefighting

	Column 1	Column 2				
ELEMENT		REQUIREMENT				
Α.	Distance between building area to be be protected and water supply	The following requirements apply: (a) The building area to be protected must be located within 90 metres of the water connection point of a static water supply; and (b) The distance must be measured as a hose lay, between the water connection point and the furthest part of the building area.				
B.	Static Water Supplies	A static water supply: (a) May have a remotely located offtake connected to the static water supply; (b) May be a supply for combined use (fire fighting and other uses) but the specified minimum quantity of fire fighting water must be available at all times; (c) Must be a minimum of 10,000 litres per building area to be protected. This volume of water must not be used for any other purpose including fire fighting sprinkler or spray systems; (d) Must be metal, concrete or lagged by non-combustible materials if above ground; and (e) If a tank can be located so it is shielded in all directions in compliance with Section 3.5 of AS 3959-2018, the tank may be constructed of any material provided that the lowest 400 mm of the tank exterior is protected by: (i) metal; (ii) non-combustible material; or (iii) fibre-cement a minimum of 6 mm thickness.				
C.	Fittings, pipework and accessories (including stands and tank supports)	Fittings and pipework associated with a water connection point for a static water supply must: (a) Have a minimum nominal internal diameter of 50mm; (b) Be fitted with a valve with a minimum nominal internal diameter of 50mm; (c) Be metal or lagged by non-combustible materials if above ground; (d) Where buried, have a minimum depth of 300mm (e) Provide a Din or NEN standard forged Storz 65 mm coupling fitted with a suction washer for connection to fire fighting equipment; (f) Ensure the coupling is accessible and available for connection at all times; (g) Ensure the coupling is fitted with a blank cap and securing chain (minimum 220 mm length); (h) Ensure underground tanks have either an opening at the top of not less than 250 mm diameter or a coupling compliant with this Table; and (j) Where a remote offtake is installed, ensure the offtake is in a position that is: (i) Visible; (ii) Accessible to allow connection by fire fighting equipment; (iii) At a working height of 450 - 600mm above ground level; and (iv) Protected from possible damage, including damage by vehicles.				
D.	Signage for static water connections	(1)The water connection point for a static water supply must be identified by a sign permanently fixed to the exterior of the assembly in a visible location. The sign must: (a) comply with water tank signage requirements within AS 2304; or (b) comply with the TFS Water Supply Signage Guideline.				
E.	Hardstand	A hardstand area for fire appliances must be provided: (a) No more than three metres from the water connection point, measured as a hose lay (including the minimum water level in dams, swimming pools and the like); (b) No closer than six metres from the building area to be protected; (c) With a minimum width of three metres constructed to the same standard as the carriageway; and (d) Connected to the property access by a carriageway equivalent to the standard of the property access.				

Table 4 - Requirements for Hazard Management Area

Column 1		Column 2					
	ELEMENT	REQUIREMENT					
A	Hazard managements areas for new buildings on lots provided with a BAL at the time of subdivision.	A new building must: (a) Be located on the lot so as to be provided wih a HMA no smaller than the required separation distances for the BAL determined at the time of the subdivision; and (b) Have a HMA established in accordance with a certified bushfire hazard management plan.					
В	Hazard management areas for new buildings on lots not provided with a BAL at the time of sub division.	A new building must: (a) Be located on the lot so as to be provided with a HMA no smaller than the separation distances required for BAL 29; and (b) Have an HMA established in accordance with a certified bushfire hazard management plan.					
С	Hazard management areas for alterations or additions to buildings.	An alteration or addition to a building must: (a) Be located on the lot so as to be provided with a HMA which: (i) Has the separation distances required for the BAL assessed for the construction of the existing building; or (ii) In the case of a building without an existing BAL assessment, is no smaller than the separation distances required for BAL 29; and (b) Have an HMA established in accordance with a certified bushfire hazard management plan.					
	Hazard management areas for new buildings and additions and alterations to buildings classified as an accommodation building BCA Class 1b, BCA Class 2, or BCA Class 3, other than communal residence for persons with a disability, a respite centre or a residential aged care facility or similar.	A new building or an alteration or addition must: (a) be located on the lot so as to be provided with HMAs no smaller than the separation distances required for BAL 12.5; and (b) have a HMA established in accordance with a certified bushfire hazard management plan.					
E	Hazard management areas for new buildings and additions and alterations to existing buildings classified as vulnerable use as defined in the relevant planning scheme.	A new building or an addition or alteration including change of use must: (a) be located on the lot so as to be provided with HMAs no smaller than the separation distances required for BAL 12.5; and (b) have a HMA established in accordance with a certified bushfire hazard management plan.					
F	Hazard management areas for new buildings or additions and alterations to buildings associated with the use, handling, generation or storage of a hazardous chemical or explosive.	A new building or an alteration or addition, including change of use, for a building determined as a hazardous use must: (a) Be located on the lot so as to be provided with a HMA no smaller than the required separation distances for the BAL determined in the certified bushfire hazard management plan; and (b) Have a HMA established in accordance with a certified bushfire hazard management plan.					

Table 5 - Requirements for Emergency Planning

BUILDING ACT BUSHFIRE HAZARD AREAS 22 / 24

SHEET TITLE:

Column 1		Column 2		
	ELEMENT	REQUIREMENT		
A.	Bushfire emergency plans	An emergency plan must be developed for the site which is: (a) Consistent with TFS Bushfire Emergency Planning Guidelines; and (b) Approved by TFS or a person accredited by the TFS.		

SHEET No.: SCALES:

SUBJECT TO NCC 2022 (1 MAY 2023) WATERPROOFING & PLUMBING

CONDENSATION MANAGEMENT

PLAN ACCEPTANCE BY OWNER							
SIGNATURE:	DATE:						
SIGNATURE:	DATE:						
PLEASE NOTE THAT VARIATIO							

REFER TO SHEET 1 (COVER SHEET) FOR BAL-12.5 BUSHFIRE REQUIREMENTS SEE SHEET 1 (COVER SHEET) FOR DETAILS

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CLARENCE

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AND VERIFY DIMENSIONS AND I EVELS PRIOR TO THE COMMENCEMENT OF ANY WORK. AL DISCREPANCIES TO BE REPORTED TO THE DRAFTING OFFICE.

All specifications are per AS3959 (2018) and Wilson Homes request. Other materials and options may be available, refer to AS3959 for full list of compliant materials.

5.1 GENERAL

A building assessed in Section 2 as being BAL -12.5 shall comply with Section 3 and Clauses 5.2 to 5.8.

Any element of construction or system that satisfies the test criteria contained in Clauses 5.2 to 5.8 (see Clause 3.8).

NOTE: BAL -12.5 is primarily concerned with protection from ember attack, and radiant heat up to and including $29kW/m^2$ where the site is less than 100 m from the source of the bushfire attack.

5.2 SUBFLOOR SUPPORTS

This Standard does not provide construction requirements fo

subfloor supports where the subfloor space is enclosed with (a) a wall that complies with Clause 5.4; OR
(b) a mesh or perforated sheet with a maxium aperture of
2mm, made of corrosion resistant steel, bronze or aluminium; OR (c) a combination of Items (a) and (b)

NOTE: This requirement applies to the subject building only and not to verandas, decks, steps, ramps and landings (see Clause

C5.2 Combustile materials stored in the subfloor space may be ignited by embers and cause and impact to the building.

5.3 FLOORS

5.3.1 GENERAL

This Standard does not provide construction requirements fo concrete slabs on the ground

5.3.2 ELEVATED FLOORS

5.3.2.1 ENCLOSED SUBFLOOR SPACE

This standard does not provide consturction requirements for elevated floors, including bearers and joists and flooring, where the subfloor space is enclosed with

(a) a wall that complies with Clause 5.4; OR
(b) a mesh perforated sheet with a maximum aperture of 2mm,
made of corrosion resistant steel, bronze or aluminium; OR
(c) a combination of Items (a) and (b) above.

5.3.2.2 UNENCLOSED SUBFLOOR SPACE

Where the subfloor space is unenclosed, the bearers, joists and flooring, less than 400mm above finished ground level, shall be one of the following
(a) Materials that comply with the following:

(i) Bearers and joists shall be (A) non-combustible; OR
(B) bushfire-resisting timber (see Appendix F); OR
(C) a combination of Items (A) and (B) above. (ii) Flooring shall be -

(ii) Flooring shall be (A) non-combustible; OR
(B) bushfire-resisting timber (see Appendix F); OR
(C) timber (other than bushfire-resisting timber),
particleboard or plywood flooring where the underside is lined with
sarking-type material or mineral wool insulation; OR
(D) a combination of any Items (A), (B) or (C) above.

(b) A system complying with AS1530.8.1

This standard does not provide construction requirements for elements of elevated floors, including bearers, joists and flooring, if the underside of the element is 400mm or more above finished ground level.

5.4.1 WALLS

The exposed components of an external wall that is less than 400 mm from the ground or less than 400 mm above decks, carport roofs, awnings and similar fittings having an angle of less than 18 degrees to the horizontal and extending more than 110 mm in width from the wall (see Figure D3, Appendix D) shall be:

NOTE: Examples include, but are not limited to, the following (with a minimum of 90 mm inthickness):

(i) Full masonry or masonry veneer walls with an outer leaf of clay, concrete, calcium silicate or natural stone.

(ii) Precast or in situ walls of concrete or aerated concrete

(iii) Earth wall including mud brick. OR

(b) Timber logs of a species with a density of 680kg/m³ or greater at a 12 percent moisture content; of a minimum nominal overall thickness of 90mm and a minimum thickness of 70mm (see Clause 3.11); and

gauge planed. OR
(c) Cladding that is fixed externally to a timber-framed or a steel-framed wall that is sarked on the outside of the frame and is -

(i) non-combustible material; OR (ii) fibre cement a minimum of 6mm in thickness; OR

(iii) bushfire-resisting timber (see Appendix F); OR
(iv) a timber species as specified in Paragraph E1, Appendix E; pr
(v) a combination of any of Items (i), (iii), (iii) or (iv) above. OR
(d) A combination of any items (a), (b) or (c) above.

5.4.2 JOINTS

All joints in the external surface material of walls shall be covered sealed, overlapped, backed or butt-jointed.

BAL-12.5 BUSHFIRE REQUIREMENTS

SEE SHEET 1 (COVER SHEET) FOR DETAILS

5.4.3 VENTS AND WEEPHOLES

Except for exclusions provided in Clause 3.6, vents and weepholes in external walls shall be screened with a mesh made of corrosion-resistant steel, bronze

5.5.1 BUSHFIRE SHUTTERS

Where fitted, bushfire shutters shall comply with Clause 3.7 and be made from -(a) non-combustible material; OR
(b) a timber species as specified in Paragraph E1, Appendix E; OR
(c) bushfire-resisting timber (see Appendix F); OR
(d) a combination of Items (a), (b) and (c) above.

5.5.2 SCREENS FOR WINDOWS AND DOORS

Where fitted, screens for windows and doors shall have a mesh or perforated sheet made of corrosion-resistant steel, bronze or aluminium.

The frame supporting the mesh or perforated sheet shall be made from (a) metal; OR

(b) bushfire-resisting timber (see Appendix F).
(c) a timber species as specified in Paragraph E2, Appendix E.

5.5.3 WINDOWS AND SIDELIGHTS

(a) be completely protected by a bushfire shutter that complies with Clause 3.7 and clause 5.5.1; OR

(b) Be completely protected externally by screens that conform with Clause 3.6

and Clause 5.5.2. (c) Conform with the following:

(i) Frame material For window assemblies less than 400mm from the (I) Frame material For window assemblies less than 400mm from the ground or less than 400mm above decks, carport roofs, awnings and similar elements or fittings having and angle less than 18 degrees to the horizontal and extending more than 110mm in width from the window frame (see Figure D3, Appendix D), window frames and window joinery shall be made from:

(A) Bushfire-resisting timber (see Appendix F) OR

(B) A timber species as specified in Paragraph E2, Appendix F); OR

(C) Metal. UR (D) Metal-reinforced uPVC. The reinforcing members shall be made uminium, stainless steel, or corrosion-resistant steel. There are no specific restrictions on frame material for all other

windows.

(ii) Hardware There are no specific restrictions on hardware for windows.

(iii) Glazing Where glazing is less than 400mm from the grounf or less than 400mm above decks, carport roofs, awnings and similar elements or fittings having and angle less than 18 degrees to the horizontal and extending more than 110mm in width from the window frame (see Figure D3, Appendix D), this glazing shall be Grade A safety glass a minimum of 4mm in thickness or glass blocks with no restriction on glazing methods. NOTE: Where double-glazed assemblies are used above, the requirements apply to the external pane of the glazed assembly only. For all other glazing, annealed glass may be used in accordance with AS 1288.

(iv) Seals and weather strips There are no specific requirements for seals and weather strips at this BAI Level.

(iv) Seals and weather strips. There are no specific requirements for seals and weather strips at this BAL level. (iv) Screens. The openable portions of windows shall be screened internally or externally with screens that conform with Clause 3.6 and Clause 5.5.2.

C5.5.3 For Clause 5.5.3(c), screening of the openable portions of all windows is required in all BAL's to prevent the entry of embers to the building when the

is required in all BAL's to prevent the entry or embods and fixed portions of some window is open. For Clause 5.5.3 (c)(v), screening of the openable and fixed portions of some windows is required to reduce the effects of radiant heat on some tpes of glass. If the screening is required to reduce the effects of radiant heat on glass, and has to be externally fixed.

For Clause 5.5.3 (c)(v), if the screening is required only to prevent the entry of embers, the screening may be fitted externally or internally.

5.5.4 DOORS SIDE-HUNG EXTERNAL DOORS (including French Doors, Panel Fold and Bi-fold Doors)

Side-hung external doors, including French doors, panel fold and bi-fold (a) Be protected by bushfire shutters that comply with Clause 3.7 and Clause 5.5.1.

(b) Be protected externally by screens that comply with Clause 3.6 and Clause 5.5.2.

OR
(c) conform with the following:
(i) Door panel material Materials shall be (A) non combustible; OR
(B) solid timber, laminated timber or reconstituted timber door, having a minimum thickness of 35mm for the first 400mm above the

(C) hollow core, solid timber, laminated timber or reconstituted timber with a non-combustible kickplate on the outside for the first 400mm above the threshold; OR

the threshold; OR

(D) hollow core, solid timber, laminated timber or reconstituted
r protected externally by a screen that complies with Clause 5.5.2; OR
(E) for fully framed glazed door panels, the framing is made from
or bushfire resisting timber (see Appendix F), or a timber species as
fied in Paragraph E2, Appendix E or uPVC.

(A) Bushfire-resisting timber (see Appendix F). OR

(B) a timber species as specified in Paragraph E2 of Appendix E;

(C) Metal. OR (D) Metal-reinforced PVC-U. The reinforcing members shall be de from aluminium, stainless steel, or corrosion-resistant steel. (iii) Hardware There are no specific requirements for hardwarea at this

(iii) Hardware There are no specific requirements for hardwarea at this BAL level.

(iv) Glazing the glazing shall be Grade A safety glass a minimum of 4mm in thickness, or glass blocks with no restriction on glazing methods. NOTE: Where double glazed units are used the above requirements apply to the external face of the window assembly only.

(v) Seals and weather strips Weather strips, draft excluders or draft seals shall be installed.

(vi) Screens There are no specific requirements for hardwarea at this BAL level.

(vii) Doors shall be tight-fitting to the door frame and to an abutting door,

5.5.5 DOORS-SLIDING DOORS

Sliding doors shall:
(a) Be protected by bushfire shutters that comply with Clause 3.7 and Clause 5.5.1.

(b) Be protected externally by screens that comply with Clause 3.6 and Clause 5.5.2.

OR

OR

(c) conform with the following:

(i) Frame material The material for door frames, including fully framed glazed doors, shall be
(A) Bushfire-resisting timber (see Appendix F). OR

(B) a timber species as specified in Paragraph E2 of Appendix E; OR

(C) Metal. OR

(D) Metal-reinforced uPVC. The reinforcing members shall be made from aluminium, stainless steel, or corrosion-resistant steel.

(ii) Hardware There are no specific requirements for hardwarea at this BAL level.

(iii) Glazing Where doors incorporare glazing, the glazing shall be Grade A safety glass a minimum of 4mm in thickness,
(iv) Seals and weather strips There are no specific requirements for

(v) Screens There are no specific requirements for hardwarea at this BAL (vi) Sliding panels Sliding panels shall be tight-fitting in the frames.

5.5.6 DOORS-VEHICLE ACCESS DOORS

(GARAGE DOORS)

The following apply to vehicle access doors:
(a) The lower portion of a vehicle access door that is within 400mm of the ground when the door is closed (see Figure D4, Appendix D) shall be made from (i) non combustible material; OR
(ii) bushfire-resisting timber (see Appendix F); OR
(iii) fibre- cement sheet, a minimum of 6mm in thickness; OR
(iv) a timber species as specified in Paragraph E1, Appendix E; OR

E; OR (IV) a combination of any Items (i), (iii) or (iv) above. (b) All vehicle access doors doors shall be fitted with suitable weather strips, draught seals or brushes. Door assemblies fitted with guide tracks do not need edge gap protection. NOTES:

NOTES:

1 Refer to AS/NZS 4505 for door types.

2 Gaps of door edges or building elements should be protected as per Section 3.

C5.5.6(b) These guide tracks do not provide a direct passage for embers into the building.

(c) Vehicle access doors with ventilation slots shall be protected in accordance with Clause 3.6.

5.6.1 ROOFS - GENERAL

The following apply to all types of roofs and roofing systems:
(a) Roof tiles, roof sheets and roof-covering accessories shall be

(b) The roof/wall junction shall be sealed, or otherwise protected in dance with Clause 3.6.

accordance with Clause 3.6.
(c) Roof ventilation openings, such as gable and roof vents, shall be fitted with ember guards made of non-combustible material or a mesh or perforated sheet conforming with Clause 3.6 and made of corrosion-resistant steel, bronze or aluminium.
(d) Only evaporative coolers manufactured in accordance with AS/NZS 60335.2.98 shall be used. Evaporative coolers with an internal damper to prevent the entry of embers into the roof space need to be screened externally.

5.6.2 TILED ROOFS

Tiled roofs shall be fully sarked. The sarking shall (a) be located on top of the roof framing, except that the roof battens may be fixed above the sarking; (b) cover the entire roof area including ridges and hips; and (c) extend into gutters and valleys.

5.6.3 SHEET ROOFS

Sheet roofs shall-

(a) be fully sarked in accordance with Clause 5.6.2, except that (b) have any gaps sealed at the fascia or wall line and at valleys,

hips and ridges by (i) a mesh or perforated sheet that conforms with Clause 3.6 and that is nade of corrosion-resistant steel, bronze or aluminium; or

(iii) other non-combustible material; or

(iv) a combination of any of Items (i), (ii) or (iii) above. C5.6.3 - Sarking is used as a secondary form of ember protection for the roof space to account for minor gaps that may develop in sheet

5.6.4 VERANDA, CARPORT AND AWNING ROOFS

The following apply to veranda, carport and awning roofs: (a) A veranda, carport or awning roof forming part of the main roof space [see Figure D1(a), Appendix D] shall meet all the rements for the main roof, as specified in Clauses 5.6.1,

(b) A veranda, carport or awning roof separated from the main (v) A veranus, and prior to awning two separates not the main roof space by an external wall [see Figures D1(b) and D1(c), Appendix D] complying with Clause 5.4 shall have a non-combustible roof covering, except where the roof covering is a translucent or transparent material.

NOTE: There is no requirement to line the inderside of a verandal carport or awning roof that is separated from the main roof space

5.6.5 ROOF PENETRATIONS

The following apply to roof penetrations:
(a) Roof penetrations, including roof lights, roof ventilators, roof-mounted evaporative cooling units, aerials, vent pipes and supports for solar collectors shall be sealed. The material used to seal the penetration shall be non-combustible.
(b) Openings in vented roof lights, roof ventilators or vent pipes

shall conform with Clause 3.6 and be made of corrosion-resistant steel, bronze or aluminiun

This requirement does not apply to a room sealed gas appliance. NOTE: A gas appliance designed such that air for combustion dose not enter from, or combustion products enter into, the room which the appliance is located. In the case of gas appliance flues, ember guards shall not be

NOTE: AS/NZS 5601 contains requirements for gas appliance flue systems and cowls. Advice can be obtained from manufacturers and State and Territory gas technical regulators. (c) All overhead glazing shall be Grade A safety glass complying

(d) Glazed elements in roof lights and skylights may be of polymer, provided a Grade A safety glass diffuser, complying with AS 1288, is installed under the glazing. Where glazing is an insulating glazing unit (IGU), Grade A toughened safety glass of minimum 4 mm in thickness shall be used in the outer pane of the IGU.

(e) Flashing elements of tubular skylights may be of a fire-retardan material, provided the roof integrity is maintained by an underflashing of a material having a flammability index not exceeding

five..

(f) Evaporative cooling units shall be fitted with non-combustible butterfly closers as close as practicable to the roof level, or the unit shall be fitted with non-combustible covers with a mesh or perforated sheet with a maximum aperture of 2mm, made of corrosion-resistant steel, bronze or aluminium.

(g) Vent pipes made from PVC are permitted.

(h) Eaves lighting shall be adequately sealed and not compromise the performance of the element.

5.6.6 EAVES LININGS, FASCIAS AND GABLES

The following apply to eaves linings, fascias and gables:
(a) Gables shall comply with Clause 5.4.
(b) Eaves penetrations shall be protected the same as for roof penetrations, as specified in Clause 5.6.5.

(c) Eaves ventilation openings shall be fitted with ember guards in accordance with Clause 3.6 and made of corrosion-resistant steel, bronze or aluminium

Joints in eaves linings, fascias and gables may be sealed with plastic joining strips or timber storm moulds. This standard does not provide construction requirements for fascias, bargeboards and eaves linings.

5.6.7 GUTTERS AND DOWNPIPES

This Standard does not provide material requirements for downpipe Inis Standard uodes not provide inaterial requirements to cowinpipes if installed, gutter and valley leaf guards shall be non-combustible. With the exception of box gutters, gutters shall be metal or PVC-U. Box gutters shall be non-combustible and flashed at the junction with the roof with noncombustible material.

5.7.1 VERANDAS, DECKS, STEPS AND LANDINGS - GENERAL

Decking may be spaced.

There is no requirement to enclose the subfloor spaces of verandas, decks, steps, ramps or landings.

C5.7.7 - Spaced decking is nominally spaced at 3 mm (in accordance with standard industry practice); however, due to the nature of timber decking with seasonal changes in moisture content, that spacing may range from 0 - 5 mm during service. It should be noted that recent research studies have shown that gaps at 5 mm spacing afford opportunity for embers to become lodged in between timbers, which may contribute to a fire. Larger gap spacings of 10 mm may preclude this from happening but such a spacing regime may not be practical for a timber deck.

OUSE DESIGN

PERTH 16

FACADE DESIGN:

5.7.2 ENCLOSED SUBFLOOR SPACES OF VERANDAS, DECKS, STEPS, RAMPS AND LANDINGS

5.7.2.1 Materials to enclose a subfloor space

This standard does not provide construction requirements for the materials used to enclose a subfloor space except where those materials are less than 400mm from the ground. Where the materials used to enclose a subfloor space are less than 400mm from the ground, when the materials used to enclose a subfloor space are less than 400mm from the ground, they shall conform with Clause 5.4.

This Standard does not provide construction requirements for support posts, columns, stumps, stringers, piers and poles.

This Standard does not provide construction requirements for the framing of verandas, decks, ramps or landings (i.e., bearers and joists).

5.7.2.4 Decking, stair treads and the trafficable surfaces of ramps and landings

This standard does not provide construction requirements for decking, stair treds and the trafficable surfaces and landings that are more than 300mm from a glazed element.

Decking, stair treads and the trafficable surfaces of ramps and landings less than 300mm (measured horizontally at deck level) from glazed elements that are less than 400mm (measured vertically) from the surface of the deck (see Figure D2, Appendix D) shall be made from
(a) of non-combustible material; or

(b) of bushfire-resisting timber (see Appendix F); or (c) a timber species as specified in Paragraph E1, Appendix E; or

(e) a combination of Items (a), (b), (c) or (d). 5.7.3 UNENCLOSED SUBFLOOR SPACES OF VERANDAS.

DECKS, STEPS, RAMPS AND LANDINGS

This Standard does not provide construction columns, stumps, stringers, piers and poles.

This Standard does not provide construction requirements for the framing of verandas, decks, ramps or landings (i.e., bearers and joists). 5.7.3.3 Decking, stair treads and the trafficable surfaces of ramps and landings

This Standard does not provide construction requirements for deshing, stair treds and the trafficable surfaces of ramps and landings that are more than 300mm from

Decking, stair treads and the trafficable surfaces of ramps and landings less than 300mm (measured horizontally at deck level) from glazed elements that are less than 400mm (measured vertically) from the surface of the deck (see Figure D2, Appendix D) shall be made from
(a) of non-combustible material; or

(b) of bushfire-resisting timber (see Appendix F); or (c) a timber species as specified in Paragraph E1, Appendix E; or (e) a combination of any of Items (a), (b), (c) or (d).

5.7.4 BALUSTRADES, HANDRAILS OR OTHER BARRIERS

This Standard does not provide construction requirements for balustrades,

5.7.5 VERANDA POSTS

(d) uPVC: or

5.f. 5 VEKANDA PUDIO

Verandah Posts
(a) Shall be timber mounted on galvanised mounted shoes or stirrups with a clearance of no less than 75mm above adjacent ground level; or
(b) if less than 40mm (measured vertically) from the surface of the deck or ground (see Fig D2, Appendix D) shall be made from
(i) non-combustible material; or

(ii) bushfire-resisting timber (see Appendix F); or

(iii) a timbers species as specified in Paragraph E1, Appendix E; or

(iv) a combination of any of items (a) or (b).

5.8 WATER AND GAS SUPPLY PIPES

Above-ground, exposed water and gas supply pipes shall be metal

HOUSE CODE

FACADE CODE:

H-WDCPTH10SA

SUBJECT TO NCC 2022 (1 MAY 2023)

WATERPROOFING & PLUMBING CONDENSATION MANAGEMENT

PLAN ACCEPTANCE BY OWNER SIGNATURE: SIGNATURE: DATE: PLEASE NOTE THAT VARIATIONS WILL NOT BE ACCEPTED

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JII 01/10/2025 37 KOTONA STREET, ROKEBY TAS 7019 COUNCIL .

CLARENCE

CONTEMPO F-WDCPTH10CTPOA SHEET TITLE: SHEET No.: | SCALES: BAL 12.5 NOTES 23 / 24

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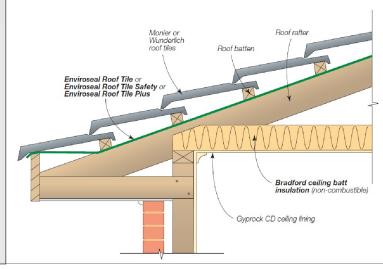
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Figure 5.1. Tiled Roofs

- Install EnviroSeal roof tile sarking on top of the roof framing and below the roof battens.
- For further fixing details contact CSR technical support.



Application	Product
Sarking	EnviroSeal [™] Resiwrap
Foil faced insulation blanket	Bradford Anticon™
Gap seal	Bradford Fireseal BAL 12.5 - 40 Blanket

Figure 5.2.1. Fascia Detail - Metal Roof (BAL12.5-40)

- Install EnviroSeal Resiwrap to the entire roof area over the top of the battens.
- · Immediately above the fascia install BAL12.5 - 40 Blanket extending up the roof and over the first batten. Compress with the roof sheeting.
- For further fixing details contact CSR technical support.

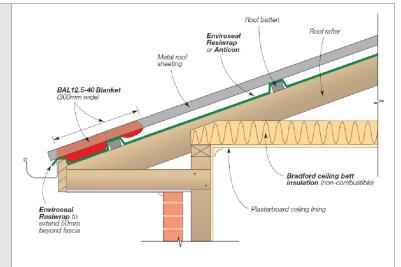


Figure 5.2.2. Valley Detail - Steel Roof (BAL-12.5 - BAL-40)

 Install EnviroSeal Resiwrap to the entire roof area over the top of the battens.

BAL12.5 - 40 Blanket to be laid over the top of the sarking extending into the outer edge of the valley gutter. Compress with roof sheeting.

 For further fixing details contact CSR technical support.

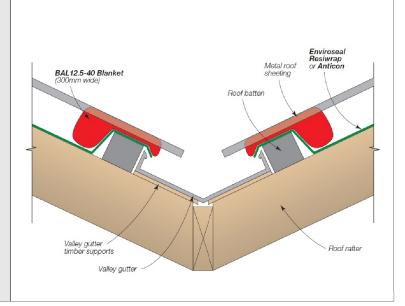


Figure 5.2.3. Barge **Detail - Steel Roof** (BAL-12.5 - BAL-40)

- Install EnviroSeal Resiwrap to the entire roof area over the top of the battens.
- At barge install BAL12.5 - 40 Blanket and compress with roof sheeting.
- For further fixing details contact CSR technical support.


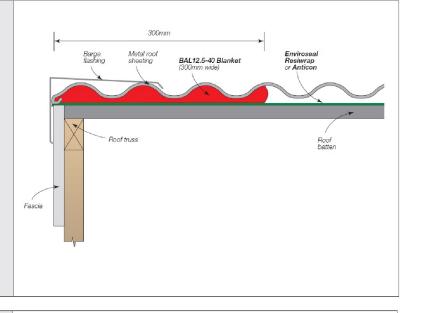


Figure 5.2.4. Hip/Ridge Detail - Steel Roof (BAL-12.5 - BAL-40)

- Install EnviroSeal Resiwrap to the entire roof area over the top of the battens.
- At the ridge/hip lay BAL12.5 - 40 Blanket over the gap between the roof sheets and compress with the ridge capping to the roof profile.
- For further fixing details contact CSR technical support.

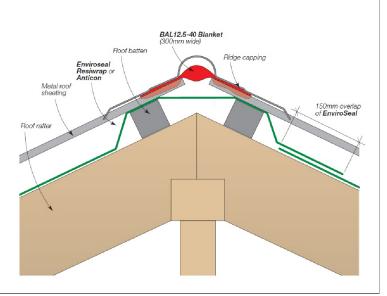

BAL-12.5 BUSHFIRE REQUIREMENTS SEE SHEET 1 (COVER SHEET) FOR DETAILS

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CONTEMPO SHEET TITLE: BAL 12.5 - BAL 40 ROOF DETAILS 24 / 24

HOUSE CODE H-WDCPTH10SA FACADE CODE: F-WDCPTH10CTPOA SHEET No.: SCALES:

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Details for the purpose of

SUBJECT TO NCC 2022 WATERPROOFING & PLUMBING CONDENSATION MANAGEMENT PLAN ACCEPTANCE BY OWNER DATE:

(1 MAY 2023)

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