

# DEVELOPMENT APPLICATION PDPLANPMTD-2025/056455

**PROPOSAL:** Additions & Partial Change of use to Visitor

Accommodation

**LOCATION:** 36 Blaney Street, Dulcot

**RELEVANT PLANNING SCHEME:** Tasmanian Planning Scheme - Clarence

**ADVERTISING EXPIRY DATE:** 15 December 2025

The relevant plans and documents can be inspected at the Council offices, 38 Bligh Street, Rosny Park, during normal office hours until 15 December 2025. In addition to legislative requirements, plans and documents can also be viewed at <a href="https://www.ccc.tas.gov.au">www.ccc.tas.gov.au</a> during these times.

Any person may make representations about the application to the Chief Executive Officer, by writing to PO Box 96, Rosny Park, 7018 or by electronic mail to <a href="mailto:clarence@ccc.tas.gov.au">clarence@ccc.tas.gov.au</a>. Representations must be received by Council on or before 15 December 2025.

To enable Council to contact you if necessary, would you please also include a day time contact number in any correspondence you may forward.

Any personal information submitted is covered by Council's privacy policy, available at <a href="https://www.ccc.tas.gov.au">www.ccc.tas.gov.au</a> or at the Council offices.

# Clarence City Council



#### APPLICATION FOR DEVELOPMENT / USE OR SUBDIVISION

The personal information on this form is required by Council for the development of land under the Land Use Planning and Approvals Act 1993. We will only use your personal information for this and other related purposes. If this information is not provided, we may not be able to deal with this matter. You may access and/or amend your personal information at any time. How we use this information is explained in our **Privacy Policy**, which is available at <a href="https://www.ccc.tas.gov.au">www.ccc.tas.gov.au</a> or at Council offices.

Proposal:	New visitors accomodation & shed	
Location:	Address 36 Blaney St  Suburb/Town Dulcot Postcode 7025	
Current Owners/s: Applicant:	Personal Information Removed	
Tax Invoice for application fees to be in the name of: (if different from applicant)	Is the property on the Tasmanian Heritage Register?  Yes  No  (if yes, we recommend you discuss your proposal with Heritage Tasmania prior to lodgement as	
	exemptions may apply which may save you time on your proposal)	

38 Bligh Street, Rosny Park, Tasmania • Address correspondence to: General Manager, PO Box 96, Rosny Park 7018 • Dx: 70402 Telephone (03) 6217 9550 • Email cityplanning@ccc.tas.gov.au • Website www.ccc.tas.gov.au

If you had pre-application Officer, please give the	ation discussions with a Council neir name			
Current Use of Site:	Residential Dwelling			
Does the proposal in	volve land administered or owned	Yes	No	<b>/</b>

#### Declaration:

- I have read the Certificate of Title and Schedule of Easements for the land and am satisfied that this application is not prevented by any restrictions, easements or covenants.
- I authorise the provision of a copy of any documents relating to this application to any person for the purposes of assessment or public consultation. I agree to arrange for the permission of the copyright owner of any part of this application to be obtained. I have arranged permission for Council's representatives to enter the land to assess this application
- I declare that, in accordance with Section 52 of the Land Use Planning and Approvals Act 1993, that I have notified the owner of the intention to make this application. Where the subject property is owned or controlled by Council or the Crown, their signed consent is attached. Where the application is submitted under Section 43A, the owner's consent is attached.
- I declare that the information in this declaration is true and correct.

#### Acknowledgement: •

I acknowledge that the documentation submitted in support of my application will become a public record held by Council and may be reproduced by Council in both electronic and hard copy format in order to facilitate the assessment process; for display purposes during public consultation; and to fulfil its statutory obligations. I further acknowledge that following determination of my application, Council will store documentation relating to my application in electronic format only.

Applicant's Signature:

## **Personal Information Removed**

PLEASE REFER TO THE DEVELOPMENT/USE AND SUBDIVISION CHECKLIST ON THE FOLLOWING PAGES TO DETERMINE WHAT DOCUMENTATION MUST BE SUBMITTED WITH YOUR APPLICATION.

# Clarence City Council



#### DEVELOPMENT/USE OR SUBDIVISION CHECKLIST

#### Documentation required:

#### 1. MANDATORY DOCUMENTATION

This information is required for the application to be valid. An application lodged without these items is unable to proceed. Details of the location of the proposed use or development. A copy of the current Certificate of Title, Sealed Plan, Plan or Diagram and Schedule of Easements and other restrictions for each parcel of land on which the use or development is proposed. Full description of the proposed use or development. Description of the proposed operation. May include where appropriate: staff/student/customer numbers; operating hours; truck movements; and loading/unloading requirements; waste generation and disposal; equipment used; pollution, including noise, fumes, smoke or vibration and mitigation/management measures. Declaration the owner has been notified if the applicant is not the owner. Crown or Council consent (if publically-owned land). Any reports, plans or other information required by the relevant zone or code. Fees prescribed by the Council. Application fees (please phone 03 6217 9550 to determine what fees apply). An invoice will be emailed upon lodgement.

#### 2. ADDITIONAL DOCUMENTATION

In addition to the mandatory information required above, Council may, to enable it to consider an application, request further information it considers necessary to ensure that the proposed use or development will comply with any relevant standards and purpose statements in the zone, codes or specific area plan, applicable to the use or development.

#### Site analysis plan and site plan, including where relevant:

- Existing and proposed use(s) on site.
- Boundaries and dimensions of the site.
- Topography, including contours showing AHD levels and major site features.
- Natural drainage lines, watercourses and wetlands on or adjacent to the site.
- Soil type.
- Vegetation types and distribution, and trees and vegetation to be removed.
- Location and capacity of any existing services or easements on/to the site.
- Existing pedestrian and vehicle access to the site.
- Location of existing and proposed buildings on the site.
- Location of existing adjoining properties, adjacent buildings and their uses.
- Any natural hazards that may affect use or development on the site.
- Proposed roads, driveways, car parking areas and footpaths within the site.
- Any proposed open space, communal space, or facilities on the site.
- Main utility service connection points and easements.
- Proposed subdivision lot boundaries.

38 Bligh Street, Rosny Park, Tasmania • Address correspondence to: General Manager, PO Box 96, Rosny Park 7018 • Dx: 70402 Telephone (03) 6217 9550 • Email cityplanning@ccc.tas.gov.au • Website www.ccc.tas.gov.au

# Clarence City Council



**DEVELOPMENT/USE OR SUBDIVISION CHECKLIST** 


- Where it is proposed to erect buildings, **detailed plans** with dimensions at a scale of 1:100 or 1:200 showing:
  - Internal layout of each building on the site.
  - Private open space for each dwelling.
  - External storage spaces.
  - Car parking space location and layout.
  - Major elevations of every building to be erected.
  - Shadow diagrams of the proposed buildings and adjacent structures demonstrating the extent of shading of adjacent private open spaces and external windows of buildings on adjacent sites.
  - Relationship of the elevations to natural ground level, showing any proposed cut or fill.
  - Materials and colours to be used on rooves and external walls.
- ☐ Where it is proposed to erect buildings, a plan of the proposed **landscaping** showing:
  - Planting concepts.
  - Paving materials and drainage treatments and lighting for vehicle areas and footpaths.
  - Plantings proposed for screening from adjacent sites or public places.
- Any additional reports, plans or other information required by the relevant zone or code.

This list is not comprehensive for all possible situations. If you require further information about what may be required as part of your application documentation, please contact Council's Planning Officers on (03) 6217 9550 who will be pleased to assist.



## **RESULT OF SEARCH**

RECORDER OF TITLES

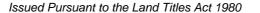



#### SEARCH OF TORRENS TITLE

VOLUME 4204.4	FOLIO
43614	4
EDITION	DATE OF ISSUE
5	07-Apr-2011

SEARCH DATE : 28-Jan-2025 SEARCH TIME : 03.59 PM

#### DESCRIPTION OF LAND

Town of DULCOT

Lot 4 on Diagram 43614

Derivation: Whole of 1A-OR-OPs. & 2A-OR-OPs. Granted to R.

Hanslow and Part of 3A-OR-OPs. Granted to R. Hanslow

Prior CT 4705/58

#### SCHEDULE 1

M321763 TRANSFER to RODNEY JAMES WILLIE and TAMEEKA ANN

PEARSON Registered 07-Apr-2011 at noon

#### SCHEDULE 2

Reservations and conditions in the Crown Grant if any

C979956 ENCUMBRANCE to Dulcot Water Association Inc

Registered 23-Aug-2010 at noon

D7807 MORTGAGE to MyState Financial Limited Registered

07-Apr-2011 at 12.01 PM

#### UNREGISTERED DEALINGS AND NOTATIONS

No unregistered dealings or other notations




### **FOLIO PLAN**

RECORDER OF TITLES

Issued Pursuant to the Land Titles Act 1980



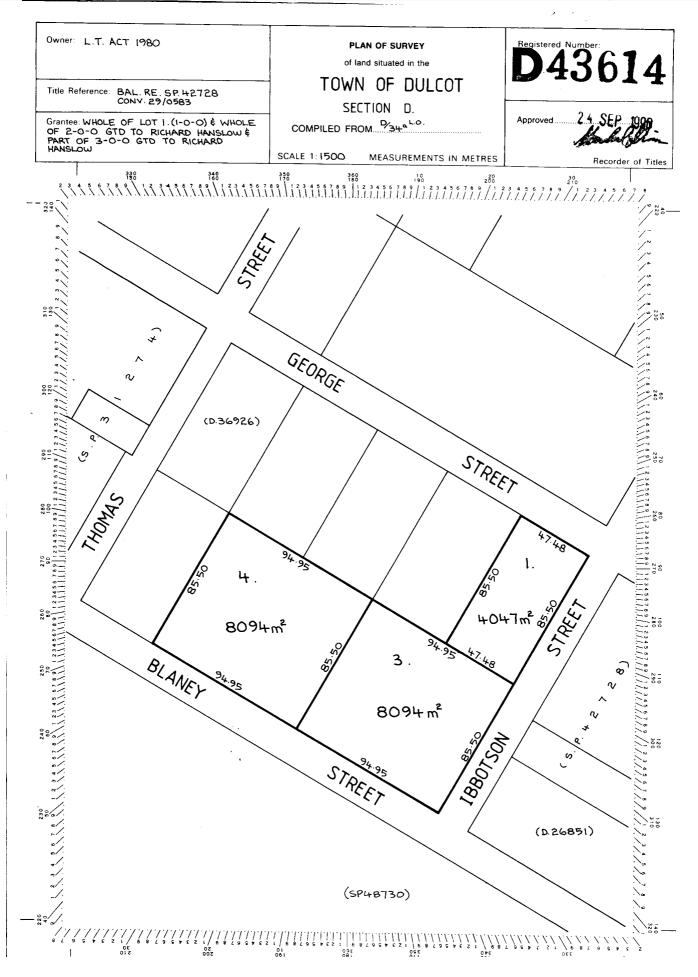

Search Date: 28 Jan 2025

Search Time: 03:59 PM

Volume Number: 43614

Revision Number: 01

Page 1 of 1

# PINNACLE







Note: The images provided are artistic representations only and should not be used as references for final colours, finishes, or external/internal features.

## 36 Blaney Street, Dulcot, 7025

Owner(s) or Clients Building Classification

Designer

Total Floor Area (Combined)

Alpine Area

Other Hazards

Rodney Willie & Tameeka Pearson

1a & 10a

Jason Nickerson CC6073Y

98.55m<sup>2</sup>

Deck 23.67m<sup>2</sup>

N/A

Priority vegetation area, Bushfire-prone areas, Airport obstacle limitation area, Low landslip hazard band

Title Reference Rural Living Zoning Land Size 8094m<sup>2</sup> Design Wind Speed N3

Soil Classification Climate Zone

Corrosion Environment

Bushfire Attack Level (BAL)

43614/4 Low

Р

7

12.5/19

**Changes List** 

Description of change


**Date Changed** 


Designer

ID	Sheet Name	Issue
A.01	Existing Location Plan	DA - 01
A.02	Proposed Location Plan	DA - 01
A.03	Site Plan	DA - 01
A.04	Floor Plan - Visitors Accom.	DA - 01
A.05	Elevations - Visitors Accom.	DA - 01
A.06	Elevations - Visitors Accom.	DA - 01
A.07	Shed Floor Plan & Elevations	DA - 01
A.08	Roof Plan - Visitors Accom. & Shed	DA - 01
A.09	Electrical Plan - Visitor Accom & Shed	DA - 01
A.10	Door & Window Schedule - Visitors Accom. & Shed	DA - 01





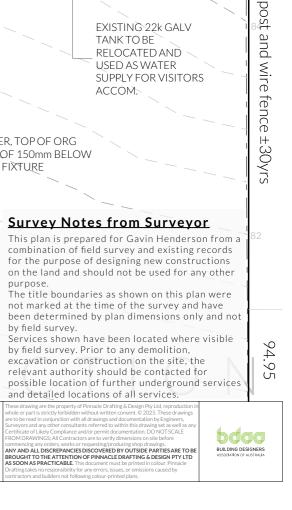

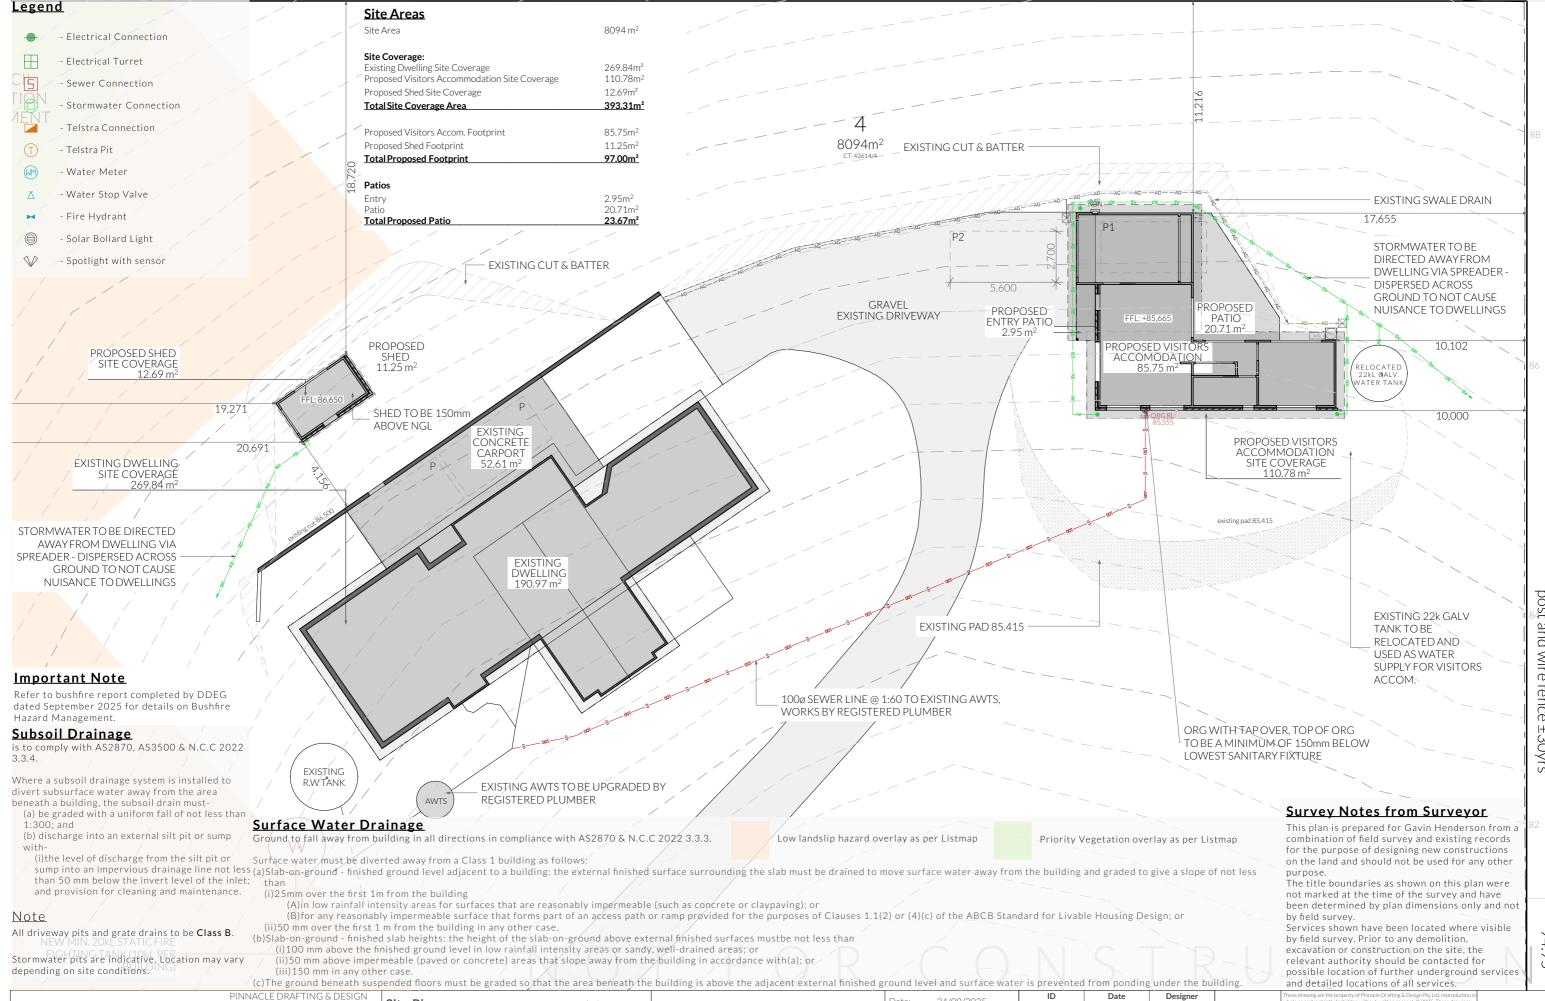

Proposal: Visitor Accommodation & Shed

Address: 36 Blaney Street, Dulcot, 7025

Client: Rodney Willie & Tameeka Pearson

Date:

Drawn by: CJ

Job No: 005-2025

Engineer: Aldanmark

Building Surveyor: Pitt & Sherr

24/09/2025

Document Set ID: 5726961 Version: 1, Version Date: 21/10/2025

PINNACLE

Site Plan

Revision:

Approved by:

DA - 01

JN/SH

7/3 Abernant Way, Cambridge 7170

admin@pinnacledrafting.com.au

www.pinnacledrafting.com.au

03 6248 4218

Licence: CC6073Y

Scale:

Pg. No:

A.03

1:200 @ A3



Articulation Joint

## (SA) Smoke Alarm

#### Construction of sanitary compartments 10.4.2 of NCC 2022

The door to a fully enclosed sanitary compartment must -

- open outwards; or
- slide; or
- be readily removable from the outside of the compartment.

unless there is a clear space of at least 1.2 m, measured in accordance with Figure 10.4.2 of NCC 2022 Vol II, between the closet pan within the sanitary compartment and the

#### Note: Safe Movement & Egress

Openable windows greater than 4m above the surface below are to be fitted with a device to limit opening or a suitable screen so a 125mm sphere cannot pass through. Except for Bedrooms, where the requirement is for heights above 2m. Refer to clauses 11.3.7 and 11.3.8 of NCC 2022 for further information on suitable protective devices.

#### Note: Paved Areas

All paths and patios to fall away from dwelling.

#### Note: Stair Construction

All stairs to be constructed in accordance with NCC Vol II 2022 Part 11.2.2:

Riser: Min 115mm - Max 190mm

Going: Min 240mm - Max 355mm Slope (2R+G): Max 550 - Min 700

For stairways serving non-habitable room used infrequently, refer to table 11.2.2(b).

Landings to comply with Clause 11.2.5 and be a minimum of 750mm deep measured 500mm from the inside edge of the

Slip resistance of treads, nosings and ramps to comply with

#### Heights of rooms & other spaces 10.3.1 of NCC 2022

Heights of rooms and other spaces must not be less than; (a)in a habitable room excluding a kitchen - 2.4 m; and (b)in a kitchen - 2.1 m; and


(c)in a corridor, passageway or the like - 2.1 m; and (d)in a bathroom, shower room, laundry, sanitary compartment, airlock, pantry, storeroom, garage, car parking area or the like -2.1 m; and

(e) in a room or space with a sloping ceiling or projections below the ceiling line within- See NCC directly for these items (f)in a stairway, ramp, landing, or the like - 2.0 m measured vertically above the nosing line of stairway treads or the floor surface of a ramp, landing or the like.

If required onsite, the builder may work within the tolerances of the above as specified within the NCC 2022 Vol II. Builder to contact Pinnacle before undertaking works.

#### **RENOVATION LEGEND**

**E**XISTING DEMOLITION NEW CONSTRUCTION

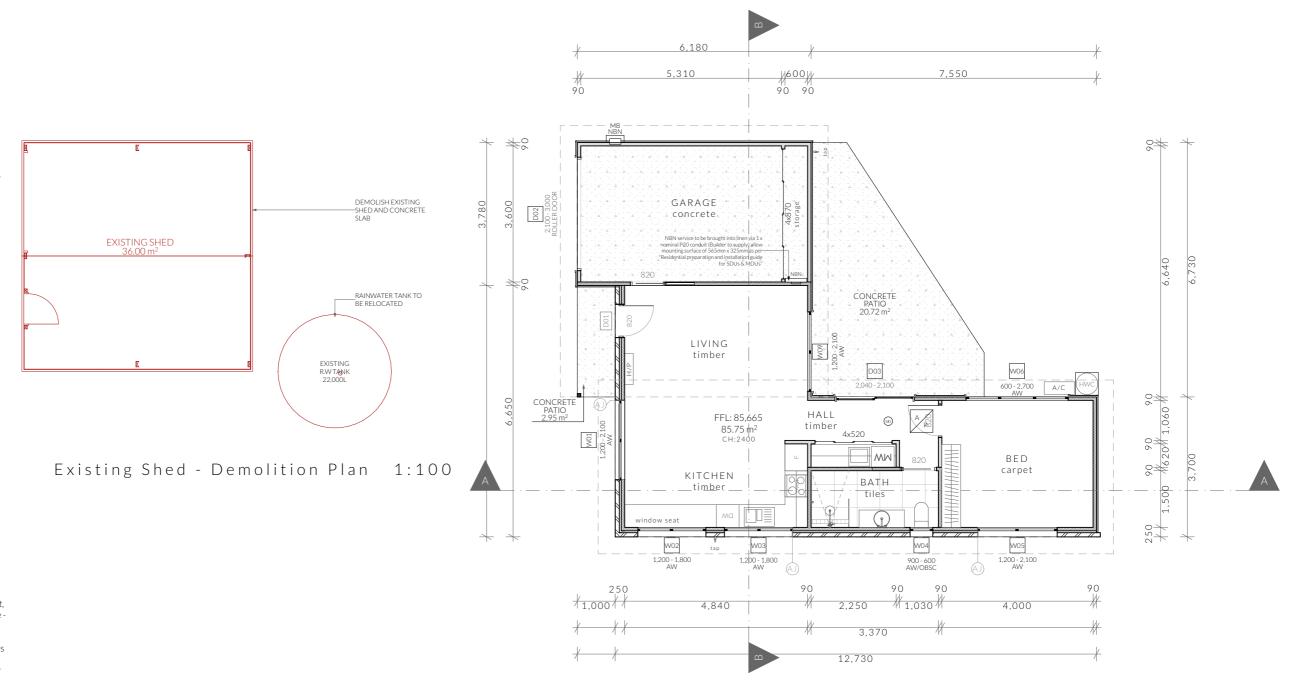

Proposed Floor Plan

1:100

#### **Floor Areas**

85.75m<sup>2</sup> Total Floor Area Proposed Patio 1 2.95m<sup>2</sup> 20.72m<sup>2</sup> Proposed Patio 2

PINNACLE

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Licence: CC6073Y

Floor Plan - Visitors Accom.

DA - 01

JN/SH

Revision:

Approved by:


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Proposal: Visitor Accommodation & Shed Rodney Willie & Tameeka Pearson Address: 36 Blaney Street, Dulcot, 7025

Date Designer Date: Drawn by: CJ Job No: 005-2025 Engineer: Aldanmark Building Surveyor: Pitt & Sherry






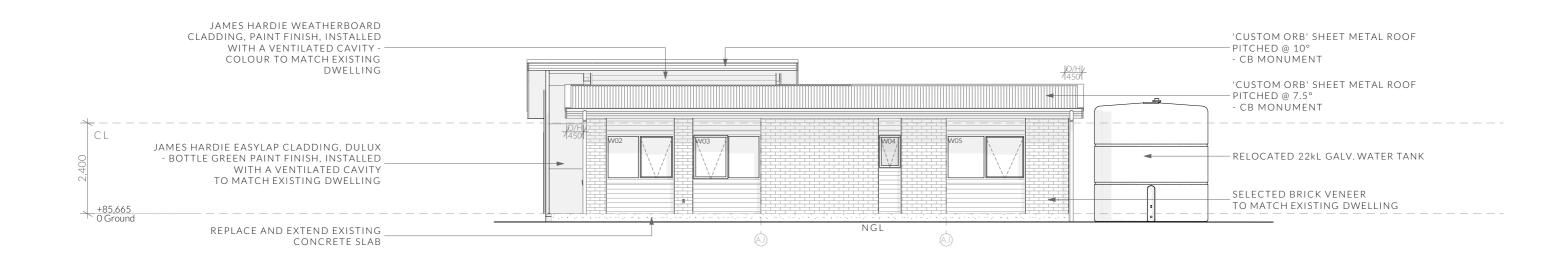

South East Elevation

1:100

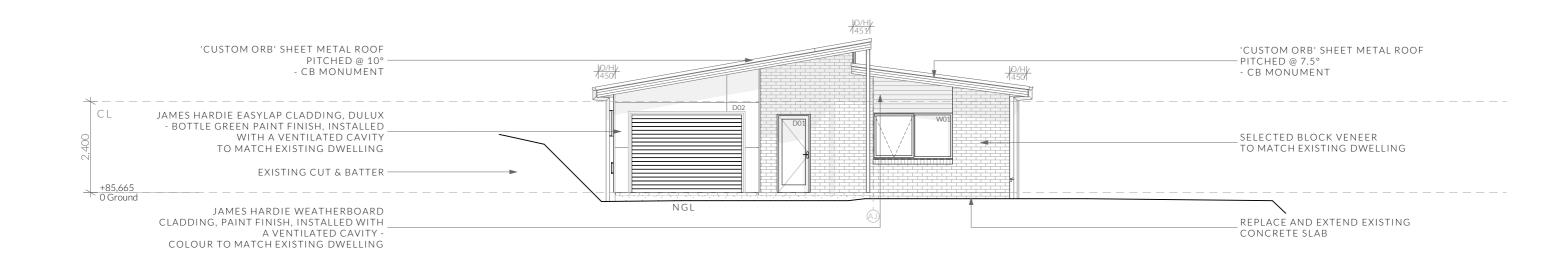

South West Elevation

1:100

Clearances between cladding and ground shall comply with Clause 7.5.7 of the NCC 2022 and shall be a minimum clearance of:

100mm in low rainfall intensity areas or sandy, well-drained areas; or 50mm above impermeable areas that slope away from the building; or 150mm in any other case.

Wall cladding must extend a minimum of 50 mm below the bearer or lowest horizontal part of the suspended floor framing.

U.N.O in builders specifications or located in saline environments or if using a glazed finish brick, brickwork is to be installed in stretcher bond pattern with raked joints.

Openable windows greater than 4m above ground level are to be fitted with a device to limit the opening or a suitable screen so a 125mm sphere cannot pass through, and withstand a force of 250N. Except for bedrooms, where the requirement is for heights above 2m.

Revision:

Approved by:

All stairs to be constructed in accordance with NCC 2022 Vol II Part 11.2.2

Riser: Min 115mm - Max 190mm Going: Min 240mm - Max 355mm PINNACLE 03 6248 4218

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Elevations - Visitors Accom.

Slope (2R+G): Max 550 - Min 700

DA - 01

JN/SH

1:100 @ A3 Pg. No: A.05

Scale:

Proposal: Visitor Accommodation & Shed Client: Rodney Willie & Tameeka Pearson Address: 36 Blaney Street, Dulcot, 7025

Date: Drawn by: CJ Job No: 005-2025 Engineer: Aldanmark

Designer Building Surveyor: Pitt & Sherry


commencing any orders, works or requesting producing snop drawings.

ANY AND ALL DISCREPANCIES DISCOVERED BY OUTSIDE PARTIES ARE TO I

BROUGHT TO THE ATTENTION OF PINNACLE DRAFTING & DESIGN PTY LTC


AS SOON AS PRACTICABLE. This document must be printed in colour. Pinnacle



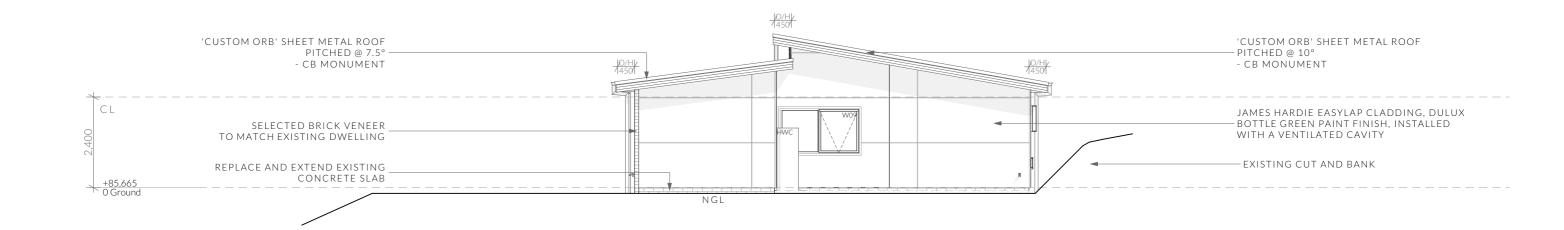

North East Elevation

1:100

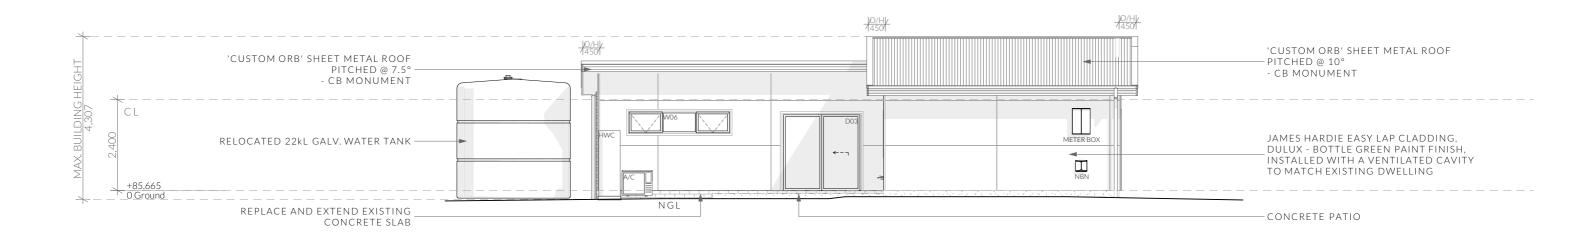

North West Elevation

1:100

Clearances between cladding and ground shall comply with Clause 7.5.7 of the NCC 2022 and shall be a minimum clearance of:

100mm in low rainfall intensity areas or sandy, well-drained areas; or 50mm above impermeable areas that slope away from the building; or 150mm in any other case.

Wall cladding must extend a minimum of 50 mm below the bearer or lowest horizontal part of the suspended floor framing.

U.N.O in builders specifications or located in saline environments or if using a glazed finish brick, brickwork is to be installed in stretcher bond pattern with raked joints.

Openable windows greater than 4m above ground level are to be fitted with a device to limit the opening or a suitable screen so a 125mm sphere cannot pass through, and withstand a force of 250N. Except for bedrooms, where the requirement is for heights above 2m.

Revision:

Approved by:

All stairs to be constructed in accordance with NCC 2022 Vol II Part 11.2.2

Riser: Min 115mm - Max 190mm Going: Min 240mm - Max 355mm PINNACLE DRAFTING & DESIGN 7/3 Abernant Way, Cambridge 7170 PINNACLE

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Elevations - Visitors Accom.

Slope (2R+G): Max 550 - Min 700

DA - 01

JN/SH

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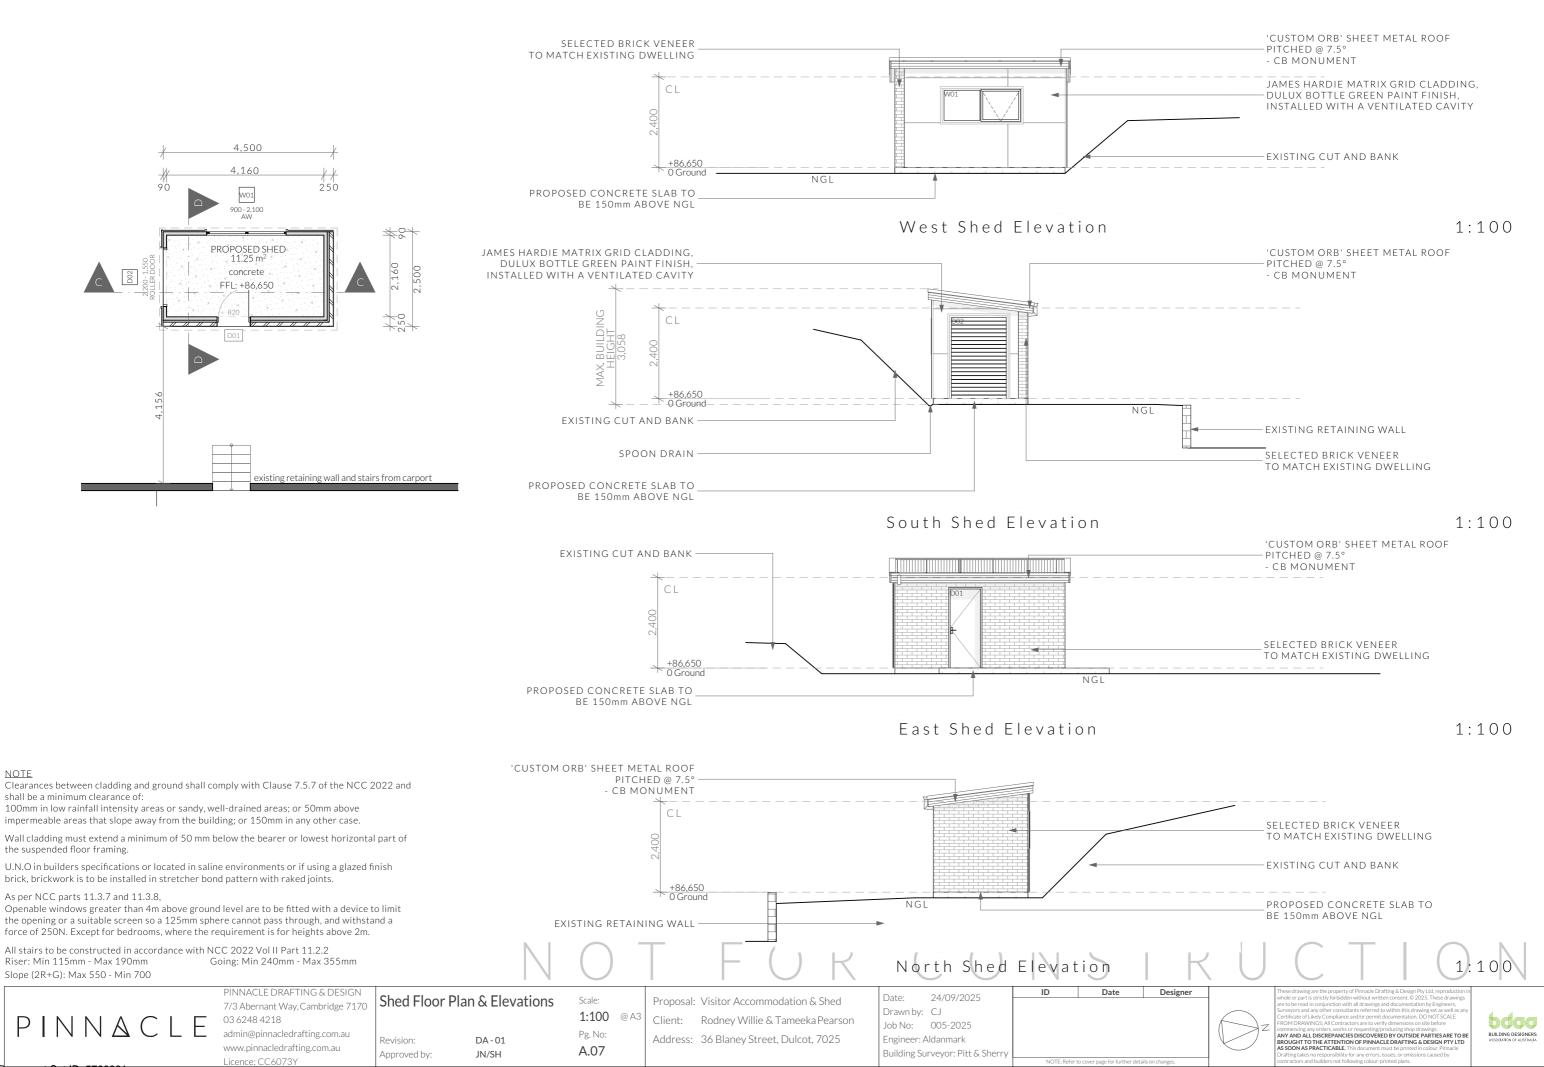
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Proposal: Visitor Accommodation & Shed Client: Rodney Willie & Tameeka Pearson Address: 36 Blaney Street, Dulcot, 7025

Date: Drawn by: CJ Job No: 005-2025

Designer Engineer: Aldanmark Building Surveyor: Pitt & Sherry





Document Set ID: 5726961 Version: 1, Version Date: 21/10/2025

NOTE

#### Ventilation of roof spaces NCC 2022 Part 10.8.3

A roof must have a roof space that-

(a)is located-

(i)immediately above the primary insulation layer; (ii)immediately above sarking with a vapour permeance of not less than 1.14 µg/N.s, which is

immediately above the primary insulation layer; (iii)immediately above ceiling insulation; and (b) has a height of not less than 20 mm; and

(c)is either-(i)ventilated to outdoor air through evenly distributed openings in accordance with Table

(ii)located immediately underneath the roof tiles of an unsarked tiled roof.

#### **Stormwater Notes**

All gutters, downpipes and rain heads to be designed and installed in compliance with AS3500.3 & NCC 2022 Volume II Part 7.4.

#### **Roofing Cladding**

Roof cladding, flashings, cappings, roof sheeting and fixings are to be installed in accordance with NCC 2022 Volume II Part 7.2 for sheet roofing and Part 7.3 for tiled and shingle roofing.

#### **Eaves & Soffit Linings**

To comply with NCC 2022 Vol II Part 7.5.5 and where provided, external fibre-cement sheets and linings used as eaves and soffit linings must-

(a)comply with AS/NZS 2908.2 or ISO 8336; and (b) be fixed in accordance with Table 7.5.5 and Figure 7.5.5 using-

(i)  $2.8 \times 30$  mm fibre-cement nails; or (ii) No. 8 wafer head screws (for 4.5 mm and 6 mm


sheets only); or (iii) No. 8 self embedding head screws (for 6 mm

Refer to table 7.5.5 for trimmer and fastener spacings.


**ROOF PITCH VENTILATION OF OPENINGS (TABLE 10.8.3)** < 100 25,000 mm2/m provided at each of two opposing ends

(1) Ventilation openings are specified as a minimum free open area per metre length of the longest horizontal dimension of the roof.

(2)For the purposes of this Table, high level openings are openings provided at the ridge or not more than 900 mm below the ridge or highest point of the roof space, measured vertically.

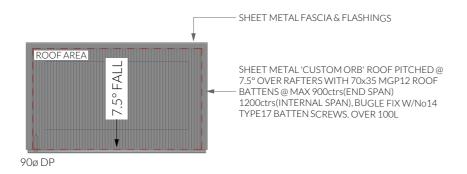

Shed Roof Plan

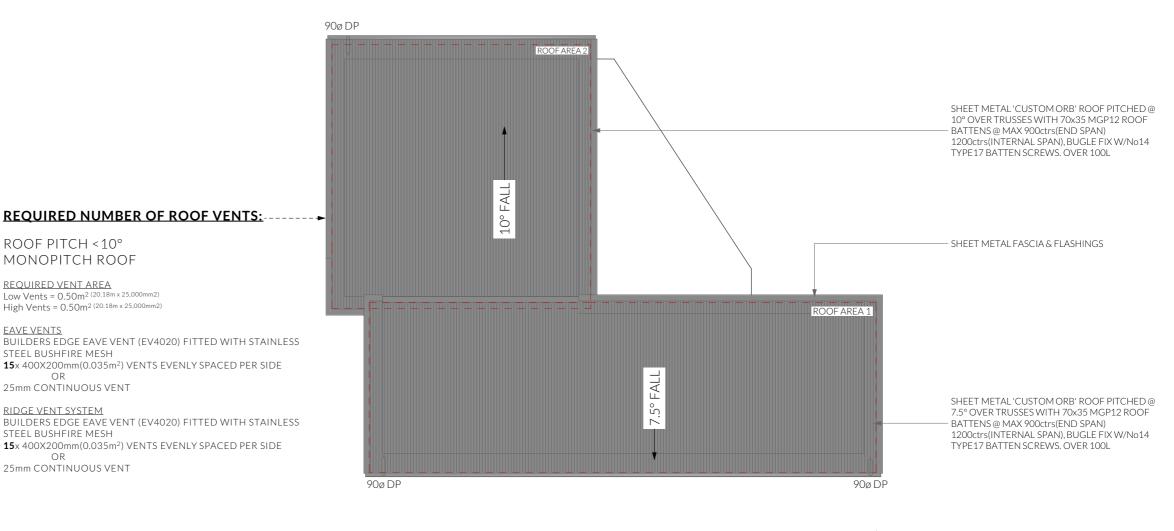

Visitors Accom. Roof Plan

PINNACLE

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ROOF PITCH < 10°

REQUIRED VENT AREA Low Vents = 0.50m<sup>2</sup> (20.18m × 25,000mm2) High Vents =  $0.50m^2$  (20.18m x 25,000mm2)

STEEL BUSHFIRE MESH

RIDGE VENT SYSTEM

STEEL BUSHFIRE MESH

25mm CONTINUOUS VENT

Revision:

Approved by:

25mm CONTINUOUS VENT

**EAVE VENTS** 

MONOPITCH ROOF

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Roof Plan - Visitors Accom. & Shed

DA - 01

JN/SH

1:100 @ A3 Pg. No: A.08

Scale:

Proposal: Visitor Accommodation & Shed Client: Rodney Willie & Tameeka Pearson Address: 36 Blaney Street, Dulcot, 7025

Date: 24/09/2025 Drawn by: CJ Job No: 005-2025 Engineer: Aldanmark

Building Surveyor: Pitt & Sherry

Designer

Date





#### **ELECTRICAL LEGEND**

Symbol	Description	Allowance	Quantity
600H <b>∇</b> □	DATA- CAT 6 (RJ45) - 1 GANG		2
600H <b>Џ</b> ™	DATA- TV CONNECTION		1
B	FAN - 3 IN 1 (2 LAMP)	10W (LIGHT)	1
(5)	FAN - CEILING - EXHAUST		2
1,800H	GPO - (1) SINGLE		1
300H 2	GPO - (2) DOUBLE		14
2 ISO	GPO - (2) DOUBLE (WITH COOKTOP ISOLATOR SWITCH)		1
300H W/PROOF	GPO - WEATHER PROOF DOUBLE		1
$\otimes_{_{R}}$	LIGHT - CEILING - DOWNLIGHT RECESSED	10W	11
	LIGHT - CEILING - LED BATTEN	20W	2
$\overline{\otimes}_{W1}$	LIGHT - WALL MOUNTED - TYPE 1	10W	2
Ь	SWITCH - LIGHT 1 GANG		7

#### Smoke Alarms Part 9.5 of NCC 2022

Smoke alarms must-

(a) be located in-

(i)a Class 1a building in accordance with 9.5.2 and 9.5.4; and (ii)a Class 1b building in accordance with 9.5.3 and 9.5.4;

(b)comply with AS 3786, except that in a Class 10a private garage where the use of the area is likely to result in smoke alarms causing spurious signals, any other alarm deemed suitable in accordance with AS 1670.1 may be installed provided that smoke alarms complying with AS 3786 are installed elsewhere in the Class 1 building; and (c)be powered from the consumer mains source where a

consumer mains source is supplied to the building; and be interconnected where there is more than one alarm. In a Class 1a building, smoke alarms must be located in-(a) any storey containing bedrooms, every corridor or hallway

associated with a bedroom, or if there is no corridor or hallway, in an area between the bedrooms and the

remainder of the building; and (b) each other storey not containing bedrooms.

Smoke alarms required by 9.5.2 and 9.5.3 must be installed on or near the ceiling, in accordance with the following:

(a)Where a smoke alarm is located on the ceiling it must be-(i)a minimum of 300 mm away from the corner junction of the wall and ceiling; and

(ii)between 500 mm and 1500 mm away from the high point and apexes of the ceiling, if the room has a sloping ceiling. (b) Where (a) is not possible, the smoke alarm may be installed on the wall, and located a minimum of 300 mm and a maximum of 500 mm off the ceiling at the junction with the

#### **Note: Exhaust Fans**

Exhaust fans to comply with NCC 2022 Vol 2 Part 10.8.2 and

-An exhaust system installed in a kitchen, bathroom, sanitary compartment or laundry must have a minimum flow rate of-(a)25 L/s for a bathroom or sanitary compartment; and (b)40 L/s for a kitchen or laundry.

-Exhaust from a kitchen, kitchen range hood, bathroom, sanitary compartment or laundry must discharge directly or via a shaft or duct to outdoor air.

-Where a venting clothes dryer is installed, it must discharge directly or via a shaft or duct to outdoor air.

-An exhaust system that is not run continuously and is serving a bathroom or sanitary compartment that is not ventilated in accordance with 10.6.2(a) must-

(a) be interlocked with the room's light switch: and (b)include a run-on timer so that the exhaust system continues to operate for 10 minutes after the light switch is turned off.

#### **Note: Lighting**


Lighting layout may change, owner to confirm with builder prior to purchase/installation of exact quantity and location of electrical services provided that installation is compliant with AS3000 and artificial lighting allowances do not exceed:

5W/m<sup>2</sup> in class 1a dwellings

4W/m<sup>2</sup> to veranda, balcony or the like

3W/m² in a class 10a dwelling associated with the class 1a dwelling

U.N.O - All downlights are to be Insulation Contact (IC) rated.

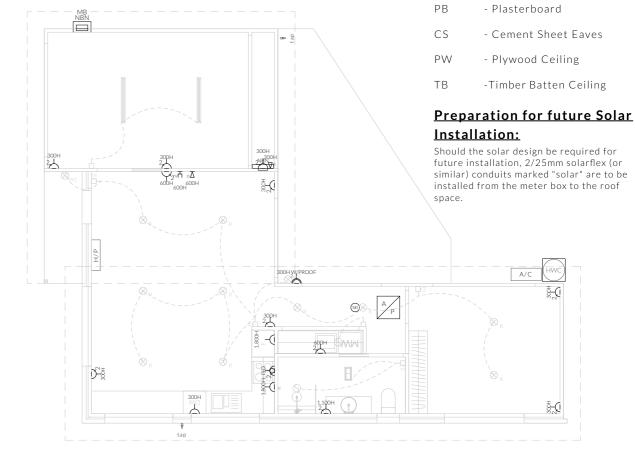

Electrical Plan - Visitors Accom. - Light/Reflected Ceiling

Electrical Plan - Visitors Accom. - Power



Electrical Plan - Shed - Light/Reflected Ceiling



Electrical Plan - Shed - Power

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Licence: CC6073Y

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Electrical Plan - Visitor Accom & Shed DA - 01

JN/SH

Approved by:

Scale: 1:100 @ A3 Pg. No:

A.09

Proposal: Visitor Accommodation & Shed Rodney Willie & Tameeka Pearson Address: 36 Blaney Street, Dulcot, 7025

Date: 24/09/2025 Drawn by: CJ Job No: 005-2025

Engineer: Aldanmark

Building Surveyor: Pitt & Sherry

Designer



<u>Notes</u>

U.N.O ceilings are to be plasterboard.


--т----т Timer Circuit(as fan note)


--□---- Dimmable Circuit

bdaa

PINNACLE


#### Door & Window Schedule - Visitors Accommodation

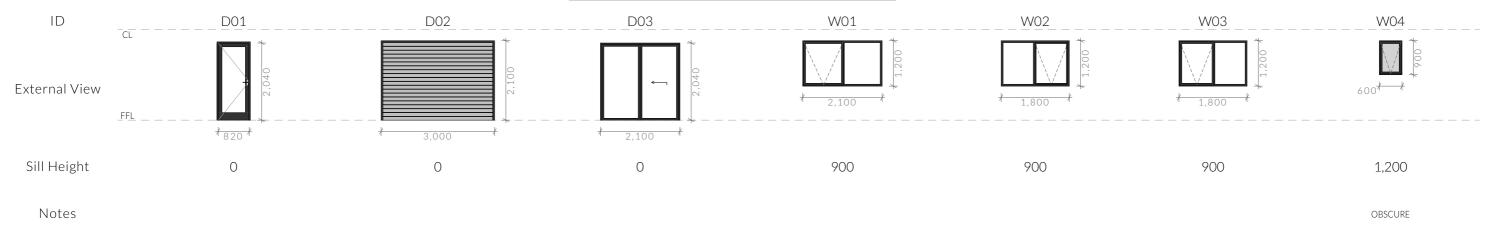

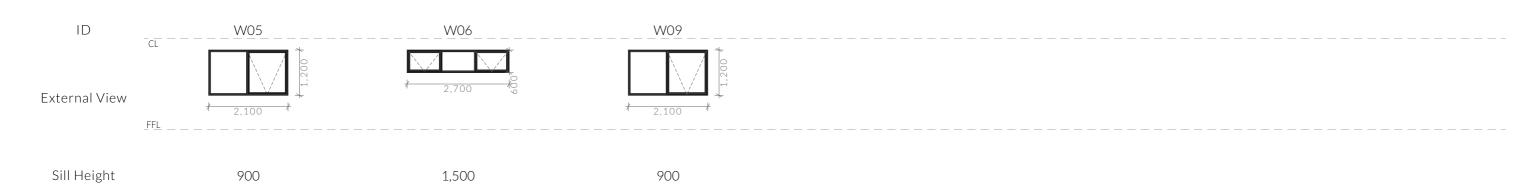

Notes

#### Door & Window Schedule - Shed

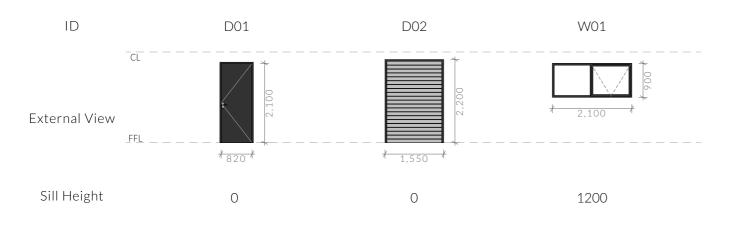

PINNACLE DRAFTING & DESIGN

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#### Important note

All visitors accom. windows to be in compliance with BAL 12.5/19 requirements. All shed windows to be in compliance with **BAL 19** requirements. Refer to Bushfire Protection Plan.

#### Important Note

- Glazing to be Reduced- or low-reflectivity glass (0-10% reflectivity) wherever possible. Alternative options are set out in Section 4.2.3 Bird-friendly applications: micro scale of the Minimizing the Swift Parrot Collision Threat where unable to meet the reduced or low-reflectivity glass option.

Some of these examples are:

- installing internal screens as close to the glass as possible so as to maximise the noise projected through the window
- attaching external screens to operable windows; (applicable in bushfire prone areas)
- attaching exterior decorative grilles, provided the sections are less than 28 cm wide (10 cm/handprint width being optimal);

#### **Glazing**

All glazing must comply with Section 8 of NCC Vol II 2022.

Windows must be installed in accordance with the following:

- (a)Structural building loads must not be transferred to the window assembly.
- (b)A minimum 10 mm gap must be provided between the top of the window assembly and any loadbearing framing or masonry wall
- (c)The requirements of (b) may be increased where necessary to allow for frame settlement over wide openings.

Designer

- (d) Packing, if provided between each window assembly and the frame, must be-
- (i)located along each side and bottom; and
- (ii)fixed to ensure the sides and bottom of the window assembly remain straight; and

Date

(iii) clear of any flashing material.

If a door, side panel or panel is capable of being mistaken for a doorway or opening, the glass must be marked to make it readily visible with an opaque band not less than 20 mm in height located so that-

- (a) the upper edge is not less than 700 mm above the floor; and
- (b) the lower edge is not more than 1.2 m above the floor

Refer to Part 8.4.7 for exemptions

Date:



Door & Window Schedule -Visitors Accom. & Shed

Approved by:

DA - 01 JN/SH

Pg. No:

Scale:

A.10

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