

# DEVELOPMENT APPLICATION PDPLANPMTD-2025/056945

**PROPOSAL:** Outbuilding (Single Dwelling)

**LOCATION:** 3 Starlight Drive, Cambridge

**RELEVANT PLANNING SCHEME:** Tasmanian Planning Scheme - Clarence

**ADVERTISING EXPIRY DATE:** 08 December 2025

The relevant plans and documents can be inspected at the Council offices, 38 Bligh Street, Rosny Park, during normal office hours until 08 December 2025. In addition to legislative requirements, plans and documents can also be viewed at <a href="https://www.ccc.tas.gov.au">www.ccc.tas.gov.au</a> during these times.

Any person may make representations about the application to the Chief Executive Officer, by writing to PO Box 96, Rosny Park, 7018 or by electronic mail to <a href="mailto:clarence@ccc.tas.gov.au">clarence@ccc.tas.gov.au</a>. Representations must be received by Council on or before 08 December 2025.

To enable Council to contact you if necessary, would you please also include a day time contact number in any correspondence you may forward.

Any personal information submitted is covered by Council's privacy policy, available at www.ccc.tas.gov.au or at the Council offices.



**City of Clarence** 

38 Bligh St Rosny Park PO Box 96 Rosny Park TAS, 7018

03 6217 9500 clarence@ccc.tas.gov.au ccc.tas.gov.au

# **Application for Development / Use or** Subdivision

Use this form to obtain planning approval for developing or using land, including subdividing it into smaller lots or lot consolidation.

7x12m Class 10a outbuilding for private storage

3 Starlight Drive, Cambridge, Tas, 7170

# **Personal Information Removed**

City of Clarence • 03 6217 9500 • ccc.tas.gov.au

Document Set ID: 5742363 Version: 1, Version Date: 10/11/2025



City of Clarence

38 Bligh St Rosny Park PO Box 96 Rosny Park TAS, 7018

03 6217 9500 clarence@ccc.tas.gov.au ccc.tas.gov.au

Is the property on the Tasmanian Heritage Register?	Yes □	No <b>≡</b>
If yes, we recommend you discuss your proposal with Heritage Tasmania presemptions may apply which may save you time on your proposal.	ior to lodgem	ent as
If you had pre-application discussions with City of Clarence, please provide	planner's na	me:
Current use of site: Dwelling		
Does the proposal involve land administered or owned by the Crown or Cou	ıncil? Yes □	No ■

#### **Declaration**

- I have read the Certificate of Title and Schedule of Easements for the land and am satisfied that this application is not prevented by any restrictions, easements or covenants.
- I authorise the provision of a copy of any documents relating to this application to any person for the purposes of assessment or public consultation. I agree to arrange for the permission of the copyright owner of any part of this application to be obtained. I have arranged permission for Council's representatives to enter the land to assess this application
- I declare that, in accordance with Section 52 of the Land Use Planning and Approvals Act 1993, that I have notified the owner of the intention to make this application. Where the subject property is owned or controlled by Council or the Crown, their signed consent is attached.
- I declare that the information in this declaration is true and correct.

#### Acknowledgement

I acknowledge that the documentation submitted in support of my application will become a
public record held by Council and may be reproduced by Council in both electronic and hard
copy format in order to facilitate the assessment process; for display purposes during public
consultation; and to fulfil its statutory obligations. I further acknowledge that following
determination of my application, Council will store documentation relating to my application
in electronic format only.

# **Personal Information Removed**

Please refer to the development/use and subdivision checklist on the following pages to determine what documentation must be submitted with your application.



City of Clarence • 03 6217 9500 • ccc.tas.gov.au

Document Set ID: 5742363 Version: 1, Version Date: 10/11/2025





# **Agent Authorisation**

Project Address:	3 STARLIGHT DR CAMBRIDGE TAS 7170
------------------	-----------------------------------

I/we

# **Personal Information Removed**

hereby appoint the following person/company representative

Agent Name:	TasTech Sheds (Ranbuild Hobart)	
Postal Address:	65 South Arm Road, Rokeby, 7019	
Phone Number:	(03) 6263 5800	
Email Address:	ranbuild@tastechsheds.com.au	


# **Personal Information Removed**

Document Set ID: 5742363 Version: 1, Version Date: 10/11/2025



# **RESULT OF SEARCH**

**RECORDER OF TITLES** 

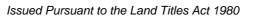



#### SEARCH OF TORRENS TITLE

VOLUME	FOLIO
153312	3
EDITION	DATE OF ISSUE
3	11-Oct-2025

SEARCH DATE : 06-Nov-2025 SEARCH TIME : 02.58 PM

### DESCRIPTION OF LAND

City of CLARENCE

Lot 3 on Sealed Plan 153312

Derivation: Part of 62A-0R-12Ps Located to William Stanley

Prior CT 124083/1

#### SCHEDULE 1

N280295 TRANSFER to LINDA VERA LAMPRECHT and CRAIG STEPHEN WRIGHT Registered 11-Oct-2025 at noon

#### SCHEDULE 2

Reservations and conditions in the Crown Grant if any SP153312 EASEMENTS in Schedule of Easements SP153312 COVENANTS in Schedule of Easements SP153312 FENCING COVENANT in Schedule of Easements

#### UNREGISTERED DEALINGS AND NOTATIONS

No unregistered dealings or other notations

Page 1 of 1




# **FOLIO PLAN**

**RECORDER OF TITLES** 



Issued Pursuant to the Land Titles Act 1980

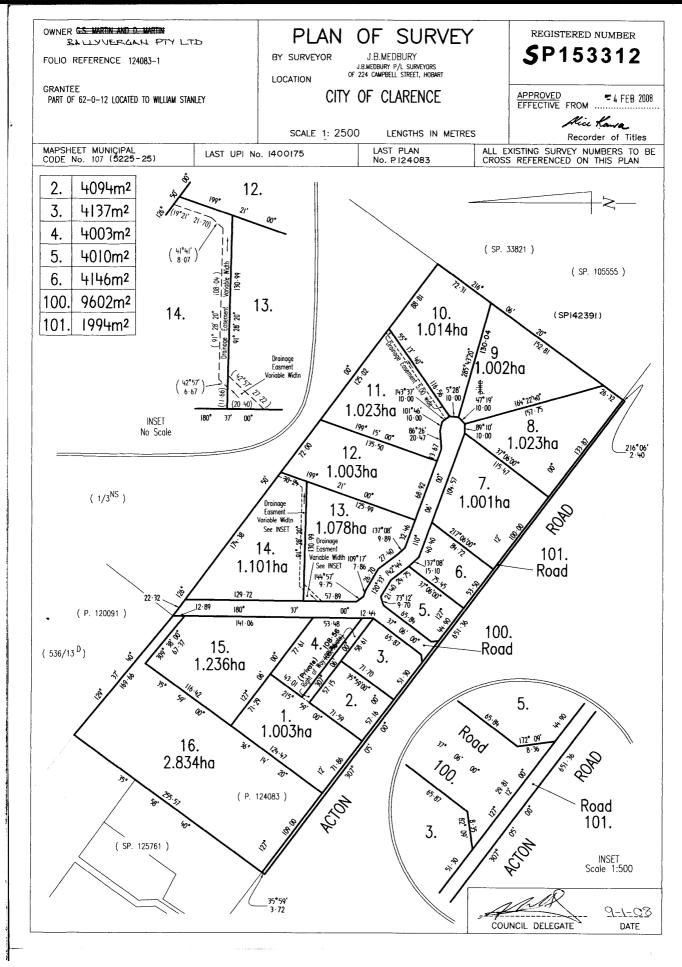

Search Date: 06 Nov 2025

Search Time: 02:58 PM

Volume Number: 153312

Revision Number: 01

Page 1 of 1



# SCHEDULE OF EASEMENTS

RECORDER OF TITLES

Issued Pursuant to the Land Titles Act 1980



SCHEDULE OF EASEMENTS

NOTE: THE SCHEDULE MUST BE SIGNED BY THE OWNERS

& MORTGAGEES OF THE LAND AFFECTED.

SIGNATURES MUST BE ATTESTED.

Registered Number

SP 153312

PAGE 1 OF 2 PAGE/S

#### **EASEMENTS AND PROFITS**

Each lot on the plan is together with:-

- (1) such rights of drainage over the drainage easements shown on the plan (if any) as may be necessary to drain the stormwater and other surplus water from such lot; and
- (2) any easements or profits a prendre described hereunder.

Each lot on the plan is subject to:-

- (1) such rights of drainage over the drainage easements shown on the plan (if any) as passing through such lot as may be necessary to drain the stormwater and other surplus water from any other lot on the plan; and
- (2) any easements or profits a prendre described hereunder.

The direction of the flow of water through the drainage easements shown on the plan is indicated by arrows.

Lot 1 is subject to a right of carriageway (appurtenant to lots 2, 3 & 4) over the land marked RIGHT OF WAY (PRIVATE) passing through that lot on the plan

Lot 2 is together with a right of carriageway over the land marked RIGHT OF WAY (PRIVATE) shown on the plan

Lot 3 is together with a right of carriageway over the land marked RIGHT OF WAY (PRIVATE) shown on the plan

Lot 4 is together with a right of carriageway over the land marked RIGHT OF WAY (PRIVATE) shown on the plan

#### Covenants

The owner of each lot on the plan covenants with Ballyvergan Pty Ltd and the owners for the time being of every other lot on the plan to the intent that the burden of this covenant may run with and bind the covenantors lot and every part thereof and that the benefit thereof may be annexed to and devolve with each and every part of every other lot on the plan to observe the following stipulations-

- 1. Not to place a mobile home, caravan or re-locatable home for use as a residence on such lot
- 2. Not to erect a dwelling with a floor area of less than 140 square metres on such lot

(USE ANNEXURE PAGES FOR CONTINUATION)

SUBDIVIDER: BALLYVERGAN P/L

DALLI VERGARIA

FOLIO REF: 124083/1

**SOLICITOR** 

& REFERENCE: IAN CREESE LAWYERS

PLAN SEALED BY: CLARENCE CITY COUNCIL

DATE: 9-1-2008

SD-2003/58 REF NO.

Council Delegate

NOTE: The Council Delegate must sign the Certificate for the purposes of identification.


Search Date: 06 Nov 2025 Search Time: 02:58 PM Volume Number: 153312 Revision Number: 01 Page 1 of 2

DoeparenteSeb1DkdiviA2362sources and Environment Tasmania Version: 1, Version Date: 10/11/2025



# **SCHEDULE OF EASEMENTS**

RECORDER OF TITLES

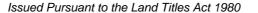





ANNEXURE TO SCHEDULE OF EASEMENTS

PAGE 2 OF 2 PAGES

Registered Number

SP 153312

SUBDIVIDER: BALLYVERGAN P/L FOLIO REFERENCE: 124083/1

- 3. Not to clad, finish or paint a dwelling in a colour or material that contrasts with the rural environment on such lot.
- 4. Not to park or garage a vehicle that exceeds 10 tonnes in weight on such lot
- 5. Not to conduct a business on such lot that creates noise contours that are audible beyond such lot

The owner lots 1 to 15 on the plan covenant with Ballyvergan Pty Ltd and the owners for the time being of every other lot on the plan to the intent that the burden of this covenant may run with and bind the covenantors lot and every part thereof and that the benefit thereof may be annexed to and devolve with each and every part of every other lot on the plan to observe the following stipulations-

1. Not to erect more than residential dwelling on such lot.

#### Fencing covenant

In respect to the lots on the plan the subdivider (Ballyvergan Pty Ltd) shall not be required to fence

Executed BALLYVERGAN PTY LTD being the registered) proprietor in folio of the Register volume 124083 folio 1 under section 127 of the Corporations Act 2001 by being signed by two directors-

.......

idia Hookun

**NOTE:** Every annexed page must be signed by the parties to the dealing or where the party is a corporate body be signed by the persons who have attested the affixing of the seal of that body to the dealing.

Search Date: 06 Nov 2025 Search Time: 02:58 PM Volume Number: 153312 Revision Number: 01

Page 2 of 2

CONSTRUCTION TO COMPLY WITH THE BUILDING CODE OF AUSTRALIA AND AUSTRALIAN STANDARDS WHERE APPLICABLE

DO NOT SCALE OFF PLAN

BUILDER TO CHECK ALL DIMENSIONS ON SITE BEFORE STARTING WORKS

PLEASE REPORT ANY ERRORS OR INCONSISTENCIES TO TASTECH

ANY CHANGES TO THIS DOCUMENT TO BE CONFIRMED BY TASTECH BUILDING SYSTEMS

Proposed 7.0m x 12.0m x 3.2m (spouting) Colorbond Shale Grey (roof) & Woodland Grey (walls) Class 10a freestanding outbuilding built from noncombustible materials.

No vehicular access required, outbuilding lis for private storage.

#### Positioning:

A - 10.0m

B - 15.0m

C - 8.7m

Stormwater to new 3000L slimline rainwater tank.

SEE RANBUILD DRAWINGS AND SPECIFICATIONS FOR FULL DETAILS.

Acton Road

#### DESCRIPTION OF LAND

City of CLARENCE

Lot 3 on Sealed Plan 153312

Derivation: Part of 62A-0R-12Ps Located to William Stanley



ADDRESS:

3 Starlight Drive, Cambridge, Tas, 7170

**DRAWING NUMBER:** RB1186\_SITE

PROJECT TITLE:

Wright Shed

JOB NUMBER: **RB1186** 

CLIENT: Craig Wright &

Linda Lamprecht

DATE: 18/11/2025 - REV1

SCALE: NTS DRAWN: HM





65 SOUTH ARM ROAD ROKEBY, TAS, 7019

(03) 6263 5800

ranbuild@tastechsheds.com.au



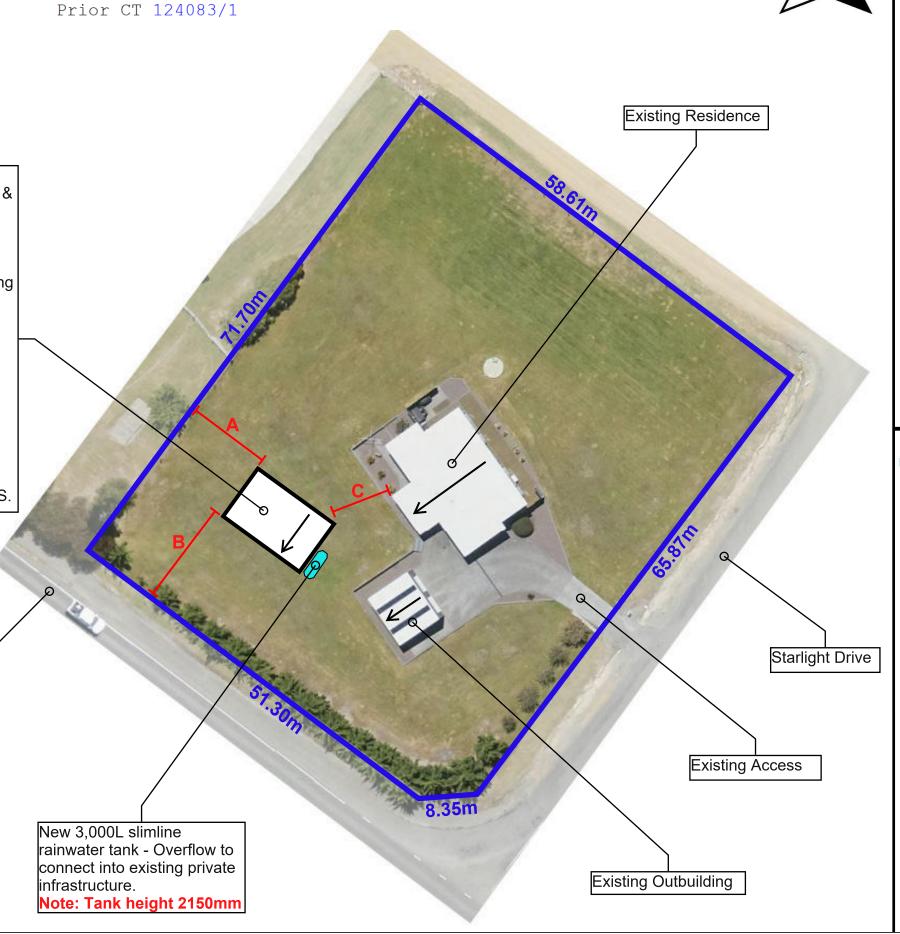

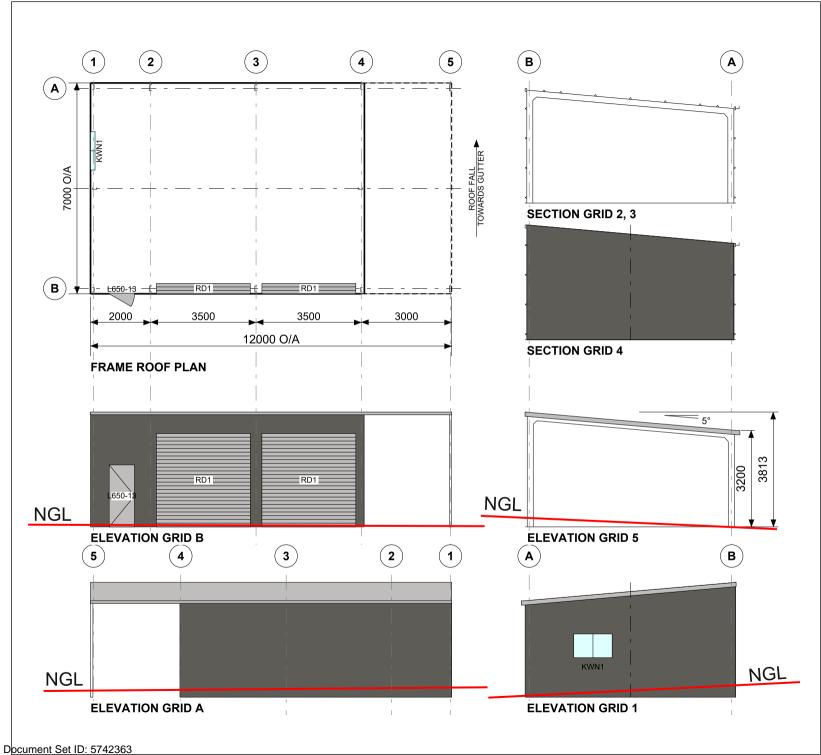



CLADDING				
ITEM	PROFILE (min)	FINISH	COLOUR	
ROOF	TRIMDEK 0.42 BMT	СВ	SH	
WALLS	CUSTOM ORB 0.42 BMT	СВ	WG	
CORNERS	-	СВ	WG	
BARGE	-	СВ	SH	
GUTTER	HI-QUAD	СВ	SH	

0.35bmt=0.40tct; 0.42bmt=0.47tct; 0.48bmt=0.53tct

	00500	CODY COLIEDUI E 8 LECEND			
A	ACCESSORY SCHEDULE & LEGEND				
QTY	MARK	DESCRIPTION			
2	RD1	Taurean, Domestic PR1ME Series A 3025 high x 3120 wide Clear Opening C/B			
1	L650-13	Larnec Door & Frame Kit, 650/37, Std. 2040 x 820 C/ Bond			
1	KWN1	AMI - Reg A & B, 790x1274 CLR, Window Kit (BDSP)			

ARCHITECTURAL DRAWING ONLY, NOT FOR CONSTRUCTION USE

CLIENT **Craig Wright** 

3 Starlight Drive **CAMBRIDGE TAS 7170** 

BUILDING

**DELUXE SKILLION** 7000 SPAN x 3200/3813 EAVE x 12000 LONG

**FLOOR PLAN & ELEVATION** 

SCALE DRAWING NUMBER A4 SHEET 1:125 BRWT4-7660

REV PAGE Α 1/1

Version: 1, Version Date: 10/11/2025

# CERTIFICATE OF THE RESPONSIBLE DESIGNER

Section 94

Section 106 Section 129

Section 155

To:	Craig Wright			Owner name		
	3 Starlight Drive		Address		Form <b>35</b>	
	CAMBRIDGE TAS		7170	Suburb/postcode		TOIIII •
Designer detail	ls:					
Name:	ALEXANDER FILONOV			Category:		ngineer Civil, lilding Designer
Business name:	LYSAGHT BUILDING SOLUTION	ON	S	Phone No:	02	4962 4311
Business address:	PO Box 170					
	HAMILTON NSW		2303	Fax No:	02	4962 3421
Licence No:	CC 4719P Email address:	а	lexander.f	ilonov@blue	SCC	pesteel.com
Details of the p	roposed work:					
				signer's proje erence No. Lot N	lo:	440814
Type of work:	Building work 🗹		Plun	nbing work	(	X all applicable)
Description of work	k:			(now huilding	/ 0!	toration / addition /
New building				repair / remov water / sewer on-site waste	ral / age vate	teration / addition / re-erection / stormwater / er management v prevention / other)

 $\textbf{Description of the Design Work (Scope, limitations or exclusions):} \ \textit{(X all applicable certificates)}$ 

Certificate Type:	Certificate		Responsible Practitioner		
	V	Building design	Architect or Building Designer		
	V	Structural design	Engineer or Civil Designer		
		Fire Safety design	Fire Engineer		
		Civil design	Civil Engineer or Civil Designer		
		Hydraulic design	Building Services Designer		
		Fire service design	Building Services Designer		
		Electrical design	Building Services Designer		
		Mechanical design	Building Service Designer		
		Plumbing design	Plumber-Certifier; Architect, Building Designer or Engineer		
		Other (specify)			
Deemed-to-Satisfy:	V		Performance Solution: (X the appropriate box)		
Other details: Structural design	of Ste	eel frame Reinforce	ed Concrete Footings for new building		

Design documents provid	ed:	
The following documents are provide Document description:	ded with this Certificate –	
Drawing numbers:	Prepared by: Ranbuild RDS	Date: 5/11/2025
Additional Form 35 is require	nis Form 35 are issued for engi	Building Designer to address all
Attachment 1:	Prepared by: Ranbuild	Date: 5/11/2025
440814 ENG REV B		
Schedules:	Prepared by:	Date:
Specifications:	Prepared by:	Date:
Importance Level: 2 Building Class: 10a		
Computations:	Prepared by:	Date:
Performance solution proposals:	Prepared by:	Date:

Prepared by:

Date:


Test reports:

Standards, codes or guidelines relied on in design process:				
BCA PLUS Architectural elevations and plan ONLY Alexander Filonov has not been engaged to undertake any geotechnical condition to determine site classification and any inspections of the work to ensure the drawings and specifications with this certificate are complied with.				
Any other relevant documentation:				
Attribution as designer:				
I ALEXANDER FILONOV am responsible for the design of that part of the	e work as described in this certificate;			
The documentation relating to the design includes sufficient information for the assessment of the work in accordance with the <i>Building Act 2016</i> and sufficient detail for the builder or plumber to carry out the work in accordance with the documents and the Act:				

This certificate confirms compliance and is evidence of suitability of this design with the requirements of the National Construction Code.

Name: (print) Date 5/11/2025 Designer: ALEXANDER FILONOV CC 4719P Licence No:

Assessme	nt of Certifiable Works: (Ta	sWater)				
not conside	Note: single residential dwellings and outbuildings on a lot with an existing sewer connection are not considered to increase demand and are not certifiable.  If you cannot check ALL of these boxes, LEAVE THIS SECTION BLANK.					
_				e Works.		
	TasWater must then be contacted to determine if the proposed works are Certifiable Works.  I confirm that the proposed works are not Certifiable Works, in accordance with the Guidelines for TasWater CCW Assessments, by virtue that all of the following are satisfied:					
☐ The wo	orks will not increase the demand fo	or water supplied by TasV	Vater			
	orks will not increase or decrease the rged into, TasWater's sewerage infr		toxins that is to be r	emoved by, or		
	orks will not require a new connection ter's infrastructure	on, or a modification to a	an existing connection	on, to be made to		
☐ The wo	orks will not damage or interfere witl	h TasWater's works				
☐ The wo	orks will not adversely affect TasWa	ter's operations				
☐ The wo	ork are not within 2m of TasWater's	infrastructure and are ou	ıtside any TasWater	easement		
☐ I have	☐ I have checked the LISTMap to confirm the location of TasWater infrastructure					
	☐ If the property is connected to TasWater's water system, a water meter is in place, or has been applied for to TasWater.					
Certification	on:					
I ALEXANDER FILONOV being responsible for the proposed work, am satisfied that the works described above are not Certifiable Works, as defined within the <i>Water and Sewerage Industry Act 2008</i> , that I have answered the above questions with all due diligence and have read and understood the Guidelines for TasWater CCW Assessments.						
Note: the Guidelines for TasWater Certification of Certifiable Works Assessments are available at: www.taswater.com.au						
	Name: (print)	Signe	d	Date		
Designer:	ALEXANDER FILONOV	Discoa		5/11/2025		

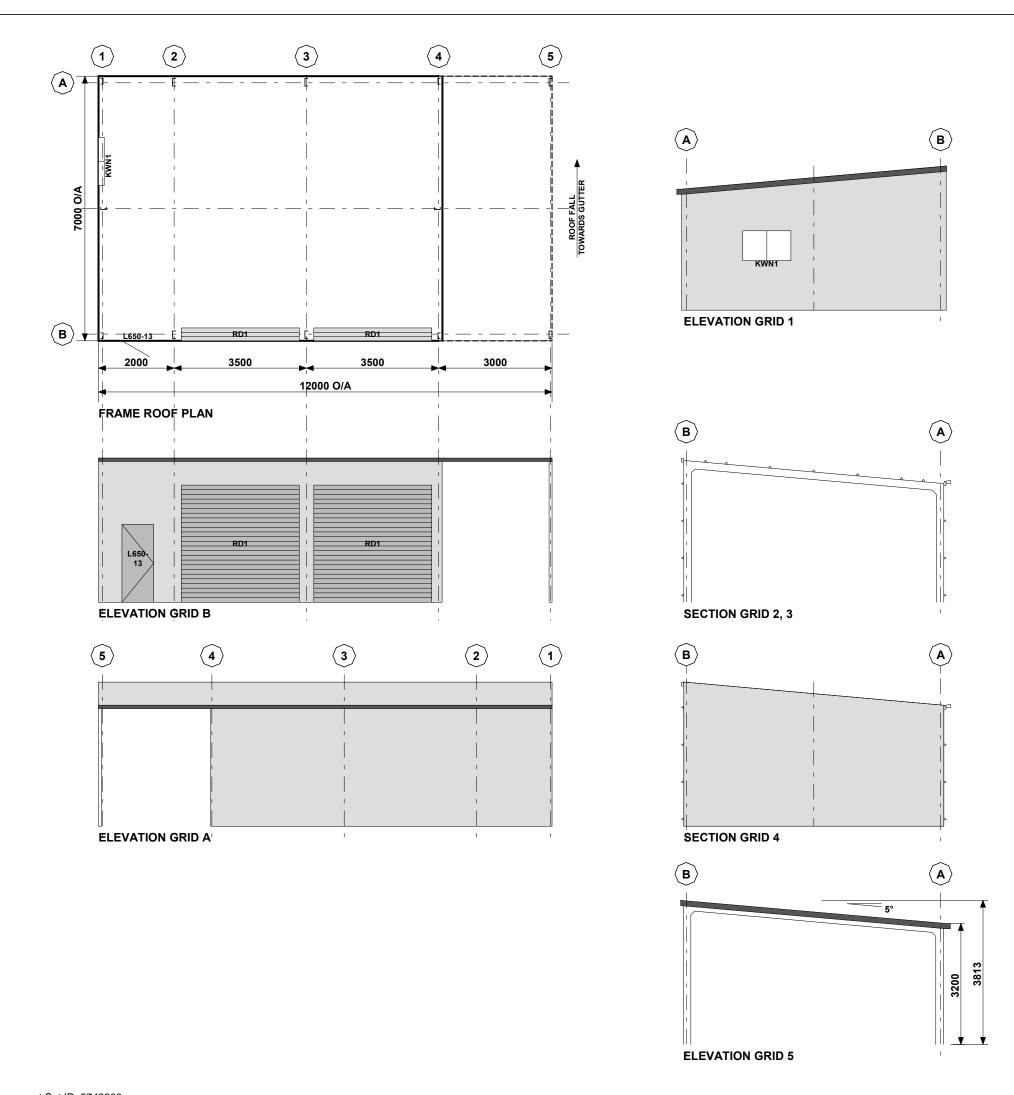



CLADDING					
ITEM	PROFILE (min)	FINISH	COLOUR		
ROOF	TRIMDEK 0.42 BMT	СВ	SH		
WALLS	CUSTOM ORB 0.42 BMT	СВ	WG		
CORNERS	-	СВ	WG		
BARGE	-	СВ	SH		
GUTTER	HI-QUAD	СВ	SH		

#### 0.35bmt=0.40tct; 0.42bmt=0.47tct; 0.48bmt=0.53tct

ACCESSORY SCHEDULE & LEGEND					
QTY	MARK	DESCRIPTION			
2	RD1	Taurean, Domestic PR1ME Series A 3025 high x 3120 wide Clear Opening C/B			
1	L650-13	Larnec Door & Frame Kit, 650/37, Std. 2040 x 820 C/Bond			
1	KWN1	AMI - Reg A & B, 790x1274 CLR, Window Kit (BDSP)			

Accredited Practitioner
Alexander Filonov
CC4719P
LEVEL 1, 12 BEAUMONT ST
HAMILTON NSW 2303

05/11/2025

ARCHITECTURAL DRAWING ONLY, FOR BUILDING PERMIT STAGE

CLIENT

Craig Wright

+61 2 4962 4311

ITE

3 Starlight Drive CAMBRIDGE TAS 7170

BUILDING

DELUXE SKILLION 7000 SPAN x 3200/3813 EAVE x 12000 LONG

TITLE

GENERAL ARRANGEMENT

SCALE DRAWING A3 SHEET 1:100 440814.

DRAWING NUMBER REV PAGE 440814-GA B 1/7

STRUC	TURAL STEELWORK SCHE	DULE	CONNE	CTIONS	
MARK	DESCRIPTION	SECTION	BASE	EAVES	TOP
C1	COLUMN - UNCLAD FRAME	C20015	BC4	KN3, KN7	
C2	COLUMN - CLAD FRAME	C15010	ВС3	KN1, KN5	
C3	COLUMN - END	C15015	EB1		ER1
R1	RAFTER - UNCLAD FRAME	C20015		KN3	KN7
R2	RAFTER - CLAD FRAME	C15012	RA2	KN1	KN5
DM1	MULLION - ROLLER DOOR	C15010	EB1	DM1	MC4
RH1	HEAD - ROLLER DOOR	TS6175 + TS6175	RH1		
OM1	OPENING MULLION	63x35x1.0 C-Channel			
OH1	OPENING HEAD	63x35x1.0 C-Channel			
Bw	BRACING - SIDE WALL	DIAPHRAGM			
Ве	BRACING - END WALL	DIAPHRAGM			
Br	BRACING - ROOF	DIAPHRAGM			
LB1	BRACE - LATERAL FLY	95 x 0.6 STRAP	LB1		
F1	FASCIA	C10010	FS2		
P1	PURLINS	TS6175 @ 1250	BL1		
G1	GIRTS - SIDE	TS6175 @ 1380	BL1		
G2	GIRTS - END	TS6160 @ 1380	BL1		

#### **GENERAL**

- THIS IS A STANDARDISED DESIGN SUITABLE FOR LIGHT INDUSTRIAL, COMMERCIAL & RURAL BUILDINGS TO STANDARDS & REQUIREMENTS PROVIDED BY RANBUILD
- THESE DRAWINGS SHALL BE READ IN CONJUNCTION WITH RANBUILD ASSEMBLY GUIDE.
- ANY DISCREPANCY SHALL BE REFERED TO THE ENGINEER BEFORE
- PROCEEDING WITH WORK.

   ALL MATERIALS & WORKMANSHIP SHALL BE IN ACCORDANCE WITH RELEVANT & CURRENT SAA CODES & WITH BY-LAWS & ORDINANCES OF THE RELEVANT BUILDING AUTHORITIES EXCEPT WHERE VARIED BY THE PROJECT
- SPECIFICATION.

  ALL DIMENSIONS SHOWN SHOULD BE VERIFIED BY THE BUILDER ON SITE.
- ENGINEERS DRAWINGS SHALL NOT BE SCALED FOR DIMENSIONS.

  DURING CONSTRUCTION THE STRUCTURE SHALL BE MAINTAINED IN A STABLE CONDITION & NO PART SHALL BE OVERSTRESSED. TEMPORARY BRACING SHALL BE PROVIDED BY THE BUILDER TO KEEP THE WORKS & EXCAVATIONS STABLE AT ALL TIMES.
- UNLESS NOTED OTHERWISE ALL LEVELS ARE IN METRES & ALL DIMENSIONS ARE IN MILLIMETRES.
- THE STRUCTURAL COMPONENTS DETAILED ON THESE DRAWINGS HAVE BEEN DESIGNED IN ACCORDANCE WITH THE RELEVANT SAA CODES & NORMAL ENGINEERING PRACTICE.

  • ARCHITECTURAL ELEMENTS TO HAVE A MINIMUM OF 20mm CLEARANCE OF
- THE STRUCTURE & ARE TO BE ARTICULATED.

  IT IS COMMON SENSE TO WORK SAFELY AND TO PROTECT YOURSELF AND OTHERS FROM ACCIDENTS ON SITE. TO DO THIS, YOU MUST ENSURE YOU HAVE IN PLACE SAFE WORK PRACTICES AND APPROPRIATE EQUIPMENT. SAFETY INVOLVES PERSONAL PROTECTION OF EYES, OF SKIN(FROM SUNBURN) AND OF HEARING(FROM NOISE). FALL PROTECTION MUST ALSO BE IN PLACE AS APPLICABLE INCLUDING SAFETY MESH, PERSONAL HARNESSES AND PERIMETER GUARDRAILS. IT IS RECOMMENDED THAT YOU FAMILIARIZE YOURSELF WITH APPLICABLE LAWS, REGULATIONS, RULES, GUIDELINES, CODES OF PRACTICE AND STANDARDS AND THAT YOU ADHERE STRICTLY TO

#### STRUCTURAL STEEL SPECIFICATION

- ALL STRUCTURAL STEELWORK TO BE CARRIED OUT IN ACCORDANCE WITH THE LATEST EDITIONS OF THE FOLLOWING SAA CODES & SPECIFICATIONS. AS4100 STEEL STRUCTURES CODE AS/NZS 4600 COLD FORMED STEEL STRUCTURES CODE. AS1111 COMMERCIAL BOLTS & SCREWS. AS2887 FARM STRUCTURES (WHERE APPLICABLE).
- PROPRIETARY PRODUCTS ARE TO BE IN ACCORDANCE WITH THE RESPECTIVE
- MANUFACTURERS INSTRUCTIONS.

#### FRAME ASSEMBLY

- CORRECT FRAME ASSEMBLY IS IMPORTANT TO ACHIEVE OPTIMUM PERFORMANCE OF
- FULLY TENSION BOLTS AT KNEE & APEX JOINTS AS SPECIFIED BEFORE STANDING
- FULLY TENSION BOLTS AT BASE CONNECTIONS AS SPECIFIED IMMEDIATELY AFTER STANDING THE FRAME.
- ROOF & WALL BRACING PROVIDE STRUCTURAL STABILITY WHERE SPECIFIED & MUST BE INSTALLED BEFORE THE CLADDING

#### **SELF DRILLING SCREWS**

- QUALITY AND MECHANICAL PROPERTIES OF STRUCTURAL SCREWS MUST COMPLY WITH AS3566.1.
- ALL TEK SCREWS SHALL BE NO. 12 14 X 20 U.N.O
   THE MINIMUM DISTANCE OF EDGE/END SCREWS MUST HAVE AN
- EDGE DISTANCE OF 1.5 X SCREW DIAMETER FROM THE EDGE.

  THE MINIMUM DISTANCE OF SCREW TO SCREW SPACING MUST
- NOT BE LESS THAN 3 X SCREW DIAMETER BETWEEN ANY SCREWS.

#### **HIGH TENSILE BOLTS**

- ALL BOLTS SHALL BE M16 / 8.8 / S U.N.O
- CONNECTIONS WITH 8.8S BOLTS SPECIFIED ARE DESIGNED AS FRICTION TYPE JOINTS & BOLTS, NUTS & WASHERS SHALL COMPLY WITH THE RELEVANT REQUIREMENTS OF AS1252.

  8.8/S BOLTS TO BE INSTALLED IN ACCORDANCE WITH
- AS4100 & TENSIONED BY AN APPROVED METHOD TO PRODUCE THE FOLLOWING SHANK TENSIONS

BOLT SIZE SHANK TENSION (kN)

• FOR THIS DESIGN AN ACCEPTABLE TENSIONING METHOD IS SNUG TIGHT (PODGER SPANNER TIGHT) PLUS HALF A TURN.

#### CLADDING

- ALL ROOF AND WALL CLADDING TO BE INSTALLED IN ACCORDANCE WITH AS1562.1 AND THE MANUFACTURER'S INSTRUCTIONS
- ROOF AND WALL CLADDING ARE STRUCTURAL DIAPHRAGM BRACINGS, UNDER NO CIRCUMSTANCES SHOULD THE CLADDING BE REMOVED WITHOUT WRITTEN APPROVAL FROM A PRACTICING STRUCTURAL ENGINEER.

#### **DESIGN LOADING**

• THE STRUCTURAL COMPONENTS SHOWN ON THESE DRAWINGS HAVE BEEN DESIGNED FOR THE FOLLOWING LOAD CONDITIONS COMPLYING WITH RELEVANT AUSTRALIAN STANDARDS INCLUDING AS/NZS 1170.2:2021:-ROOF DEAD LOAD SELE WEIGHT ONLY

(1.8/A+0.12) BUT NOT LESS THAN 0.25kPa AND 1.1kN WIND LOAD REGION TERRAIN CATEGORY INTERNAL PRESSURE Cpi = -0.65 or +0.7 (OPEN) COEFFICIENTS SITE CLASS M (CLAY) GROUND SNOW LOAD Sg COASTAL DISTANCE

• ALL DOORS AND WINDOWS SHALL HAVE THE SAME CYCLONIC WIND LOAD RATING AS THE REST OF THE BUILDING ENVELOPE, INCLUDING RESISTANCE TO FLYING DEBRIS AS SPECIFIED IN AS1170.2:2021 AND AS/NZS 4505-2012. DOORS AND WINDOWS SHALL BE CLOSED DURING STORMS. DOORS SHALL BE INSTALLED WITH WIND LOCKS IN CYCLONIC AREAS. SUPPORTING DOCUMENTATION INCLUDING TEST REPORTS SHALL BE AVAILABLE FROM DOORS AND WINDOWS MANUFACTURERS TO CONFIRM LOAD RATING AND ENSURE COMPLIANCE WITH ABOVE MENTIONED STANDARDS AND BCA. DOORS ARE ALSO REQUIRED TO BE SUPPLIED WITH A STICKER THAT SHOWS A RANGE OF INFORMATION INCLUDING THE DESIGN PRESSURE OF THE DOOR ACCORDING TO AS/NZS 4505-2012 REQUIREMENTS.

#### **COPYRIGHT NOTE**

• THIS DRAWING REMAINS THE INTELLECTUAL PROPERTY OF RANBUILD, AND MUST NOT BE REPRODUCED, COPIED OR MODIFIED WHOLLY OR IN PART WITHOUT THE WRITTEN PERMISSION OF LYSAGHT BUILDING SOLUTIONS PTY LTD trading as RANBUILD



Copyright 2025 Lysaght Building Solutions Pty Ltd trading as RANBUILD

#### DRAWING SCHEDULE

- 1: 440814-GA GENERAL ARRANGEMENT
- 2: ENG1/1-440814 STEEL FRAME SCHEDULE AND NOTES.
- 3: ENG2/1-440814 STEEL FRAME DIAGRAMS
- 4: ENG3/1-440814 CONNECTION DETAILS
- 5. ENG4/1-440814 RC SLAB PLAN
- 6: FNG5/1-440814 CHEMSET DETAILS
- 7: ENG6/1-440814 CONCRETE SPECIFICATION, SITE

Accredited Practitioner

Alexander Filonov CC4719P

**LEVEL 1, 12 BEAUMONT ST** 

**HAMILTON NSW 2303** 

+61 2 4962 4311

05/11/2025

FOR BUILDING PERMIT STAGE

CLIENT

**Craig Wright** 

3 Starlight Drive **CAMBRIDGE TAS 7170** 

BUILDING

**DELUXE SKILLION** 7000 SPAN x 3200/3813 EAVE x 12000 LONG

STEEL FRAME SCHEDULE AND NOTES, **COVER PAGE** 

DRAWING NUMBER ENG1/1-440814

REV В


2/7


Document Set ID: 5742363


Version: 1. Version Date: 10/11/2025






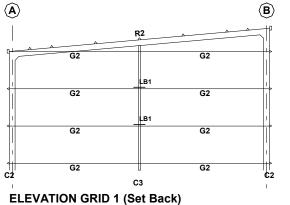

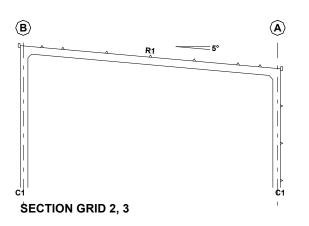

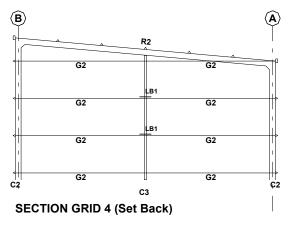

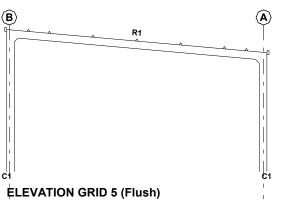

Accredited Practitioner Alexander Filonov CC4719P LEVEL 1, 12 BEAUMONT ST HAMILTON NSW 2303 +61 2 4962 4311

FOR BUILDING PERMIT STAGE

05/11/2025

CLIENT Craig Wright 3 Starlight Drive CAMBRIDGE TAS 7170

DELUXE SKILLION 7000 SPAN x 3200/3813 EAVE x 12000 LONG

STEEL FRAME DIAGRAMS

SCALE A3 SHEET 1:100 DRAWING NUMBER REV ENG2/1-440814 В

PAGE 3/7

1

**R**2

(A) →

**B** <u>▼</u>

2

1910

P1

FRAME ROOF PLAN

G1

2 @ G1 OH1

c2 C1
ELEVATION GRID B

**ELEVATION GRID A** 

**(5)** 

3

3500

G1 RH1

3

G1

**2** 

<u>L</u>B1 G1

G1

G1

G1

G1

G1

1

3500


G1 RH1

4

4

**(5)** 

Σ

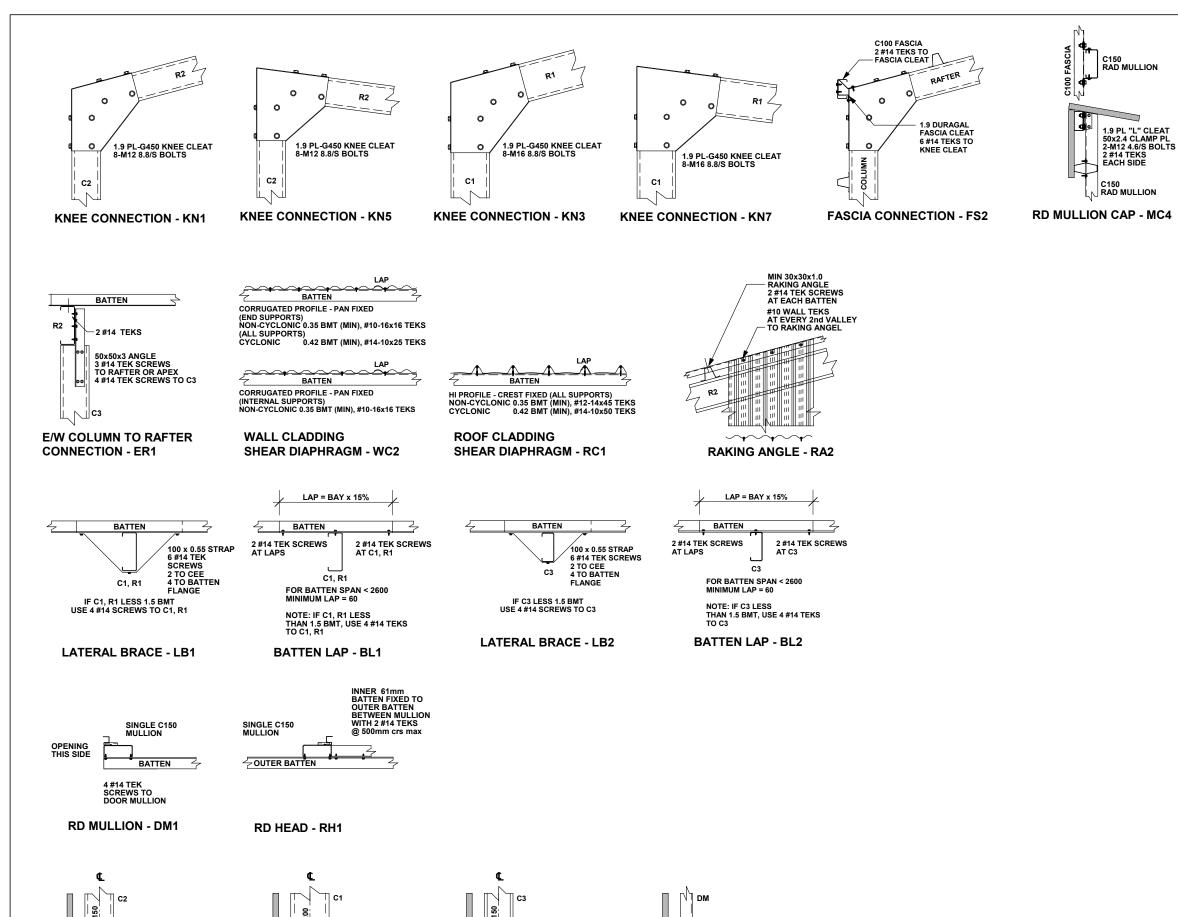

3mm L-CLEAT 6 #14 TEK SCREWS 2-D12 x 55 DYNABOLTS

E/W COLUMN BASE - EB1

3mm L-CLEAT 6 #14 TEK SCREWS 2-D12 x 55 DYNABOLTS

**RD MULLION BASE - EB2** 

Accredited Practitioner
Alexander Filonov

LEVEL 1, 12 BEAUMONT ST HAMILTON NSW 2303 +61 2 4962 4311

FOR BUILDING PERMIT STAGE

CLIENT

Craig Wright

TE

05/11/2025

3 Starlight Drive CAMBRIDGE TAS 7170

BUILDING

DELUXE SKILLION 7000 SPAN x 3200/3813 EAVE x 12000 LONG

TITLE

CONNECTION DETAILS

SCALE DRAWING NUMBER ENG3/1-440814

UMBER REV 440814 B

4/7

Copyright 2025

Lysaght Building

Solutions Pty Ltd

trading as RANBUILD

(RANBUILD)

5mm-300MPa U-CLEAT

4-M16 8.8/S BOLTS 61mm EDGE OFFSET 2-M16 CHEMSETS


**BASE CONNECTION - BC3** 

1-300MPa U-CLEAT

4-M16 8.8/S BOLTS 61mm EDGE OFFSET 2-M20 CHEMSETS

**BASE CONNECTION - BC4** 



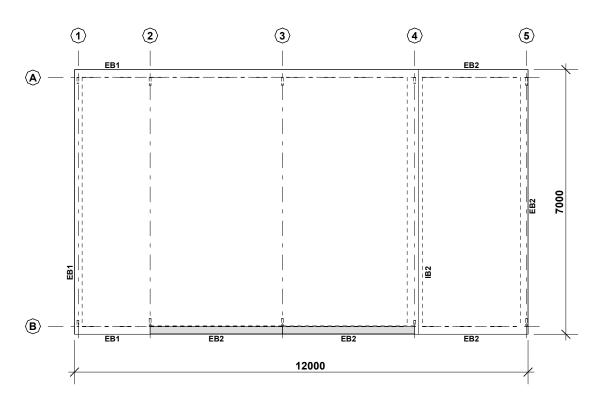

#### **RC SLAB**

THIS GENERAL PURPOSE RC FLOOR DESIGN IS SUITABLE FOR STRUCTURES USED FOR DOMESTIC, FARM AND COMMERCIAL NON-HABITABLE BUILDINGS SUCH AS GARAGES, STORAGE SHEDS, BARNS, STABLES ETC. THE DESIGN IS NOT SUITABLE FOR STRUCTURES CONVERTED FOR USE AS A DWELLING.
ALL DIMENSIONS SHOULD BE CHECKED AND VERIFIED PRIOR TO COMMENCEMENT OF ANY WORKS.
IF SLIDING DOORS ARE INCLUDED ON THIS PROJECT, A STRIP FOOTING OR PAD FOOTINGS WILL BE NECESSARY, AND MUST BE POURED IN CONJUNCTION WITH THIS GARAGE'S SLAB OR FOOTINGS.

SEE ERECTION INSTRUCTIONS FOR ADDITIONAL NOTES.

#### **REFERENCE**

**SEE SLAB DETAIL DRAWING FOR:-**

- SITE FOUNDATION CLASSIFICATION NOTES
- MINIMUM SITE PREPARATION NOTES
- CONCRETE SPECIFICATION NOTES
- CONCRETE REINFORCEMENT NOTES
- SLAB ON GRADE NOTES
- DETAIL S1/EB1 SLAB EDGE TYPE 1
- DETAIL S1/EB2 SLAB EDGE TYPE 2
- DETAIL S1/IB1 INTERNAL BEAM TYPE 1
   DETAIL S1/IB2 INTERNAL BEAM TYPE 2
- DETAIL S1/A
   SLAB CONTROL JOINT
- DETAIL S1/C SLAB CONSTRUCTION JOINT

Accredited Practitioner

Alexander Filonov

CC4719P

LEVEL 1, 12 BEAUMONT ST

HAMILTON NSW 2303 +61 2 4962 4311

05/11/2025

FOR BUILDING PERMIT STAGE

CLIENT

Craig Wright

ITE

3 Starlight Drive CAMBRIDGE TAS 7170

BUILDING

DELUXE SKILLION 7000 SPAN x 3200/3813 EAVE x 12000 LONG

TITI F


**RC SLAB PLAN** 


SCALE DRAWING NUMBER
A3 SHEET 1:100 ENG4/1-440814


REV PAGE B 5/7

# CHEMICAL ANCHOR INSTALLATION (CHEMSET)

#### Installation

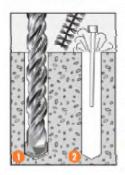

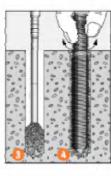

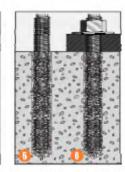

#### Installation temperature limits:


- Substrate: 5°C to 40°C.
- Adhesive: 20°C to 32°C.

Load should not be applied to anchor until the chemical has sufficiently cured as specified.

#### Service temperature limits:

-10°C to 80°C.

## **Setting Times**

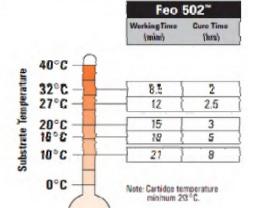

 Allow ChemSet™ Reo 502™ to cure as per setting times. 6. Attach fixture.

4. Insert Ramset" ChemSet" Anchor Stub/rebar to

1. Drill recommended diameter and depth hale. 2. Clean hole with hole cleaning brush.


Remove all debris using hole blower. 3. Insert mixing nozzle to bottom of hole.

Fill hole to 3/4 the hole depth slowly.

ensuring no air pockets form.

bottom of hole white turning.


# REF: RAMSET SPECIFIERS RESOURCE BOOK 2009 EDITION

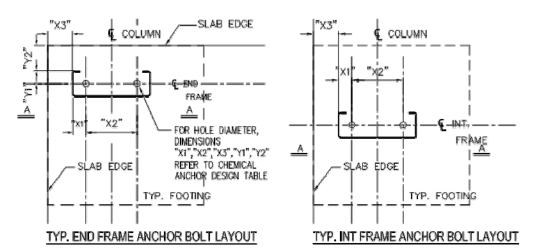

GRID No.	GIRT TYPE	DISTANCE "X3"	DISTANCE "Y2"
1	TS61	61mm	83mm
3, B, C	TS61	61mm	61mm

COLUMN SIZE	HOLE	MIN ANCHOR					DISTANCE	STATE DESIG	
	DIAMETER	EMBEDMENT	SIZE	TORQUE	"X1"	"X2"	"Y1"	TENSION Ø Nur	SHEAR ØVur
C200	24mm	150mm	M20 - 260mm	180Nm	36mm	130mm	38mm	64.5KN	18.5KN

NOTE:
ANCHOR DESIGN CAPACITIES ARE STRICTLY BASED UPON THE ANCHOR SIZES, EMBEDMENT LENGTHS, TORQUE REQUIREMENTS,
GEOMETRICAL DIMENSIONS PRESENTED IN THIS DRAWING AND 28 DAYS CONCRETE COMPRESSIVE STRENGTH OF 25Mpa ONLY.
NO ALTERATION IS ALLOWED WITHOUT OFFICAL WRITTEN CONFIRMATION FROM BLUESCOPE LYSAGHT TECHNOLOGY.

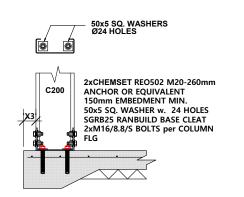

Accredited Practitioner

(RANBUILD

Alexander Filonov

CC4719P

LEVEL 1, 12 BEAUMONT ST HAMILTON NSW 2303

+61 2 4962 4311

05/11/2025

FOR BUILDING PERMIT STAGE

Craig Wright

3 Starlight Drive **CAMBRIDGE TAS 7170** 

**DELUXE SKILLION** 7000 SPAN x 3200/3813 EAVE x 12000 LONG


**CHEMSET DETAILS** 

DRAWING NUMBER ENG5/1-440814

Copyright 2025 Lysaght Building


Solutions Pty Ltd

trading as RANBUILD

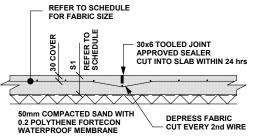


#### S1/Δ

CONTROL JOINTS MUST BE SUPPLIED AT NOT GREATER THAN 4.5M OR CONCRETE POUR AT A RATIO OF NOT MORE THAN 1:1.2 IN ANY DIRECTION.

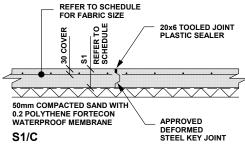


CONSTRUCTION JOINTS MUST BE SUPPLIED WHERE AN UNBROKEN RUN OF CONCRETE POUR EXCEEDS 30M IN ANY DIRECTION.

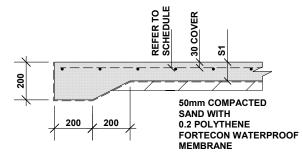


#### **DET S1/EB1 FOR RC SLAB**

NOT SUITABLE AT OPENINGS SUBJECT TO VEHICLE TRAFFIC

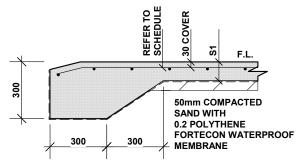

#### DET S1/EB2

REQUIRED AT OPENINGS SUBJECT TO VEHICLE TRAFFIC

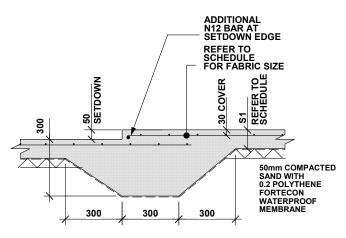

DET S1/IB2

#### SITE FOUNDATION CLASSIFICATION

TWO COMMON FOUNDATION CONDITIONS & SITE CLASSIFICATIONS IN ACCORDANCE WITH ASSET ARE USED FOR THE STANDARDISED FOOTING DESIGNS AS EQUI OWS:

- DESIGNS AS FOLLOWS:• STIFF CLAY CONFORMING TO AS2870 CLASS M.
  MINIMUM SAFE BEARING CAPACITY 100 kPa.
  SHAFT ADHESION 20 kPa
- DENSE SAND CONFORMING TO AS2870 CLASS A/S.
   MINIMUM SAFE BEARING CAPACITY 100 kPa.
- A SITE SPECIFIC GEOTECHNICAL INVESTIGATION IS RECOMMENDED & IF CONDITIONS OTHER THAN ASSUMED ARE ENCOUNTERED A DIFFERENT FOOTING DESIGN MAY BE REQUIRED & SHOULD BE REFERED TO A QUALIFIED LOCAL ENGINEER
- ALL FOOTINGS TO BE FOUNDED IN NATURAL GROUND.
- NO FOOTING TO BE FOUNDED ON FILL MATERIAL.
- REFERENCE SHOULD BE MADE TO CSIRO PUBLICATION 10.91 GUIDE TO HOME OWNERS ON FOUNDATION MAINTENANCE & FOOTING PERFORMANCE

#### MINIMUM SITE PREPARATION

- STRIP SITE OF ALL TOP SOIL & DISCARD TO SPOIL. THE EXPOSED SURFACE TO BE PROOF ROLLED & AREAS REMAINING SOFT OR SPONGY ARE TO BE EXCAVATED TO SPOIL.
- PLACE APPROVED GRANULAR FILL MATERIAL TO THE REQUIRED BUILDING PLATFORM LEVEL IN LAYERS NOT EXCEEDING 200mm AND COMPACT BY ROLLING WITH SUITABLE EQUIPMENT TO ACHIEVE A DRY DENSITY RATIO OF 98% STANDARD COMPACTION TO AS1289 E1.1 AT OPTIMUM MOISTURE CONTENT. THE TOP 200mm TO BE COMPACTED TO 100% STANDARD DRY DENSITY
- THE COMPACTION OF ALL FILL MATERIAL TO BE INSPECTED AND APPROVED BY A RESPONSIBLE GEOTECHNICAL CONSULTANT.

#### CONCRETE REINFORCEMENT

- REINFORCEMENT IS REPRESENTED DIAGRAMATICALLY & NOT NECESSARILY IN TRUE PROJECTION.
- REINFORCEMENT NOTATION:-
- N DENOTES HOT ROLLED DEFORMED BAR.
- SL DENOTES HARD DRAWN WELDED WIRE FABRIC. THE NUMBER IMMEDIATELY FOLLOWING BAR NOTATION IS THE NOMINAL DIAMETER IN mm.
- PROVIDE BAR SUPPORTS OR SPACERS TO GIVE THE FOLLOWING COVER TO ALL RIENFORCEMENT UNLESS NOTED OTHERWISE.

FOOTINGS 80 BOTTOM, 65 TOP & SIDES

SLABS 30 BOTTOM, 20 TOP

BEAMS 40 BOTTOM & SIDES TO STIRRUPS. TOP COVER AS DETAILED

 PROVIDE 2N12 DIAGONAL CORNER BARS 900 LONG AT ALL RE-ENTRANT CORNERS OF OPENINGS IN SLABS AND THESE BARS TO BE POSITIONED 30mm FROM THE CORNER.

#### CONCRETE SPECIFICATION

- CARRY OUT ALL WORK IN ACCORDANCE WITH THE CURRENT ISSUE OF AS3600 & THE SPECIFICATION.
- CONCRETE SIZES SHOWN DO NOT INCLUDE FINISH & MUST NOT BE REDUCED OR HOLED IN ANY WAY WITHOUT THE ENGINEERS APPROVAL. DEPTH OF BEAMS INCLUDE SLAB THICKNESS.
- . SLABS & BEAMS ARE TO BE POURED TOGETHER.
- . CONSOLIDATE BY VIBRATION.
- SLAB CONCRETE TO BE AS SHOWN IN SLAB ON GRADE CRITERIA.
- BORED PIER CONCRETE SHALL HAVE F'C = 20 MPa, MAXIMUM AGGREGATE SIZE = 20 mm, SLUMP = 100 mm, EXCEPT FOR BCA CLASSES 2 TO 9 BUILDINGS CONCRETE SHALL HAVE F'C = 32MPa

#### **SLABS ON GRADE**

- SLABS TO BE PLACED OVER 25 CONSOLIDATED SAND OVER PREPARED SUBGRADE.
- PROVIDE 0.2 POLYTHENE FORTICON WATERPROOF MEMBRANE UNDER ALL SLABS WITH LAPPED & TAPED JOINTS.
- PLACE PUMP MIX CONCRETE AS SPECIFIED BELOW TO ACCURATE LEVELS AS PER ARCHITECTS SPECIFICATION.
- PROVIDE CONTROL JOINTS AS INDICATED BY NEATLY SAW CUTTING 40 x 6 GROOVES WITHIN 12 HOURS OF THE FINAL FLOAT OF THE CONCRETE.
- CURE SLAB FOR 7 DAYS AFTER PLACEMENT BY MAINTAINING A CONTINUOUSLY WET SURFACE BY APPROVED METHODS. FLOODING & COVERING WITH POLYTHENE IMMEDIATLY AFTER FINISHING IS AN APPROVED METHOD.
- SEALING OF JOINTS TO BE CARRIED OUT ONE MONTH MINIMUM AFTER CURING IS COMPLETE.
- PROVIDE PROPER STORMWATER DRAINAGE AWAY FROM THE BUILDING

SLAB ON GRADE CRITERIA	
CONCRETE COMPRESSIVE STRENGTH AT 28 DAYS (MPa)	20
FLEXURAL STRENGHT AT 90 DAYS (MPa)	5
SLUMP (mm)	100
AGGREGATE MAXIMUM SIZE (MM)	20
CEMENT TYPE	SL
CEMENT CONTENT (kg/cubic metre) MIN	320
FLY ASH CONTENT (kg/cubic metre) MAX	70
WATER / CEMENT RATIO (MAX)	0.45
MICROSTRAIN AT 56 DAYS	600
FLOOR FINISH - BURNISHED STEEL TROWEL	NON SLIP
FLOOR TOLERANCE	CLASS B

 FOR OTHER LOAD CONDITIONS A DESIGN VARIATION IS REQUIRED & SHOULD BE REFERED TO A QUALIFIED LOCAL ENGINEER.

#### **DIMENSION SCHEDULE**

S1	100RC SLAB
FABRIC	SL62T mesh



Copyright 2025 Lysaght Building Solutions Pty Ltd trading as RANBUILD

**Accredited Practitioner** 

Alexander Filonov

CC4719P LEVEL 1, 12 BEAUMONT ST

HAMILTON NSW 2303

+61 2 4962 4311 05/11/2025

FOR BUILDING PERMIT STAGE

CLIENT

Craig Wright

TE

3 Starlight Drive CAMBRIDGE TAS 7170

BUILDING

DELUXE SKILLION 7000 SPAN x 3200/3813 EAVE x 12000 LONG

REV

В

PAGE

7/7

TITLE CONCRETE SPECIFICATION, SITE NOTES

SCALE DRAWING NUMBER A3 SHEET 1:20 ENG6/1-440814

Pocument Set ID: 5742363 Version: 1, Version Date: 10/11/2025