

DEVELOPMENT APPLICATION PDPLANPMTD-2025/055444

PROPOSAL: Additions & Alterations to Existing Dwelling

LOCATION: 214 Tranmere Road, Tranmere

RELEVANT PLANNING SCHEME: Tasmanian Planning Scheme - Clarence

ADVERTISING EXPIRY DATE: 12 January 2026

The relevant plans and documents can be inspected at the Council offices, 38 Bligh Street, Rosny Park, during normal office hours until 12 January 2026. In addition to legislative requirements, plans and documents can also be viewed at www.ccc.tas.gov.au during these times.

Any person may make representations about the application to the Chief Executive Officer, by writing to PO Box 96, Rosny Park, 7018 or by electronic mail to clarence@ccc.tas.gov.au. Representations must be received by Council on or before 12 January 2026.

To enable Council to contact you if necessary, would you please also include a day time contact number in any correspondence you may forward.

Any personal information submitted is covered by Council's privacy policy, available at www.ccc.tas.gov.au or at the Council offices.



38 Bligh St Rosny Park PO Box 96 Rosny Park TAS, 7018

03 6217 9500 clarence@ccc.tas.gov.au ccc.tas.gov.au

Application for Development / Use or Subdivision

Use this form to obtain planning approval for developing or using land, including subdividing it into smaller lots or lot consolidation.

Proposal:

Extension to exiting residence

Location:

214 TRANMERE RD, TRANMERE

Personal Information Removed





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Is the property on the Tasmanian Heritage Register?	Yes □	No ■
If yes, we recommend you discuss your proposal with Heritage Tasmania prior exemptions may apply which may save you time on your proposal.	to lodgem	ent as
If you had pre-application discussions with City of Clarence, please provide pla	anner's nai	me:
Current use of site: Existing Private Residence		
Does the proposal involve land administered or owned by the Crown or Council	l? Yes □	No ■

Declaration

- I have read the Certificate of Title and Schedule of Easements for the land am satisfied that this application is not prevented by any restrictions, easements or covenants.
- I authorise the provision of a copy of any documents relating to this application to any person
 for the purposes of assessment or public consultation. I agree to arrange for the permission
 of the copyright owner of any part of this application to be obtained. I have arranged
 permission for Council's representatives to enter the land to assess this application
- I declare that, in accordance with Section 52 of the Land Use Planning and Approvals Act 1993, that I have notified the owner of the intention to make this application. Where the subject property is owned or controlled by Council or the Crown, their signed consent is attached.
- I declare that the information in this declaration is true and correct.

Acknowledgement

I acknowledge that the documentation submitted in support of my application will become a
public record held by Council and may be reproduced by Council in both electronic and hard
copy format in order to facilitate the assessment process; for display purposes during public
consultation; and to fulfil its statutory obligations. I further acknowledge that following
determination of my application, Council will store documentation relating to my application
in electronic format only.

Personal Information Removed

Please refer to the development/use and subdivision checklist on the following pages to determine what documentation must be submitted with your application.





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03 6217 9500 clarence@ccc.tas.gov.au ccc.tas.gov.au

Development/use or subdivision checklist

Mandatory Documents

This information is required for the application to be valid. We are unable to proceed with an application without these documents.

- ✓ Details of the location of the proposed use or development.
- ✓ A copy of the current Certificate of Title, Sealed Plan, Plan or Diagram and Schedule
 of Easements and other restrictions for each parcel of land on which the
 use or development is proposed.
- Full description of the proposed use or development.
- ▼ Description of the proposed operation. May include where appropriate: staff/student/customer numbers; operating hours; truck movements; and loading/unloading requirements; waste generation and disposal; equipment used; pollution, including noise, fumes, smoke or vibration and mitigation/management measures.
- $\mathbf{\nabla}'$ Declaration the owner has been notified if the applicant is not the owner.
- Crown or Council consent (if publically-owned land).
- ☐ Any reports, plans or other information required by the relevant zone or code.
- ✓ Fees prescribed by the City of Clarence.

Application fees (please phone 03 6217 9550 to determine what fees apply). An invoice will be emailed upon lodgement.

Additional Documents

In addition to the mandatory information required above, Council may, to enable it to consider an application, request further information it considers necessary to ensure that the proposed use or development will comply with any relevant standards and purpose statements in the zone, codes or specific area plan, applicable to the use or development.

- ✓ Site analysis and site plan, including where relevant:
 - Existing and proposed use(s) on site.
 - Boundaries and dimensions of the site.
 - Topography, including contours showing AHD levels and major site features.
 - Natural drainage lines, watercourses and wetlands on or adjacent to the site.
 - Soil type
 - Vegetation types and distribution, and trees and vegetation to be removed.





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- Location and capacity of any existing services or easements on/to the site.
- Existing pedestrian and vehicle access to the site.
- Location of existing and proposed buildings on the site.
- Location of existing adjoining properties, adjacent buildings and their uses.
- Any natural hazards that may affect use or development on the site.
- Proposed roads, driveways, car parking areas and footpaths within the site.
- Any proposed open space, communal space, or facilities on the site.
- Main utility service connection points and easements.
- Proposed subdivision lot boundaries.
- ✓ Where it is proposed to erect buildings, detailed plans with dimensions at a scale of 1:100 or 1:200 showing:
 - Internal layout of each building on the site.
 - Private open space for each dwelling.
 - External storage spaces.
 - Car parking space location and layout.
 - Major elevations of every building to be erected.
 - Shadow diagrams of the proposed buildings and adjacent structures demonstrating the extent of shading of adjacent private open spaces and external windows of buildings on adjacent sites.
 - Relationship of the elevations to natural ground level, showing any proposed cut or fill.
 - Materials and colours to be used on rooves and external walls.
- Where it is proposed to erect buildings, a plan of the proposed landscaping showing:
 - Planting concepts.
 - Paving materials and drainage treatments and lighting for vehicle areas and footpaths.
 - Plantings proposed for screening from adjacent sites or public places.
- Any additional reports, plans or other information required by the relevant zone or code.

This list is not comprehensive for all possible situations. If you require further information about what may be required as part of your application documentation, please contact City of Clarence Planning team on (03) 6217 9550.





RESULT OF SEARCH

RECORDER OF TITLES

Issued Pursuant to the Land Titles Act 1980



SEARCH OF TORRENS TITLE

VOLUME	FOLIO
12491	107
EDITION	DATE OF ISSUE
4	01-Dec-2022

SEARCH DATE : 09-Sep-2025 SEARCH TIME : 02.35 PM

DESCRIPTION OF LAND

City of CLARENCE

Lot 107 on Plan 12491

Derivation: Part of 730-0-0 Granted to F. Butler and J. McC.

Browne

Derived from W2670

SCHEDULE 1

M747975 TRANSFER to JUSTIN ROXLEY WOOLLEY and HOLLY KATE

STEWART Registered 09-Apr-2019 at noon

SCHEDULE 2

Reservations and conditions in the Crown Grant if any E325559 MORTGAGE to Commonwealth Bank of Australia Registered 01-Dec-2022 at 12.01 PM

UNREGISTERED DEALINGS AND NOTATIONS

No unregistered dealings or other notations

Page 1 of 1





FOLIO PLAN

RECORDER OF TITLES



Issued Pursuant to the Land Titles Act 1980

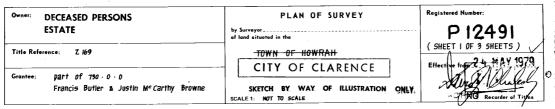

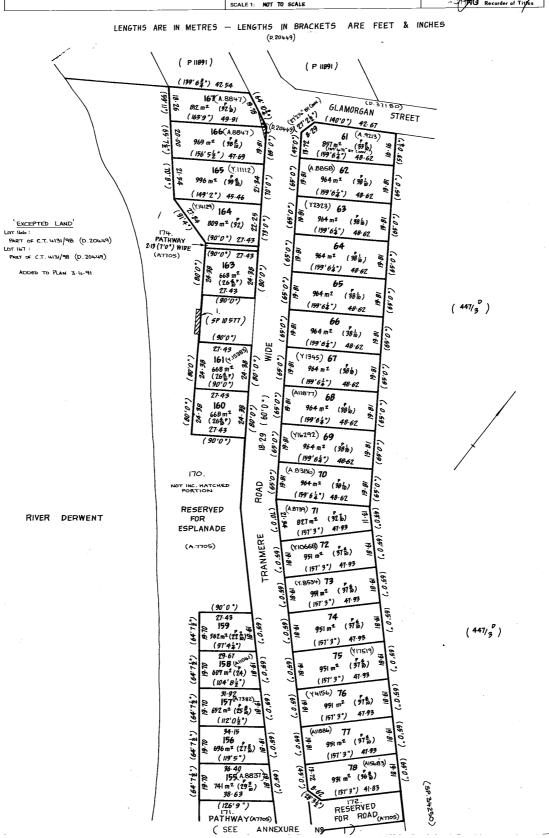

Search Date: 09 Sep 2025

Search Time: 02:35 PM

Volume Number: 12491

Revision Number: 07

Page 1 of 3




FOLIO PLAN

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Page 2 of 3





FOLIO PLAN

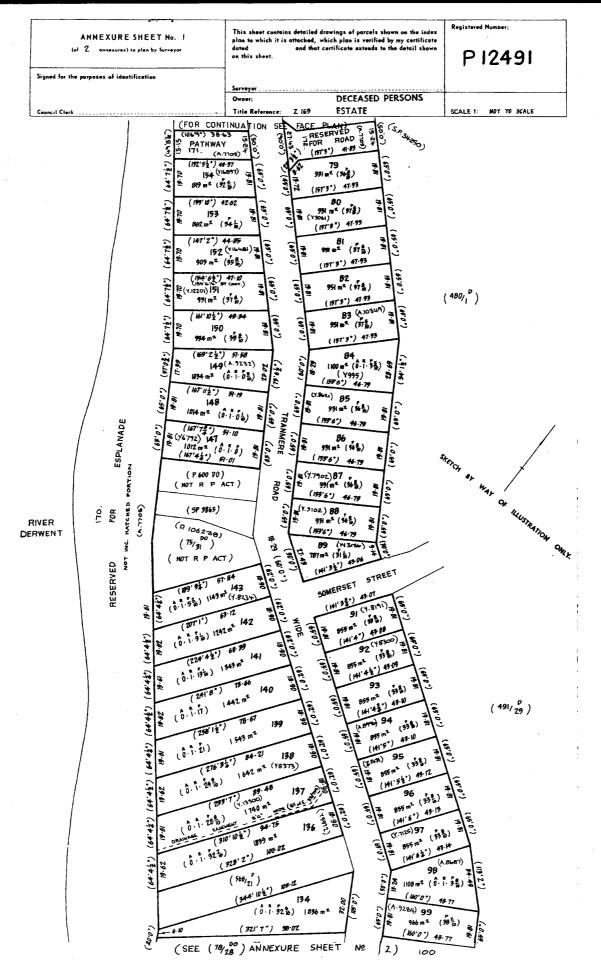RECORDER OF TITLES



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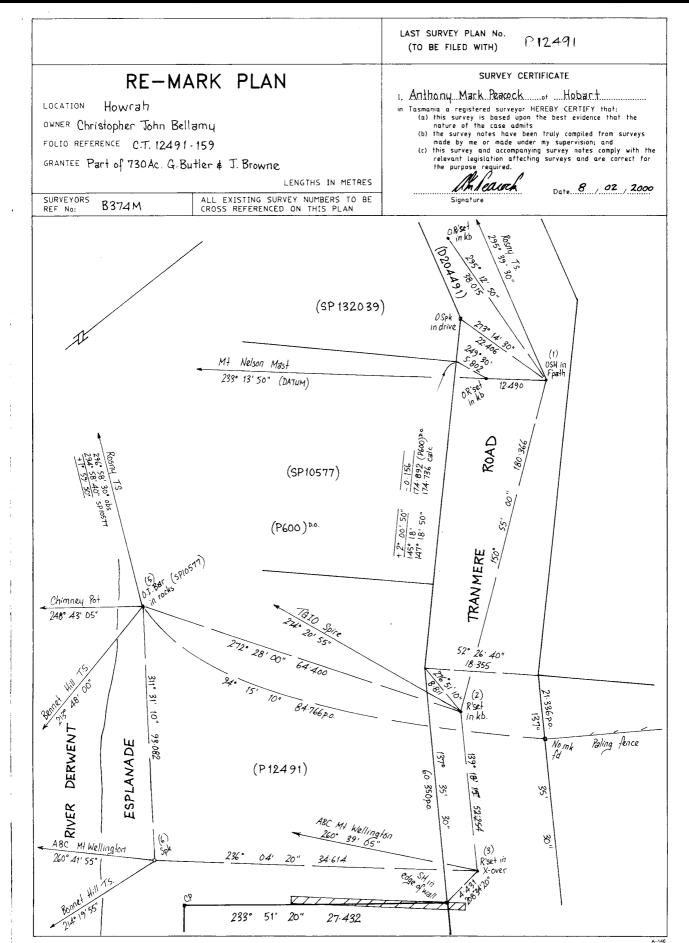


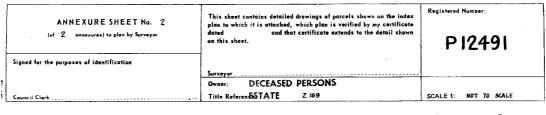
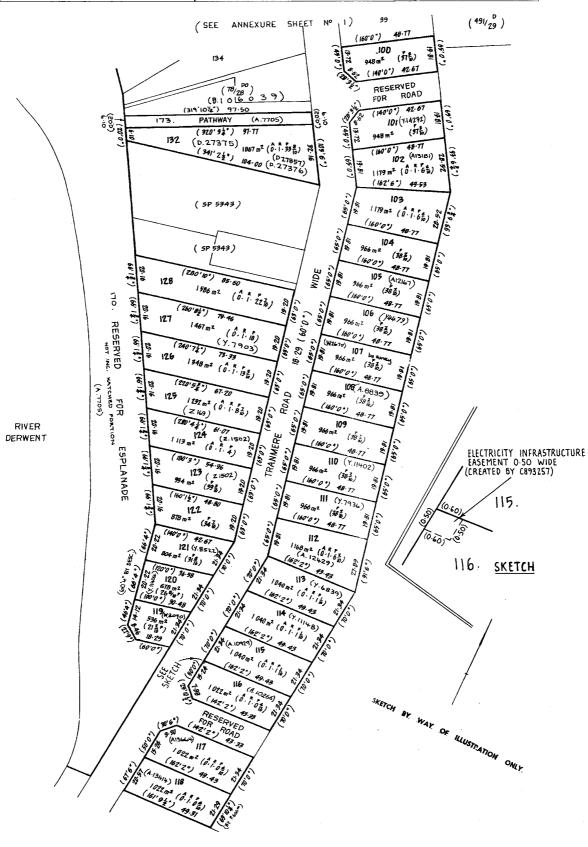
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Search Date: 09 Sep 2025

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Volume Number: 12491

Revision Number: 07

Page 1 of 4



RECORDER OF TITLES



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RE-MARK PLAN

Howrah LOCATION

Christopher John Bellamy OWNER FOLIO REFERENCE C.T. 12491 - 159.

GRANTEE Part of 730 Ac. G. Butler & J. Browne

LENGTHS IN METRES

ALL EXISTING SURVEY NUMBERS TO BE CROSS REFERENCED ON THIS PLAN

LAST SURVEY PLAN No. (TO BE FILED WITH)


P 12491

SURVEY CERTIFICATE

- I. Anthony Mark Peacock of Hobart
- in Tasmania a registered surveyor HEREBY CERTIFY that:
 (a) this survey is based upon the best evidence that the nature of the case admits
 (b) the survey notes have been truly compiled from surveys made by me or made under my supervision; and
 (c) this survey and accompanying survey notes comply with the relevant legislation affecting surveys and are correct for the purpose required.

 Date 8 / 02 / 2000



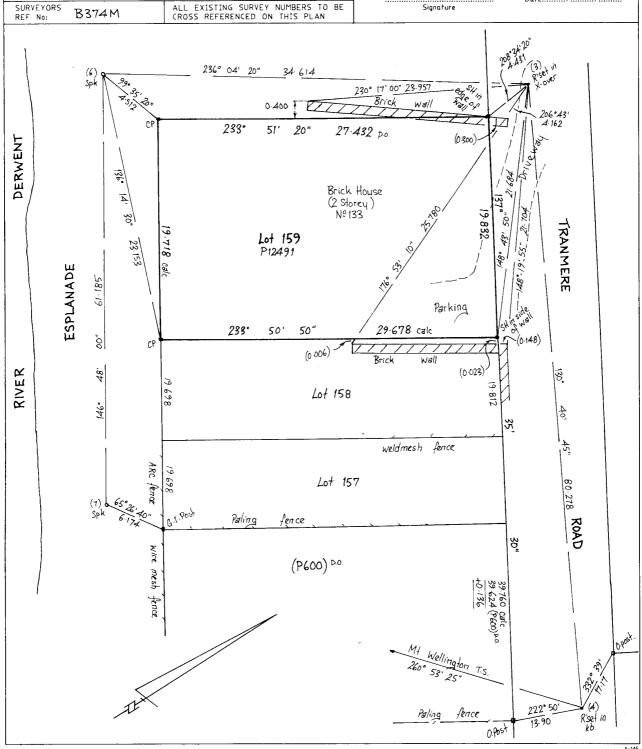

Search Date: 09 Sep 2025

Search Time: 02:35 PM

Volume Number: 12491

Revision Number: 07


Page 2 of 4



RECORDER OF TITLES



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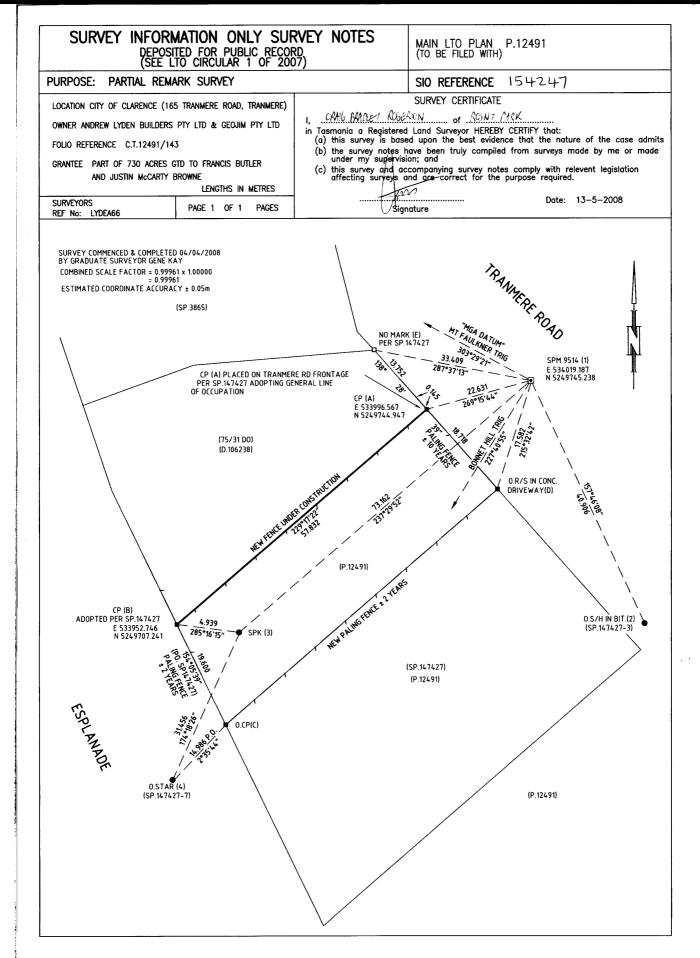
Search Date: 09 Sep 2025 Search Time: 02:35 PM Volume Number: 12491 Revision Number: 07 Page 3 of 4

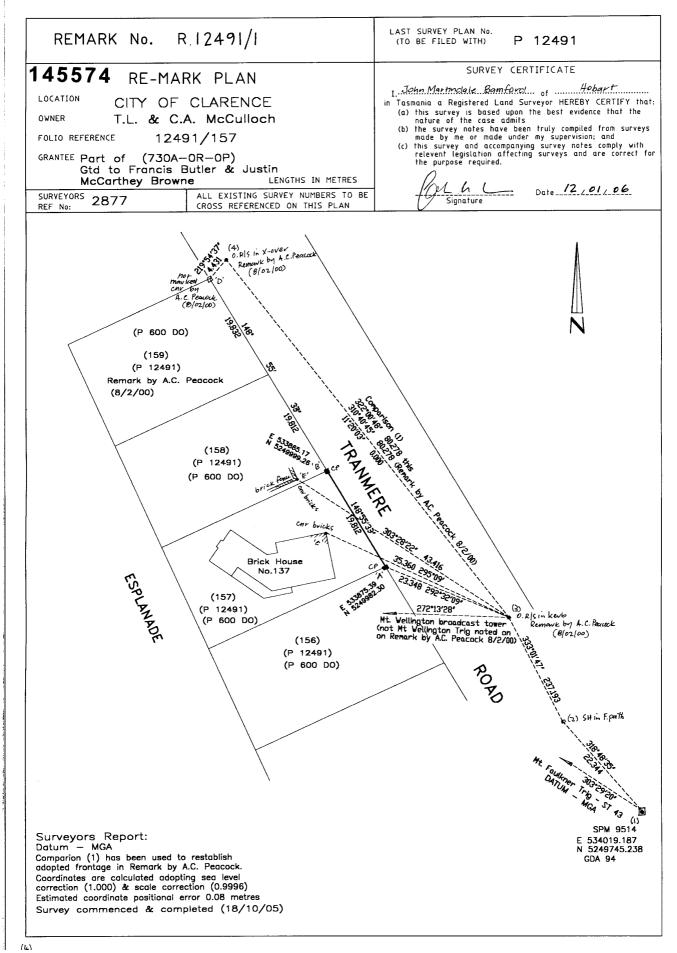

RECORDER OF TITLES



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Search Date: 09 Sep 2025

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Page 4 of 4

Drawing List (13 sheets)

Architectural

Sheet A01 Existing site plan Sheet A02 Proposed site plan Sheet A03 Existing floor plan Sheet A04 Proposed floor plan

Sheet A05 **Elevations - Main Dwelling** Section plan - Architectural Sheet A06 Sheet A07 Sun Shading diagrams

Sheet H01 Roof plan

Sheet M01-M05 -SWMP's

Planning Application for Internal alterations, extension and new deck for J. Woolley H. Stewart at

214 Tranmere Road, Tranmere

ARCHIBIM

ARCHITECTURAL BUILDING INVENTORY MODELLING

ABN: 34 625 657 785

Unit 23, 15 Stanton Place, Cambridge TAS 7170

Email: damon@archibim.com.au

(c) All plans

NOTES TO PLANS

To be read in conjunction with plans and specifications

- It is considered mandatory that a registered surveyor be engaged to confirm all dimensions. It is encumbent upon the builder to instigate this process. Discrepancies are to be notified to this office
- All materials and work, including installation methods to be in accordance with the relevant AS code, BCA and Manufacturers recommendations
- It is encumbent and expected that the builder and/or tradesman will be familiar with, and apply exactingly, all of the relevant Manufacturers directions and instructions (including those contained within the BCA) for the various materials and systems used in this project. This office can provide this information on request.
- Although every care is taken, R & M Jackson accepts no responsibility for interpretation, error or omission. It is expected that all building work will be carried out in a professional manner in accordance with the relevant AS codes however where ambiguity or doubt exists on the plans the builder MUST notify this office immediately. It is also expected that the builder will be familiar with anc understand all aspects of the construction before commencement.
- These drawings to be read in conjunction with engineers reports and other associated reports and details.
- All plumbing and drainage to AS 3500 and Local Authority requirements All electrical work to be in accordance with the relevant AS codes.
- Aerial imagery courtesy of 'Google Maps Aust.' where supplied.
- Any changes to the drawings (as constructed) after submission to the building surveyor are at the cost of the owner and/or the builder and to be paid

REVD

PROJECT No



Accredited Building Practitioner Licence No: CC340Y

ontractor to verify the location of all current underground services shown on the plans including but not limited to electricity, telecom, gas, sewer, stormwater, NBN etc. prior to excavation.

(DBYD www.1100.com.au)

LEGEND:

FENCE CENTER OF ROAD LIST BOUNDARY

TREE TRUNK **DRIVEWAY**

SW PIPELINE SEWER LINE

COMMUNICATION LINE

POWER LINE

GAS LINE

BUILDING WALL BUILDING EAVE

BACK OF KERB

INVERT OF KERB

EDGE OF PAVEMENT

MAJOR CONTOUR

MINOR CONTOUR



48.77 160°0'

TRANMERE EXISTING DRIVEWAY TERRACE CONCRETE

48.77 160°0'

Date	Rev.	Description	Drawn By	SITE DESCRIPTION
19/06/2025	Α	Issued for Council Approval	D. Jackson	WIND CLASS -
28/10/2025	В	Issued for RFI	D. Jackson	SOIL CLASS -
26/11/2025	С	Issued for RFI	D. Jackson	CLIMATE ZONE -
04/12/2025	D	Issued for RFI	D. Jackson	ENERGY RATING -

ARCHIBIM - AS4055

ROAD

- AS2870

- refer report - Lot 107 966m²

- 7

ARCHITECTURAL BUILDING INVENTORY MODELLING

ABN: 34 625 657 785

Unit 1, 10 Stanton Place, Cambridge TAS 7170 Email: archibim@outlook.com.au



Client:	J. WOOLLEY & H. STEWART
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214 TRANMERE ROAD, TRANMERE Project:

Title: Survey Plan Scale: 1:200

Drawn : D. Jackson	Date :	13/05/2025	Checked by: R.JACKSON CC340Y
Designed : D. Jackson	Date:	01/05/2025	
JOB NUMBER: 130725	Drawing :	A01	REVISION: D

Contractor to verify the location of all current underground services shown on the plans including but not limited to electricity, telecom, gas, sewer, stormwater, NBN etc. prior to excavation.

(DBYD www.1100.com.au)

ALL DIMENSIONS & LEVELS TO BE CONFIRMED BY BUILDER ON SITE PRIOR TO COMMENCEMENT. DISCREPANCIES TO BE REFERRED TO THIS OFFICE IMMEDIATELY

Clarence City Tasmanian Planning Scheme Zone : General Residential


Floor Areas:

Main Dwelling - 144.70m²
Portico/Patio - 15.20m²
New Deck - 14.15m²
TOTAL - 174.05m²
SITE COVERAGE - 18.01%

BAL LOW

OH&S HAZARD
Type: public safety
Solution: provision of

Solution: provision of safety fencing around construction area

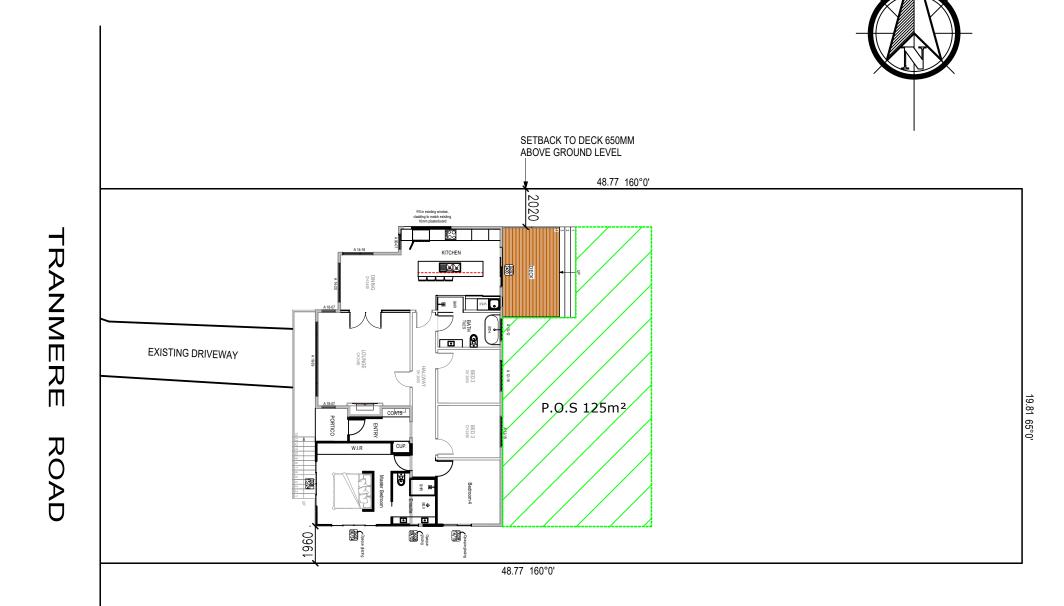

Date	Rev.	Description	Drawn By	SITE DESCRIPTION
19/06/2025	Α	Issued for Council Approval	D. Jackson	WIND CLASS -
28/10/2025	В	Issued for RFI	D. Jackson	SOIL CLASS -
26/11/2025	C	Issued for RFI	D. Jackson	CLIMATE ZONE -
04/12/2025	D	Issued for RFI	D. Jackson	ENERGY RATING - TITLE 12491 -
				11166 12791 -

ARCHIBIM - AS4055

ARCHITECTURAL BUILDING INVENTORY MODELLING

ABN: 34 625 657 785

- AS2870 - 7

refer report

- Lot 107 966m²

Unit 1, 10 Stanton Place, Cambridge TAS 7170 Email: archibim@outlook.com.au



Client:	J. WOOLLEY & H. STEWART
Project:	214 TRANMERE ROAD, TRANMERE

Title: Proposed Site Plan

Scale	1.200

Drawn:	D. Jackson	Date :	13/05/2025	Checked by: R.JACKSON CC340Y
Designed:	D. Jackson	Date:	01/05/2025	Checked by. R.JACKSON CC3401
10B NUMBE	R · 130725	Drawing :	ΔΩ2	REVISION: D

ALL DIMENSIONS & LEVELS TO BE CONFIRMED BY BUILDER ON SITE PRIOR TO COMMENCEMENT. DISCREPANCIES TO BE REFERRED TO THIS OFFICE IMMEDIATELY

Contractor to verify the location of all current underground services shown on the plans including but not limited to electricity, telecom, gas, sewer, stormwater, NBN etc. prior to excavation. (DBYD www.1100.com.au)


ROBE LAUNDRY BED 2 CH 2450 BED 3 CH 2450 BATH TILES BED 1 ROBE ROBE KITCHEN CH 2450 HALLWAY CH 2450 MB PORCH DINING CH 2450 LOUNGE **TERRACE**

Existing Main Floor Plan 1:100

Floor Areas:

Main Dwelling - 116.00m² - 39.25m² Terrace - 1.10m² Porch Garage/Workshop - 64.62m² Covered Patio - 9.73m²

TOTAL - 230.70m²

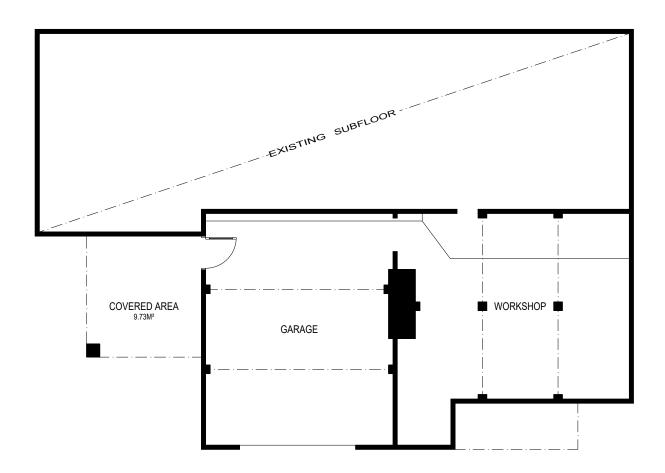

Existing LOWER Floor Plan 1:100

Date	Rev.	Description	Drawn By	SITE DESCRIPTION	I
19/06/2025	Α	Issued for Council Approval	D. Jackson	WIND CLASS	- AS4055
28/10/2025	В	Issued for RFI	D. Jackson	SOIL CLASS	- AS2870
26/11/2025	С	Issued for RFI	D. Jackson	CLIMATE ZONE	- 7
04/12/2025	D	Issued for RFI	D. Jackson	ENERGY RATING	- refer report - Lot 107 966m ²
					- LOC 107 900III-

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ARCHITECTURAL BUILDING INVENTORY MODELLING

ABN: 34 625 657 785

Unit 1, 10 Stanton Place, Cambridge TAS 7170 Email: archibim@outlook.com.au

ARCHIBIM	
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Client:	J. WOOLLEY & H. STEWART
Project:	214 TRANMERE ROAD, TRANMERE
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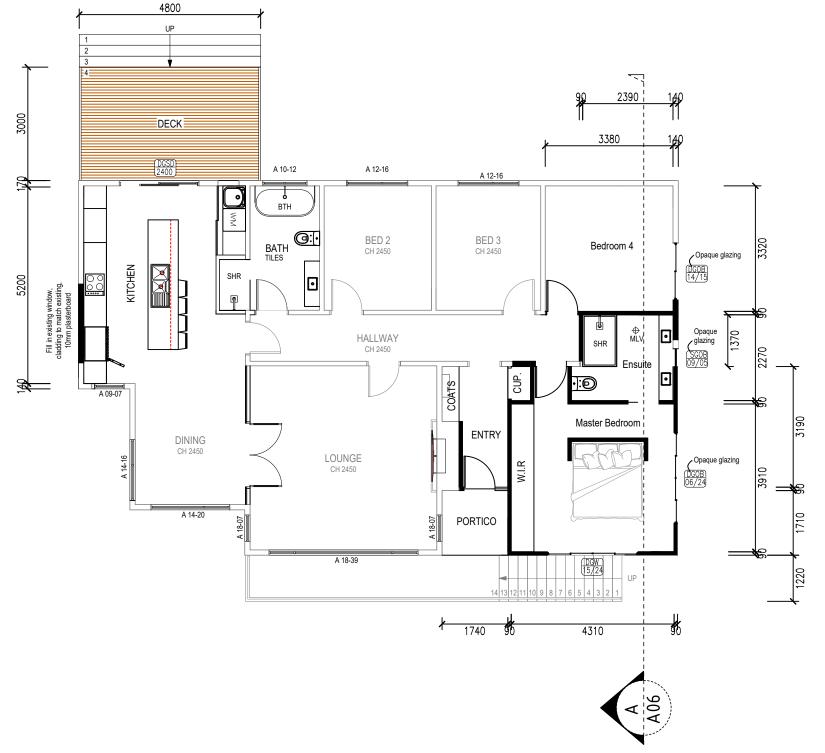
Existing Floor Plans Title:

Scale:	1:100
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		Date : Date:	13/05/2025 01/05/2025	Checked by: R.JACKSON CC340Y	
OB NUMBER	: 130725	Drawing :	A03	REVISION: D	

ALL DIMENSIONS & LEVELS TO BE CONFIRMED BY BUILDER ON SITE PRIOR TO COMMENCEMENT. DISCREPANCIES TO BE REFERRED TO THIS OFFICE IMMEDIATELY

Contractor to verify the location of all current underground services shown on the plans including but not limited to electricity, telecom, gas, sewer, stormwater, NBN etc. prior to excavation. (DBYD www.1100.com.au)



- AS4055

- AS2870

- refer report

- Lot 107 966m²

- 7

NOTES:-

- 1. Kitchen to be provided with rangehood vented externally
- 2. All MLV's to be vented externally (can interconnect in roof space) and to be provided with time delay switches.
- 3. All cupboards adjacent to external walls to be provided with air vents
- 4. ARTIFICIAL LIGHTING
- max. 5 watts/m2 for living areas
- max. 4 watts/m² for balconies. verandahs
- max. 3 watts/m2 for Class 10a buildings (assoc. with Class 1a)
- 5. All windows are to positioned centrally within walls UNO
- 6. Provide 12mm ply blocking between studs at positions of handrails etc in WC's and bathrooms
- 7. All doors UNO to be 2040x820
- 8. WC door to either inward swing with removable hinges, outward swing, slide, or inward swing with 1200mm min. between doorway and pan

Door & window Tag Legend

(sizes examples only - refer to floor plan for actual)

Single Glazed Safety Glass Window (1000h x 900w) Single Glazed Window (1000h x 1800w) DGW 10/18 Double Glazed Window (1000h x 1800w) Single Glazed Sliding Doors (2100h x 1800w)

Double Glazed Sliding Doors (2100h x 1800w)

Single Glazed Fixed Glass (1000h x 900w) Double Glazed Safety Glass Window (1000h x 900w)

d/h denotes double hung / slid. denotes sliding / aw. denotes awning

NOTE: * bathroom and wc glazing to be obscure unless directed otherwise by owners

Where windows are > 2m (bedrooms) and > 4m (all others) above external surface refer table above

Denotes mech. light & ventilation to AS1668.2 MLV

Denotes wired-in smoke detector to AS 3786

NOTE: All to be interconnected to operate simultaneously

NOTE: ALL WINDOWS TO BE ALUM. FRAMED

REFER ENERGY ASSESSMENT RE: U and SHGC values

WINDOW/DOORS TO BE MANUFACTURED TO

BAL LOW - N3

Floor Areas:

Main Dwelling - 144.70m² Portico/Patio - 15.20m² New Deck - 14.15m²

TOTAL - 174.05m²

WINDOW SPECIFICATIONS TO NCC:-

BEDROOMS where external fall height >2m

- * where opening is more than 1700mm (sill) above floor NO opening restrictions.
- * where opening is within 1700mm above floor and has climbable element between 150mm and 750mm, opening to be restricted to 125mm or fitted with a non-removable robust screen.
- * where opening is between 865mm and 1700mm above floor and has no climbable element between 150mm and 760mm above floor, opening to be restricted to 125mm or fitted with a removable robust screen.
- * where opening is within 865mm above floor and has climable element between 150mm and 760mm above the floor, opening to be restricted to 125mm or fitted with non-removable robust screen.

ALL OTHERS where external fall height >4m

- * where window transom is above 865mm above floor and a sill height less than 150mm and no opening within 865mm above floor, NO opening restriction required.
- $\ensuremath{^*}$ as above where sill is greater than 150mm, opening to be restricted.
- * where window transom is below 856mm above the floor and sill is less than 150mm, opening is to be restricted. This note is for information only - manufacturer to confirm and liase with builder and owner.

Date	Rev.	Description	Drawn By	SITE DESCRIPTION
19/06/2025	Α	Issued for Council Approval	D. Jackson	WIND CLASS -
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26/11/2025	С	Issued for RFI	D. Jackson	CLIMATE ZONE -
04/12/2025	D	Issued for RFI	D. Jackson	ENERGY RATING - TITLE 12491 -

ARCHIBIM

ARCHITECTURAL BUILDING INVENTORY MODELLING

ABN: 34 625 657 785

Unit 1, 10 Stanton Place, Cambridge TAS 7170

Email: archibim@outlook.com.au




Client: J. WOOLLEY & H. STEWART

214 TRANMERE ROAD, TRANMERE Project:

Title: Proposed Floor Plan

1:100 Scale:

Drawn: D. Jackson 13/05/2025 Checked by: R.JACKSON CC340Y 01/05/2025 JOB NUMBER: 130725 A04 REVISION: D

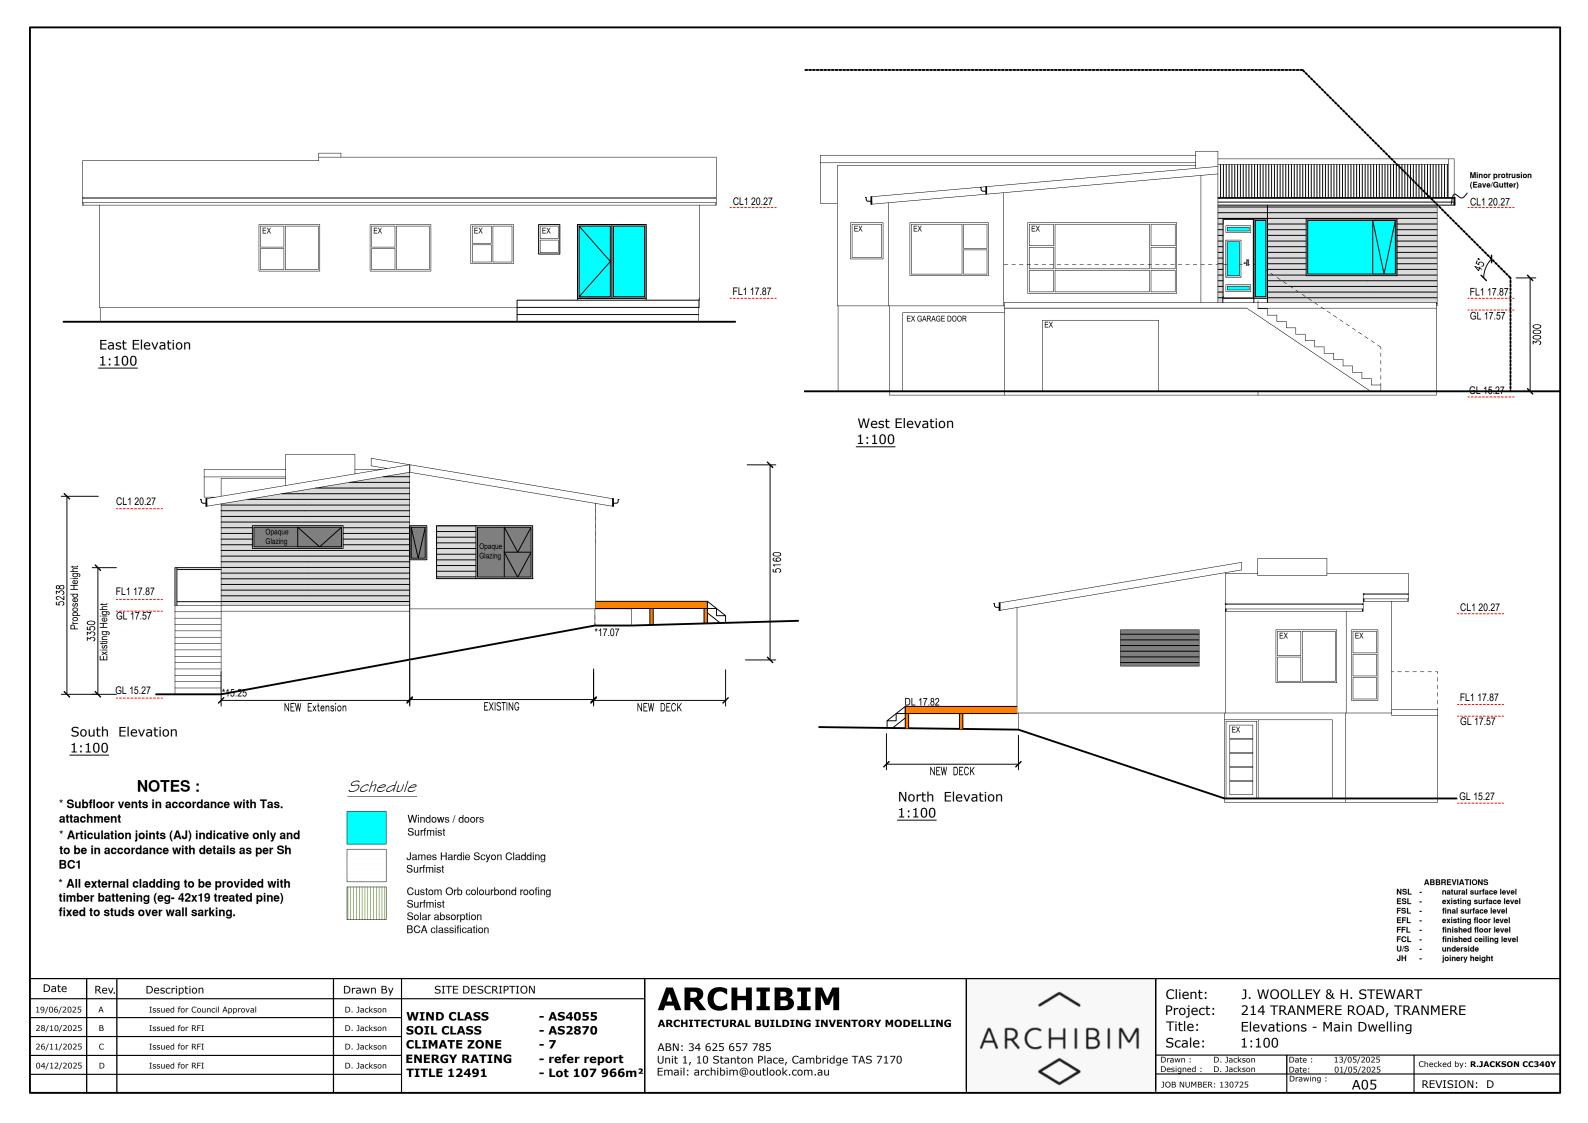

SITE DRAINAGE

As shown on drawings. Min camber of 1 in 20 for first 1 metre around perimeter of building.

STAIRS & BALUSTRADES

STAIRS - (NOTE: 2R+G = 550min-700max) min clear width of 820mm 240mm min going (G) 355mm max going (G) min rise (R) 115mm max rise (R)(refer below) 190mm

NOTE: min. 2000mm from toe of tread to FCL above.

Provide solid/partly solid risers to 125mm from u/s of above tread or limit rise to 170mm

STRINGERS (max stair width 1000mm)

240x45 F5 (internal -max 15 risers)

290x35 F5 TRP (external- max 15 risers)

TREADS

45 thick F5 (internal/external - max span 1000mm) All treads to be provided with a slip-resistant finish or non-skid strip in accordance with 3.9.1.4 - eg. 'Crocgrip' non-slip tape.

NOTE: All treads to be housed into stringers and 8mm S/S rods bolted through opposing stringers every 4th +- tread

To be provided along (1) side of the stair where height above floor exceeds 1m. Height to be not less than 865mm above nosing of treads.

BALUSTRADES (Required where floor height exceeds 1m from surface level) (Refer Sh BC2)

1000mm high(Refer drawings) Stair balustrades 865mm height from edge of nosing.

125mm max aperture Wire balustrades to comply with Clause 3.9.2.3 (f) and Tables 3.9.2.1. - 3.9.2.2 and 3.9.2.3

GLAZING

All glazing to AS 1288,AS 2047 and Part 3.6 of BCA. Opening windows to comply with notation Sh A4 (Window Schedule). Certification of compliance with the above and to the relevant BAL (if required) to be provided to Building Surveyor.

TIE DOWNS (WALL & ROOF) - refer Sh S5

WALL FRAMING MGP10 - refer Sh S5

BRICKWORK SPEC'S - refer Sh SDB1

CONDENSATION CONTROL - refer Sh SDC1

SOFFITS

4.5mm Hardiflex fixed with 30x2.8 fibre cement nails at 200 crs to trimmers

k/d TRP denotes kiln dried treated pine

CLADDING

All cladding to be provided with battening strips over wall sarking

ELECTRICAL - Pendant light fittings only. NO downlights to be installed unless provided with unventilated shields. **ARTIFICIAL LIGHTING -**

*max. 5watts/m² for living areas

*max. 4 watts/m² for balconies / verandahs

*max. 3 watts/m² for Class 10a buildings (assoc. with Class 1a)

STRUCTURAL STEEL (internal moderate environment) -

no protection required

WOODHEATERS

To be installed in accordance with 3.7.3 of BCA and AS 2918 and damper to be provided in flue.

ENERGY EFFICIENCY - 2 (where applicable)

Provide R2.5 insulation batts between floor joists eg - CSR 'Optimo' installed in accordance with Manuf. instructions

ROOF VENTILATION -refer Sh SDC1 /H1

EXHAUST FANS - to have dampers fitted

WALL & CEILING LININGS

10mm plasterboard on furring channel at 450ctrs to all ceilings except where noted otherwise. 10mm plasterboard to all wall areas except where noted otherwise.

ROOF TRUSSES

Roof truss design to be obtained prior to commencement to verify that point loadings from girder trusses (if applicable)can be integrated into the footing design. Engineer to be contacted where doubt exists.

STRUCTURAL STEEL (external moderate environment) -

*All members (if **non-Duragal**) - to be painted with (2) coats of alkyd primer **or** (2) coats of alkyd similar to 150mm min above vanity/laundry basins. Ceramic

*If **Duragal** - (1) coat of of solvent based vinyl primer or (1) coat of vinyl gloss or alkyd *OR - hot dipped galv. (300g/m²)

ENERGY EFFICIENCY - 1

WET AREA FINISHES TO AS 3740

3740 and Part 3.8.1 of BCA - Refer Sh BC3

Villaboard or similar to all walls and ceilings Ceramic tiles or

similar to 1800mm above shower base. Ceramic tiles or

Ceramic tiles or similar to all floors with approved cement

sheet underlay fixed as per Manufacturers instructions.

Waterproofing as required in strict accordance with As

tiles or similar to 150mm min above kitchen benches.

(refer also to 2 if applicable)


Provide Enviroseal Proctorwrap HT-R or equivalent over roof battens. Provide "Cavibat' roof battens over membrane. Roof blanket not to be used. Provide **R6.0** insulation batts to all ceiling areas. Provide wrap to all external walls fixed to external face (eg-Tyvek Homewrap or other equivalent Class 4 sarking) Provide air infiltration seal to all edges of external doors and windows.

Provide R2.5 insulation batts between studs to all external walls and other walls where noted.



ROOF TRUSSES (T1)

Approved roof trusses at 900 crs designed, certified and supplied by accredited manufacturer and fixed as per details (refer note over) or to directions supplied by Manufacturer. ROOF BATTENS 75x38 F8 at 900 crs fixed as per table Provide Enviroseal Proctorwrap HT-R sarking on roof battens with 'Cavibat' battens over. Provide R6.0 insulation to ceiling areas.

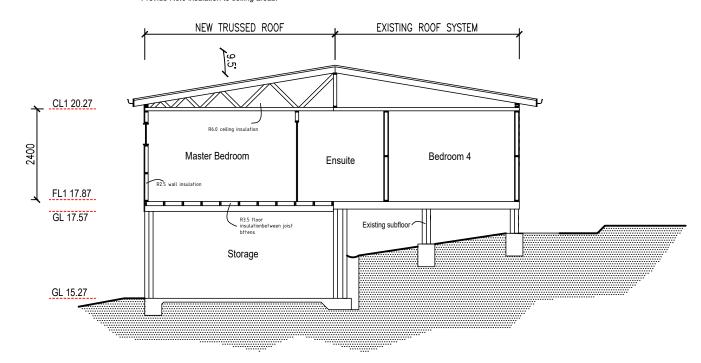

Date	Rev.	Description	Drawn By	SITE DESCRIPTION
19/06/2025	Α	Issued for Council Approval	D. Jackson	WIND CLASS
28/10/2025	В	Issued for RFI	D. Jackson	SOIL CLASS
26/11/2025	С	Issued for RFI	D. Jackson	CLIMATE ZONE
04/12/2025	D	Issued for RFI	D. Jackson	ENERGY RATING
				1

ARCHIBIM

ARCHITECTURAL BUILDING INVENTORY MODELLING

ABN: 34 625 657 785

- AS4055

- AS2870

- refer report

- Lot 107 966m²

- 7

Unit 1, 10 Stanton Place, Cambridge TAS 7170

Email: archibim@outlook.com.au




J. WOOLLEY & H. STEWART Client: Project: 214 TRANMERE ROAD, TRANMERE

Title: Section Plan - Main Dwelling

Scale: 1:100

rawn: D. Jackson	Date :	13/05/2025	Checked by: R.JACKSON CC340Y
esigned: D. Jackson	Date:	01/05/2025	Checked by. R.JACKSON CC3401
OB NUMBER: 130725	Drawing:	۸06	REVISION: D

June 21 Astronomy date Hobart, Tas Sun Rise - 7:42am Sun Set - 4:43pm Length of day - 9h 00m 46sec date supplied by timeanddate.com/worldclock

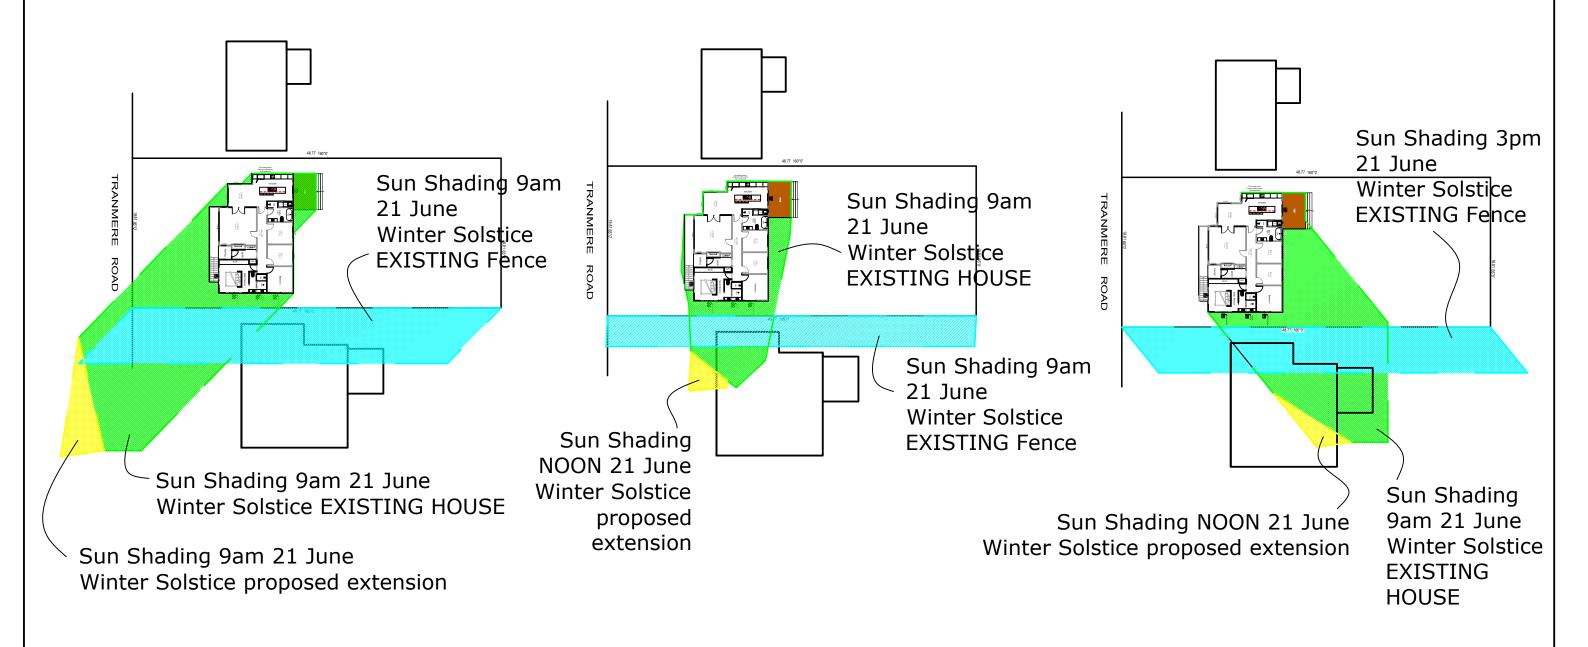

Date	Rev.	Description	Drawn By	SITE DESCRIPTION	
19/06/2025	Α	Issued for Council Approval	D. Jackson	WIND CLASS -	AS4055
28/10/2025	В	Issued for RFI	D. Jackson		AS2870
26/11/2025	С	Issued for RFI	D. Jackson		7
04/12/2025	D	Issued for RFI	D. Jackson		refer report Lot 107 966m ²
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ABN: 34 625 657 785

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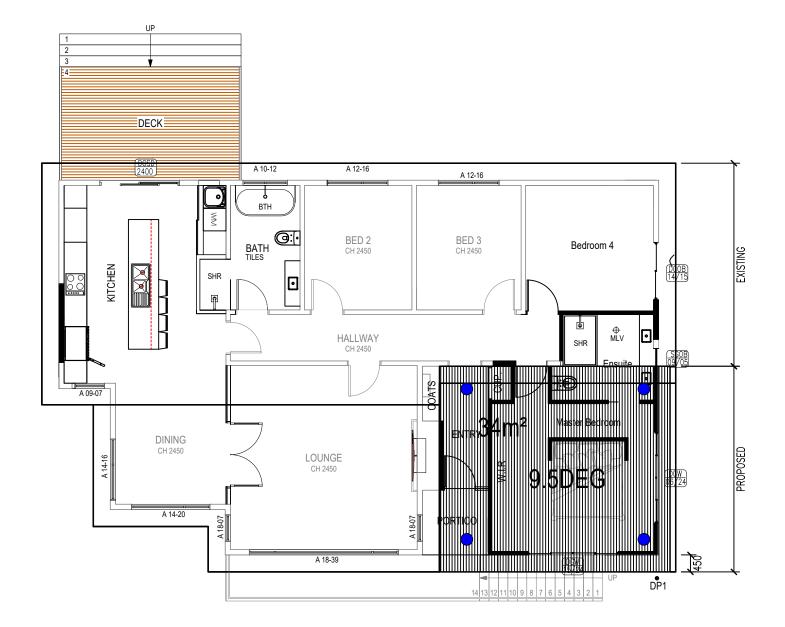


Client:	J. WOOLLEY & H. STEWART
Project:	214 TRANMERE ROAD, TRANMERE
Title:	Roof / Stormwater Plan

Title: Roof / Stormwater Plan

Drawn:	D. Jackson	Date :	13/05/2025	Checked by: R.JACKSON CC340)
Designed:	D. Jackson	Date:	01/05/2025	Checked by: K.JACKSON CCS401
JOB NUMBER	R: 130725	Drawing:	A07	REVISION: D

All roof areas shown are indicative only and not to be used for any other purpose



ROOFWATER DRAINAGE

Rainfall intensity - eaves gutters - 99ml/hour (1 in 20years) - valley/box gutters - 155ml/hour (1 in 100 years) Number of downpipes required -Size of downpipes (max.12m spacings)-Size of gutter (min 1:500 fall) 125D min.

CALCULATIONS

34m² catchment Downpipe

NOTES:

- 1. Connect downpipes to council stormwater system immediately on completion of roof installation
- 2. Roof sheeting to be crest fixed at side laps with (3) fixings at internal spans and (5) at end spans. Fixings to be RoofZips M6x65mm or equivalent
- denotes Edmonds Roof Valves or equivalent installed in accordance with Manuf. directions (max 900mm from ridge)
- denotes 'Smoothline' Roof Ventilators or equivalent installed in accordance with Manuf. directions - in conjunction with eave ventilators (refer Sh A7a)

Date	Rev.	Description	Drawn By	SITE DESCRIPTI
19/06/2025	Α	Issued for Council Approval	D. Jackson	WIND CLASS
28/10/2025	B Issued for RFI		D. Jackson	SOIL CLASS
26/11/2025	С	Issued for RFI	D. Jackson	CLIMATE ZONE
04/12/2025	2025 D Issued for RFI		D. Jackson	ENERGY RATING
				11166 12791

IND CLASS - AS4055 OIL CLASS

SITE DESCRIPTION

- AS2870

 refer report - Lot 107 966m² **ARCHIBIM**

ARCHITECTURAL BUILDING INVENTORY MODELLING

ABN: 34 625 657 785

Unit 1, 10 Stanton Place, Cambridge TAS 7170 Email: archibim@outlook.com.au



Client: J. WOOLLEY & H. STEWART Project: 214 TRANMERE ROAD, TRANMERE

Title: Roof / Stormwater Plan

1:100 Scale:

Drawn : D. Jackson Designed : D. Jackson 13/05/2025 Checked by: R.JACKSON CC340Y JOB NUMBER: 130725 REVISION: D H01

SOLID WASTE MATERIAL TO BE STORED AND REMOVED FROM SITE REGULARLY.

REMOVABLE WC TO BE INSTALLED ON SITE DURING CONSTURCTION UPTO THE POINT WHERE MAIN SEWER LINE IS CONNECTED.

STOCK PILES TO BE STABILISED AS SHOWN ON DETAIL SD9.

VEHICLES/MACHINERY ACCESSING THE SITE TO USE HARDENED ACCESS POINT AND TO BE THOROUGHLY WASHED (HIGH PRESSURE) TO REMOVE SOIL AND PLANT MATERIAL BEFORE LEAVING SITE.


REMOVE ANY SOIL, CONCRETE, PAINT OR OTHER POTENTIAL POLLUTANTS FROM ANY AREA NOT WITHIN THE SITE BOUNDARY, TO MINIMISE POLLUTION THROUGH RUN OFF IN THE RETICULATED STORMWATER SYSTEM.

RETICULATED WATER MAINS AND ELECTRICAL CONNECTION TRENCHED TOGETHER. NOTES AS PER SEWER AND STORMWATER TRENCHING ABOVE.

WATER DIVERSION BARRIER (DIVERSION OF UPSLOPE WATER) CONSTRUCTED FROM SAND OR GRAVEL FILLED BAGS IN ACCORDANCE WITH DRAWING SD1.

SILT TRAP/STORM WATER PIT PROVIDE FILTRATION BARRIER AS PER DETAIL SD10.

IT IS THE BUILDERS RESPONSIBILITY
TO VERIFY THE LOCATION OF ALL
UNDERGROUND SERVICES,
INCLUDING BUT NOT LIMITED TO;
GAS, WATER, SEWER, STORM WATER,
ELECTRICITY, TELECOMMUNICATIONS.

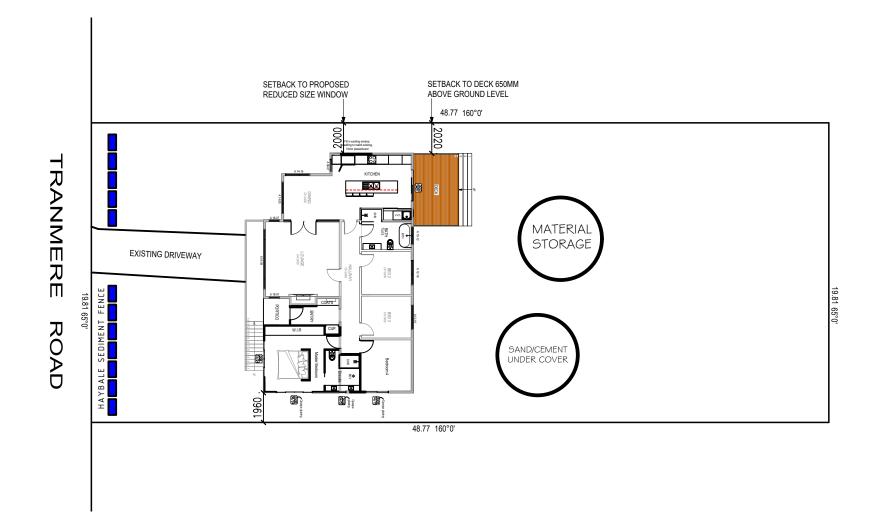

REVEGITATION & LONG TERM EROSION CONTROLS:

ONLY REMOVE VEGETATION AS REQUIRED DURING CONSTRUCTION. TREAT HEAVILY CLAYED SOILS WITH GYPSUM OR LIME AT A RATE OF 10t/ha TO STABILISE CLAY PARTICLES. TEMPORARY STABILISATION CAN BE GAINED BY SOWING RYECORN/OATS AT 40kg/ha AND RYEGRASS var. CONCORDE AT 10kg/ha OR SIMILAR FAST ROOTING GRASSES/CROPS (WITH ADVICE FROM AGRONOMIST) TO HOLD TOGETHER TOP SOIL. PERMANENT GROUND STABILISATION CAN BE ACHIEVED USING TURF OR OTHER GRASS MIXES OF FINE LEAF RYES, FESCUSES, POA, CLOVERS, ETC. GARDEN AREAS TO BE MULCHED WITH WATER EFFICIENT PLANTINGS THAT HAVE QUICK ESTABLISHMENT TIMES TO BE USED IN INITIAL GARDEN BEDS.

WHERE TUNNEL EROSION IS EVIDENT
THE TUNNELED AREA MUST BE COMPLETELY
BROKEN UP AND RECONSOLIDATED TO
INTERRUPT CHANNELED FLOWS OF WATER
AND THEN STABILISED WITH VEGETATION.
DEEP RIP ACROSS THE SLOPE MAKING SURE
THAT THESE RIP LINES ARE DEEPER THAN THE
BOTTOM OF THE TUNNELS.
COMPACT USING RUBBER WHEELED TRACTOR
ON AREAS OF SHALLOW TUNNELING. TUNNELS
DEEPER THAN THE RIPPERS ARE BEST
EXCAVATED AND REPACKED.

Date	Rev.	Description	Drawn By	SITE DESCRIPTION
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26/11/2025	С	Issued for RFI	D. Jackson	CLIMATE ZONE -
04/12/2025	D	Issued for RFI	D. Jackson	ENERGY RATING -
				11166 12791

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ARCHITECTURAL BUILDING INVENTORY MODELLING

ABN: 34 625 657 785

- AS4055

- AS2870

- refer report

- Lot 107 966m²

- 7


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Client:	J. WOOLLEY & H. STEWART
Project:	214 TRANMERE ROAD, TRANMERE

Title: SWMP 1 Scale: 1:250

Drawn : Designed :		Date : Date:	13/05/2025 01/05/2025	Checked by: R.JACKSON CC340Y
JOB NUMBER	R: 130725	Drawing:	M01	REVISION: D



Construction Notes

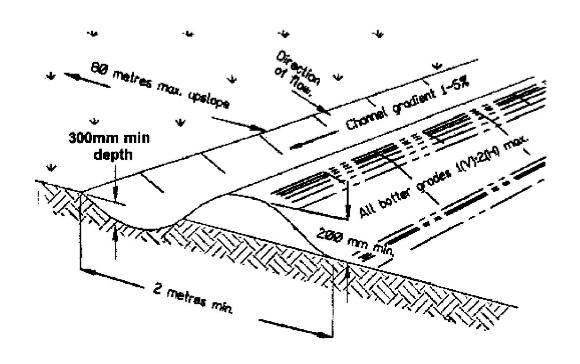- 1. Construct along gradient as specified.
- Maximum specing between banks shall be 80 metres.
- 3. Oreins to be of parabolic or trapezoidal cross section not V-shaped.
- Earth banks to be adequately compacted in order to prevent failure.
- Construction is of a temporary nature and shall be completed at the end a days work or immediately prior to rain.
- 6. All outlets from disturbed lands are to feed into a sediment basin or similar.
- Discharge runoff collected from undisturbed lands onto either a stabilised or an undisturbed disposal site within the same subcatchment area from which the water originated.
- Compect with a suitable implement in situations where they are required to function for more than five days.
- 9. Earth banks to be free of projections or other irregularities that will impede normal flow.

SD 1 - Diversion of Upslope Water - CatchDrains

DETAILS EXTRACTED FROM "GUIDELINES FOR SOIL AND WATER MANAGEMENT" BY THE DEPARTMENT OF PRIMARY INDUSTRIES WATER AND ENVIRONMENT - JUNE 1999 ENDORSED BY BRIGHTON, CLARENCE, GLENORCHY, HOBART AND KINGBOROUGH CITY AND MUNICIPAL COUNCILS.

Date	Rev.	Description	Drawn By	SITE DESCRIPTION
19/06/2025	Α	Issued for Council Approval	D. Jackson	WIND CLASS -
28/10/2025	В	Issued for RFI	D. Jackson	SOIL CLASS -
26/11/2025	С	Issued for RFI	D. Jackson	CLIMATE ZONE -
04/12/2025	D	Issued for RFI	D. Jackson	ENERGY RATING - TITLE 12491 -

ARCHIBIM

ARCHITECTURAL BUILDING INVENTORY MODELLING

ABN: 34 625 657 785

- AS4055

- AS2870

- refer report

- Lot 107 966m²

- 7

Unit 1, 10 Stanton Place, Cambridge TAS 7170 Email: archibim@outlook.com.au



Client: J. WOOLLEY & H. STEWART


Project: 214 TRANMERE ROAD, TRANMERE

Title: SWMP 2 Scale: NTS


 Drawn : D. Jackson Designed : D. Jackson
 Date : 13/05/2025 Date: 01/05/2025
 Checked by: R.JACKSON CC340Y

 JOB NUMBER: 130725
 Drawing : M02
 REVISION: D


WHEN EXCAVATING TRENCH ...

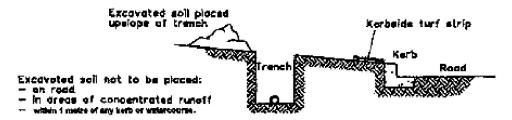

WHEN BACKFILLING TRENCH ...

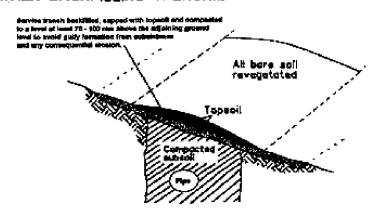

ON STEEP AND/OR LONG SECTIONS OF TRENCH ...

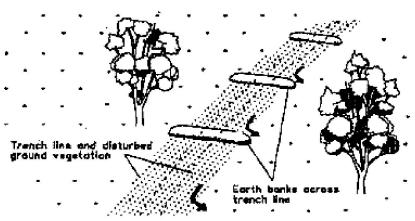

Construction Notes


- 1. Do not open any trench unless it is likely to be closed in three days.
- 2. Place excavated material upslope of trench.
- Stockpile topsoil separately from subsoil.
- 4. Divert runoff from the line of the cut
- 5. Rehabilitate in accordance with specification.

SD 3 - Service Installation

- AS4055

- AS2870

- 7

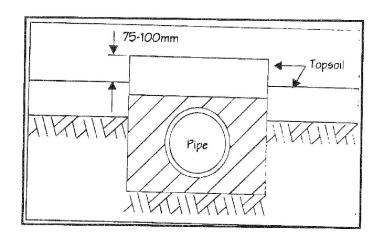

[See Appendix B - Standard Drawing SD 3 for installation and construction details]

DETAILS EXTRACTED FROM "GUIDELINES FOR SOIL AND WATER MANAGEMENT" BY THE DEPARTMENT OF PRIMARY INDUSTRIES WATER AND ENVIRONMENT - JUNE 1999 ENDORSED BY BRIGHTON, CLARENCE, GLENORCHY, HOBART AND KINGBOROUGH CITY AND MUNICIPAL COUNCILS.

Scale:

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26/11/2025	С	Issued for RFI	D. Jackson	CLIMATE ZONE -
04/12/2025	D	Issued for RFI	D. Jackson	ENERGY RATING -

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ARCHITECTURAL BUILDING INVENTORY MODELLING

ABN: 34 625 657 785 Unit 1, 10 Stanton Place

- refer report
- Lot 107 966m² Unit 1, 10 Stanton Place, Cambridge TAS 7170
- Email: archibim@outlook.com.au

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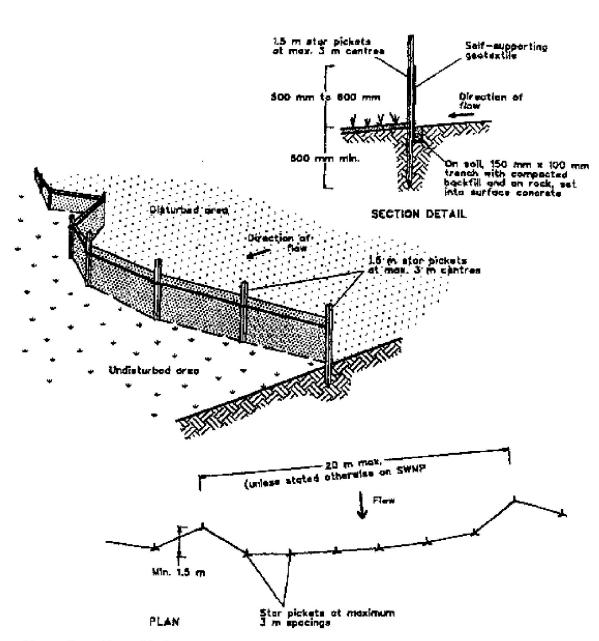
Client: J. WOOLLEY & H. STEWART	Client:	J. WOOLLEY & H. STEWART
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NTS

Project: 214 TRANMERE ROAD, TRANMERE Title: SWMP 3

 Drawn : D. Jackson Designed : D. Jackson
 Date : 13/05/2025 Date: 01/05/2025
 Checked by: R.JACKSON CC340Y


 JOB NUMBER: 130725
 Drawing : M03
 REVISION: D



Construction Notes

- 1. Construct sediment fence as close as possible to parallel to the contours of the alte.
- 2, Drive 1.5 metre long star pickets into ground, 3 metres apart.
- Dig a 150 mm deep trench along the upslope line of the fence for the bottom of the fabric to be entrenched.
- 4. Backfill trench over base of fabric.
- Fix self-supporting geotextile to upslope side of posts with wire ties or as recommended by geotextile manufacturer.
- Join sections of fabric at a support post with a 150 mm overlap.

SD 8 - SEDIMENT FENCE

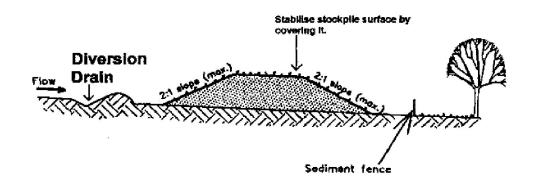

Construction Notes

- Construct a diversion drain on upslope side of stockpile to divert water around stockpile and install a sediment fence 1-2 metres downslope of stockpile.
- Locate stockpile at least 5 metres from existing bushland, concentrated water flows roads and other hazard areas.
- 3. Construct stockpile on the contour as a low, flat , elongated mound.
- 4. Where there is sufficient space, topsoil stockpiles shall be less than 2 metres high.
- 5. Rehabilitate in accordance with the SWMP.

SD 9 - Stabilising Stockpiles

DETAILS EXTRACTED FROM "GUIDELINES FOR SOIL AND WATER MANAGEMENT" BY THE DEPARTMENT OF PRIMARY INDUSTRIES WATER AND ENVIRONMENT - JUNE 1999 ENDORSED BY BRIGHTON, CLARENCE, GLENORCHY, HOBART AND KINGBOROUGH CITY AND MUNICIPAL COUNCILS.

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28/10/2025	В	Issued for RFI	D. Jackson	SOIL CLASS - AS2870	
26/11/2025	С	Issued for RFI	D. Jackson	CLIMATE ZONE - 7	
04/12/2025	D	Issued for RFI	D. Jackson	ENERGY RATING - refer report TITLE 12491 - Lot 107 966m	2
				111LL 12431 - LOC 107 300111	

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ARCHITECTURAL BUILDING INVENTORY MODELLING

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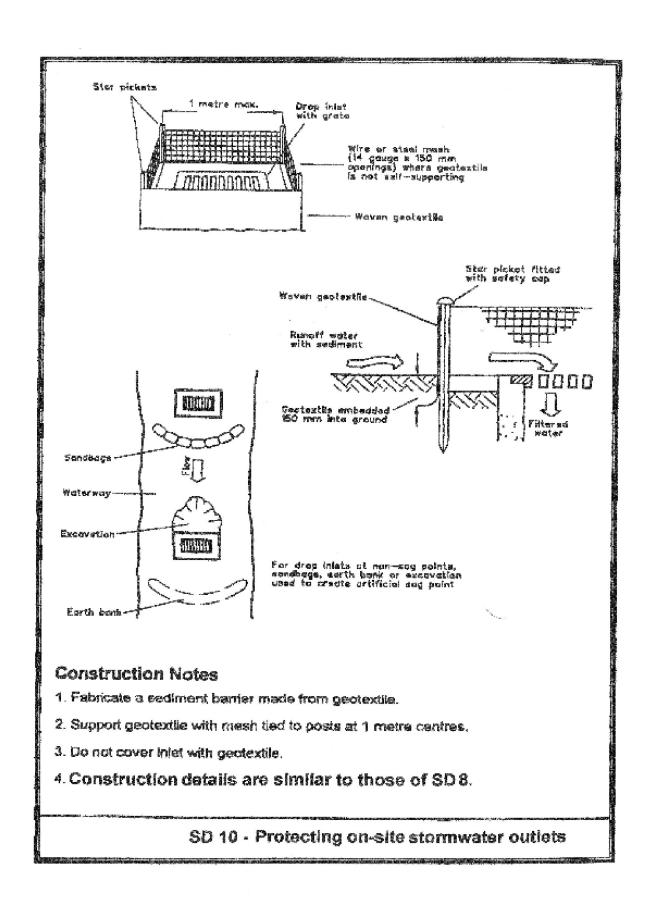


Client:	J. WOOLLEY & H. STEWART
Duoiset	214 TO ANMEDE DOAD TOAN

Project: 214 TRANMERE ROAD, TRANMERE Title: SWMP 4

Scale: SWMP of Strates

Drawn :	D. Jackson	Date :	13/05/2025	Checked by: R.JACKSON CC340Y
Designed :	D. Jackson	Date:	01/05/2025	
JOB NUMBE	R: 130725	Drawing:	M04	REVISION: D



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26/11/2025	С	Issued for RFI	D. Jackson	CLIMATE ZONE	- 7
04/12/2025	D	Issued for RFI	D. Jackson	ENERGY RATING	refer reportLot 107 966n
				7 IIILL IATUL	- LUC TU/ JUUII

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ARCHITECTURAL BUILDING INVENTORY MODELLING

ABN: 34 625 657 785

refer report
 Lot 107 966m²
 Unit 1, 10 Stanton Place, Cambridge TAS 7170
 Email: archibim@outlook.com.au



Client:	J. WOOLLEY & H. STEWART
l	24 4 TD 4 NIMEDE DO 4 D TD 4 NI

Project: 214 TRANMERE ROAD, TRANMERE

Title: SWMP 5 Scale: NTS

 Drawn : D. Jackson
 Date : 13/05/2025
 Checked by: R.JACKSON CC340Y

 JOB NUMBER: 130725
 Drawing : M05
 REVISION: D