

DEVELOPMENT APPLICATION PDPLANPMTD-2025/057425

PROPOSAL: Dwelling

LOCATION: 124 Athena Drive, Risdon Vale

RELEVANT PLANNING SCHEME: Tasmanian Planning Scheme - Clarence

ADVERTISING EXPIRY DATE: 05 January 2026

The relevant plans and documents can be inspected at the Council offices, 38 Bligh Street, Rosny Park, during normal office hours until 05 January 2026. In addition to legislative requirements, plans and documents can also be viewed at www.ccc.tas.gov.au during these times.

Any person may make representations about the application to the Chief Executive Officer, by writing to PO Box 96, Rosny Park, 7018 or by electronic mail to clarence@ccc.tas.gov.au. Representations must be received by Council on or before 05 January 2026.

To enable Council to contact you if necessary, would you please also include a day time contact number in any correspondence you may forward.

Any personal information submitted is covered by Council's privacy policy, available at www.ccc.tas.gov.au or at the Council offices.

Document Set ID: 5766413 Version: 1, Version Date: 08/12/2025

Clarence City Council



APPLICATION FOR DEVELOPMENT / USE OR SUBDIVISION

The personal information on this form is required by Council for the development of land under the Land Use Planning and Approvals Act 1993. We will only use your personal information for this and other related purposes. If this information is not provided, we may not be able to deal with this matter. You may access and/or amend your personal information at any time. How we use this information is explained in our **Privacy Policy**, which is available at www.ccc.tas.gov.au or at Council offices.

Proposal:	New residential dwelling	
Location:	124 Athena Drive	
	Suburb/Town Risdon Vale P	ostcode 7016
Current Owners/s:		
Applicant:		
Tax Invoice for		
Tax Invoice for application fees to be in the name of: (if different from		
applicant)		

(if yes, we recommend you discuss your proposal with Heritage Tasmania prior to lodgement as exemptions may apply which may save you time on your proposal)

	If you had pre-application discussions with a Council Officer, please give their name		
	Current Use of Site: Vacant		
	Does the proposal involve land administered or owned by the Crown or Council?		
Declaration:	I have read the Certificate of Title and Schedule of Easements for the land and am satisfied that this application is not prevented by any restrictions, easements or covenants. I authorise the provision of a copy of any documents relating to this application to any person for the purposes of assessment or public consultation. I agree to arrange for the permission of the copyright owner of any part of this application to be obtained. I have arranged permission for Council's representatives to enter the land to assess this application I declare that, in accordance with Section 52 of the Land Use Planning and Approvals Act 1993, that I have notified the owner of the intention to make this application. Where the subject property is owned or controlled by Council or the Crown, their signed consent is attached. Where the application is submitted under Section 43A, the owner's consent is attached. I declare that the information in this declaration is true and correct.		
Acknowledgement	I acknowledge that the documentation submitted in support of my application will become a public record held by Council and may be reproduced by Council in both electronic and hard copy format in order to facilitate the assessment process; for display purposes during public consultation; and to fulfil its statutory obligations. I further acknowledge that following determination of my application, Council will store documentation relating to my application in electronic format only.		
Applicant's Signature:			

PLEASE REFER TO THE DEVELOPMENT/USE AND SUBDIVISION CHECKLIST ON THE FOLLOWING PAGES TO DETERMINE WHAT DOCUMENTATION MUST BE SUBMITTED WITH YOUR APPLICATION.

Clarence City Council



DEVELOPMENT/USE OR SUBDIVISION CHECKLIST

Documentation required:

1. MANDATORY DOCUMENTATION

This information is required for the application to be valid. An application lodged without these items is unable to proceed.
Details of the location of the proposed use or development.
A copy of the current Certificate of Title, Sealed Plan, Plan or Diagram and Schedule of Easements and other restrictions for each parcel of land on which the use or development is proposed.
Full description of the proposed use or development.
Description of the proposed operation. May include where appropriate: staff/student/customer numbers; operating hours; truck movements; and loading/unloading requirements; waste generation and disposal; equipment used; pollution, including noise, fumes, smoke or vibration and mitigation/management measures.
Declaration the owner has been notified if the applicant is not the owner.
Crown or Council consent (if publically-owned land).
Any reports, plans or other information required by the relevant zone or code.
Fees prescribed by the Council.
Application fees (please phone 03 6217 9550 to determine what fees apply). An invoice will be emailed
upon lodgement.

2. ADDITIONAL DOCUMENTATION

In addition to the mandatory information required above, Council may, to enable it to consider an application, request further information it considers necessary to ensure that the proposed use or development will comply with any relevant standards and purpose statements in the zone, codes or specific area plan, applicable to the use or development.

□ Site analysis plan and site plan, including where relevant:

- Existing and proposed use(s) on site.
- Boundaries and dimensions of the site.
- Topography, including contours showing AHD levels and major site features.
- Natural drainage lines, watercourses and wetlands on or adjacent to the site.
- Soil type.
- Vegetation types and distribution, and trees and vegetation to be removed.
- Location and capacity of any existing services or easements on/to the site.
- Existing pedestrian and vehicle access to the site.
- Location of existing and proposed buildings on the site.
- Location of existing adjoining properties, adjacent buildings and their uses.
- Any natural hazards that may affect use or development on the site.
- Proposed roads, driveways, car parking areas and footpaths within the site.
- Any proposed open space, communal space, or facilities on the site.
- Main utility service connection points and easements.
- Proposed subdivision lot boundaries.

Clarence City Council DEVELOPMENT/USE OR SUBDIVISION CHECKLIST



Where it is proposed to erect buildings, **detailed plan**s with dimensions at a scale of 1:100 or 1:200 showing:

- Internal layout of each building on the site.
- Private open space for each dwelling.
- External storage spaces.
- Car parking space location and layout.
- Major elevations of every building to be erected.
- Shadow diagrams of the proposed buildings and adjacent structures demonstrating the extent of shading of adjacent private open spaces and external windows of buildings on adjacent sites.
- Relationship of the elevations to natural ground level, showing any proposed cut or fill.
- Materials and colours to be used on rooves and external walls.

☐ Where it is proposed to erect buildings, a plan of the proposed **landscaping** showing:

- Planting concepts.
- Paving materials and drainage treatments and lighting for vehicle areas and footpaths.
- Plantings proposed for screening from adjacent sites or public places.

Any additional reports, plans or other information required by the relevant zone or code.

This list is not comprehensive for all possible situations. If you require further information about what may be required as part of your application documentation, please contact Council's Planning Officers on (03) 6217 9550 who will be pleased to assist.



RESULT OF SEARCH

RECORDER OF TITLES

Issued Pursuant to the Land Titles Act 1980



SEARCH OF TORRENS TITLE

VOLUME	FOLIO
185311	87
EDITION 2	DATE OF ISSUE 09-Oct-2025

SEARCH DATE : 04-Dec-2025 SEARCH TIME : 04.18 pm

DESCRIPTION OF LAND

City of CLARENCE

Lot 87 on Sealed Plan 185311

Derivation: Part of Lot 31801, 248A-1R-0P Gtd. to Fane Claude

Campbell Cox

Prior CT 181250/502

SCHEDULE 1

N280541 TRANSFER to LILY CONSTANCE CASTRISIOS and HAYDEN COSTELLO Registered 09-Oct-2025 at noon

SCHEDULE 2

Reservations and conditions in the Crown Grant if any SP185311 COVENANTS in Schedule of Easements SP185311 FENCING COVENANT in Schedule of Easements SP168081, SP172459, SP174507 & SP181250 COVENANTS in Schedule of Easements SP164707, SP168081, SP172459, SP174507 & SP181250 FENCING PROVISION in Schedule of Easements

E255112 AGREEMENT pursuant to Section 78 of the Land Use Planning and Approvals Act 1993 Registered 19-Aug-2021 at noon

E430662 MORTGAGE to Commonwealth Bank of Australia Registered 09-Oct-2025 at 12.01 pm

UNREGISTERED DEALINGS AND NOTATIONS

No unregistered dealings or other notations




FOLIO PLAN

ASSISTANT RECORDER OF TITLES

Tasmanian Government

Issued Pursuant to the Land Titles Act 1980

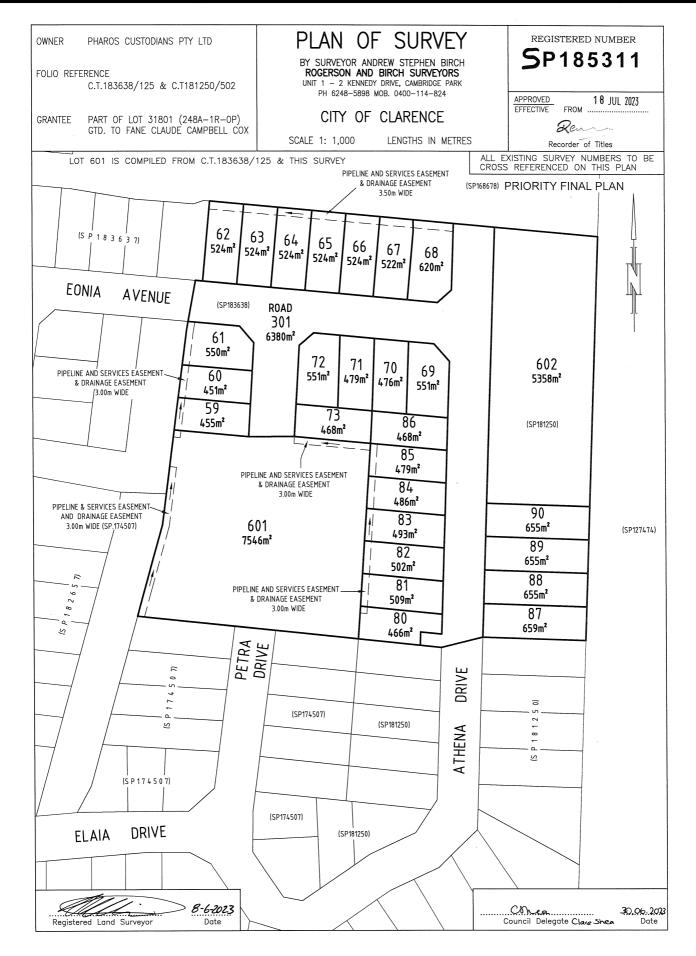

Search Date: 25 Sep 2025 Search Time: 11:48 AM Volume Number: 185311 Revision Number: 02 Page 1 of 3




FOLIO PLAN

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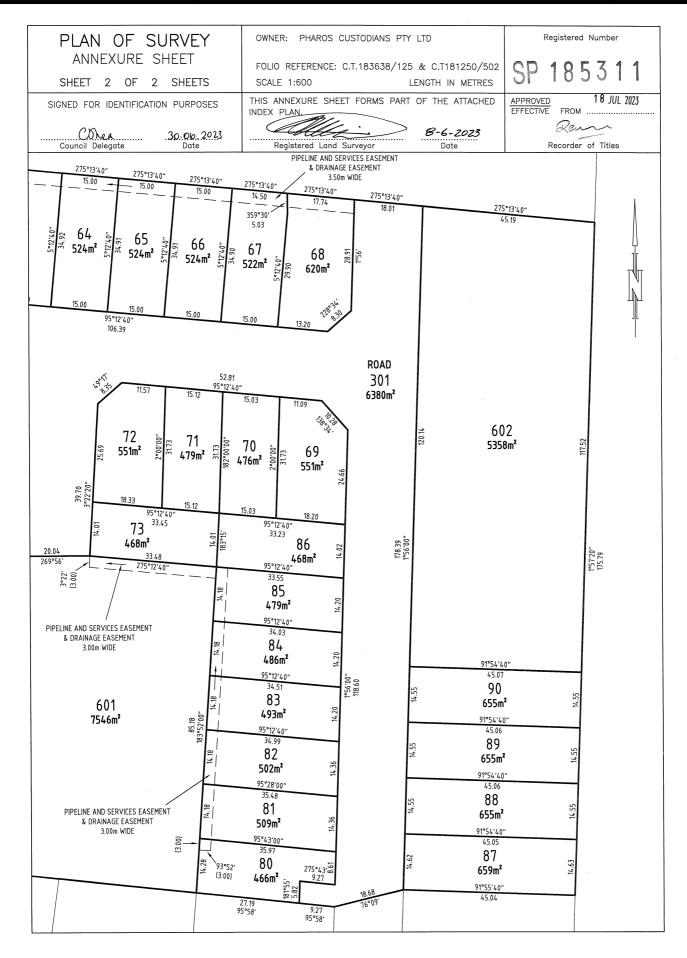


FOLIO PLAN

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ASSISTANT RECORDER OF TITLES
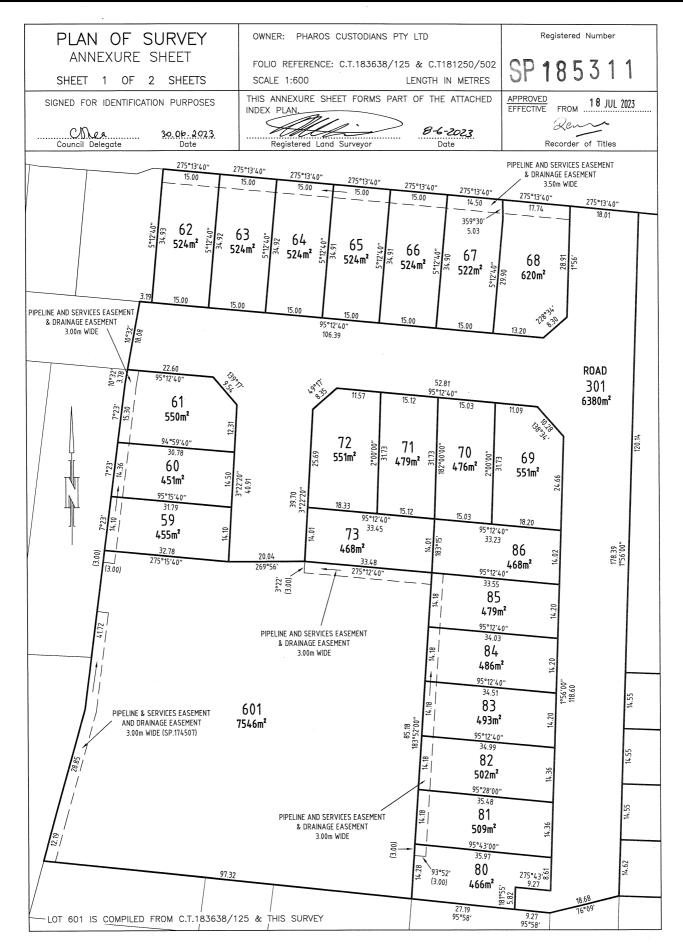
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SCHEDULE OF EASEMENTS

NOTE: THE SCHEDULE MUST BE SIGNED BY THE OWNERS

& MORTGAGEES OF THE LAND AFFECTED.

SIGNATURES MUST BE ATTESTED.

Registered Number

SP 185311

PAGE 1 OF 4 PAGE/S

EASEMENTS AND PROFITS

Each lot on the plan is together with:-

- (1) such rights of drainage over the drainage easements shown on the plan (if any) as may be necessary to drain the stormwater and other surplus water from such lot; and
- (2) any easements or profits a prendre described hereunder.

Each lot on the plan is subject to:-

- (1) such rights of drainage over the drainage easements shown on the plan (if any) as passing through such lot as may be necessary to drain the stormwater and other surplus water from any other lot on the plan; and
- (2) any easements or profits a prendre described hereunder.

The direction of the flow of water through the drainage easements shown on the plan is indicated by arrows.

Lots 59 to 61, 80 to 85 and Lot 601 (all inclusive) (the "Lots") are subject to a Pipeline and Services Easement in gross in favour of the Tasmanian Water and Sewerage Corporation Pty Ltd, it's successors and assigns (TasWater) over the land marked "Pipeline and Services Easement and Drainage Easement 3.00m wide on the Plan (the "Easement Land").

Lots 62 to 68 (all inclusive) (the "Lots") are subject to a Pipeline and Services Easement in gross in favour of the Tasmanian Water and Sewerage Corporation Pty Ltd, it's successors and assigns (TasWater) over the land marked "Pipeline and Services Easement and Drainage Easement 3.50m wide on the Plan (the "Easement Land").

Lots 59 to 61, 80 to 85 and Lot 601 (all inclusive) (the "Lots") are each subject to a Right of Drainage over the land marked "Pipeline and Services Easement and Drainage Easement 3.00m wide" in favour of the Clarence City Council.

Lots 62 to 68 (all inclusive) (the "Lots") are each subject to a Right of Drainage over the land marked "Pipeline and Services Easement and Drainage Easement 3.50m wide" in favour of the Clarence City Council.

Lot 601 is subject to a Right of Drainage over the land marked "Pipeline and Services Easement and Drainage Easement 3.00m wide" in favour of the Clarence City Council and more fully set forth in SP174507.

Lot 601 is subject to a Pipeline and Services Easement in gross in favour of the Tasmanian Water and Sewerage Corporation Pty Ltd, it's successors and assigns (TasWater) over the land marked "Pipeline and Services Easement and Drainage Easement 3.00m wide" (SP174507) and more fully set forth in SP174507.

(USE ANNEXURE PAGES FOR CONTINUATION)

SUBDIVIDER: Pharos Custodians Pty Ltd PLAN SEALED BY

FOLIO REF: 183638/125 and 181250/502

& REFERENCE: William Justo: WCJ 069028

PLAN SEALED BY: Clarence City Council

DATE: 30th June 2023. PDPLANPMID-2019/

REF NO. 008974 Stock & Council Delegate

NOTE: The Council Delegate must sign the Certificate for the purposes of identification.

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ASSISTANT RECORDER OF TITLES

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ANNEXURE TO SCHEDULE OF EASEMENTS

PAGE 2 OF 4 PAGES

Registered Number

185311

SUBDIVIDER: Pharos Custodians Pty Ltd

FOLIO REFERENCE: 183638/125 and 181250/502

Fencing Covenant

The owner of each Lot on the Plan covenants with the Vendors, Pharos Custodians Pty Ltd, that the Vendors shall not be required to fence.

Restrictive Covenants

& that part of Lot 301 formerly comprised in Lot 502 on Sealed Plan 181250

Lots 87, 88, 89, 90 and 602 are each subject to Restrictive Covenants more fully set forth in SP168081, SP172459, and SP174507, & SP181250

Lots 59-73 (inclusive) and Let-86 (inclusive) and Lot 601 are each subject to Restrictive Covenants more fully set forth in SP183638/ SP168081, SP172459 & SP174507

Definitions:

Pipeline and Services Easement is defined as follows:-

FIRSTLY, THE FULL RIGHT AND LIBERTY for TasWater and its employees, contractors, agents and all other persons duly authorised by it, at all times to:

- enter and remain upon the Easement Land with or without machinery, vehicles, plant and equipment; (1)
- investigate, take soil, rock and other samples, survey, open and break up and excavate the Easement Land (2)for any purpose or activity that TasWater is authorised to do or undertake;
- install, retain, operate, modify, relocate, maintain, inspect, cleanse, repair, remove and replace the (3)Infrastructure:
- run and pass sewage, water and electricity through and along the Infrastructure; (4)
- do all works reasonably required in connection with such activities or as may be authorised or required by any (5)law:
 - without doing unnecessary damage to the Easement Land; and (1)
 - leaving the Easement Land in a clean and tidy condition;

NOTE: Every annexed page must be signed by the parties to the dealing or where the party is a corporate body be signed by the persons who have attested the affixing of the seal of that body to the dealing.

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ASSISTANT RECORDER OF TITLES



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ANNEXURE TO SCHEDULE OF EASEMENTS

PAGE 3 OF 4 PAGES

Registered Number

SP 185311

SUBDIVIDER: Pharos Custodians Pty Ltd

FOLIO REFERENCE: 183638/125 and 181250/502

- (6) if the Easement Land is not directly accessible from a highway, then for the purpose of undertaking any of the preceding activities TasWater may with or without employees, contractors, agents and any other persons authorised by it, and with or without machinery, vehicles, plant and equipment enter the Lot from the highway at any vehicle entry and cross the Lot to the Easement Land; and
- (7) use the Easement Land as a right of carriageway for the purpose of undertaking any of the preceding purposes on other land, TasWater reinstating any damage that it causes in doing so to any boundary fence of the Lot.

SECONDLY, the benefit of a covenant in gross for TasWater with the registered proprietor/s of the Easement Land and their successors and assigns not to erect any building, or place any structures, objects, vegetation, or remove any thing that supports, protects or covers any Infrastructure on or in the Easement Land, without the prior written consent of TasWater to the intent that the burden of the covenant may run with and bind the servient land and every part thereof and that the benefit thereof may be annexed to the easement herein described.

Interpretation:

"Infrastructure" means infrastructure owned or for which TasWater is responsible and includes but is not limited to:

- (a) sewer pipes and water pipes and associated valves;
- (b) telemetry and monitoring devices;
- (c) inspection and access pits;
- (d) electricity assets and other conducting media (excluding telemetry and monitoring devices);
- (e) markers or signs indicating the location of the Easement Land or any other Infrastructure or any warnings or restrictions with respect to the Easement Land or any other Infrastructure;
- (f) anything reasonably required to support, protect or cover any other Infrastructure;
- (g) any other infrastructure whether of a similar nature or not to the preceding which is reasonably required for the piping of sewage or water, or the running of electricity, through the Easement Land or monitoring or managing that activity; and
- (h) where the context permits, any part of the Infrastructure.

NOTE: Every annexed page must be signed by the parties to the dealing or where the party is a corporate body be signed by the persons who have attested the affixing of the seal of that body to the dealing.

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ASSISTANT RECORDER OF TITLES



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ANNEXURE TO SCHEDULE OF EASEMENTS

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Registered Number

SP 185311

SUBDIVIDER: Pharos Custodians Pty Ltd

FOLIO REFERENCE: 183638/125 and 181250/502

"TasWater" means Tasmanian Water and Sewerage Corporation Pty Ltd (ACN 162 220 653), its successors and assigns

EXECUTED by Pharos Custodians Pty Ltd (ACN 131 759 807) in accordance with section 127 of the *Corporations Act 2001:*

Signature:

Name: ANTONIOS. PAPASTAMAT PLEASE PRINT

Director

Signature:

Vame: EUGENIA.....PAPASTIAMATION

Director/Secretary *
* Delete as appropriate

NOTE: Every annexed page must be signed by the parties to the dealing or where the party is a corporate body be signed by the persons who have attested the affixing of the seal of that body to the dealing.

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26.11.2025

Dear Sir/Madam.

124 Athena Dr, Risdon Vale - 7016

Please see our DA application for a new dwelling at 124 Athena Drive, Risdon Vale.

The proposal includes the construction of a retaining wall located within 300 mm of the side boundary. While this does not meet the Acceptable Solution under the Clarence Planning Scheme 2015 for boundary setbacks, it satisfies the relevant Performance Criteria, as outlined below.

1. **Not cause unreasonable loss of amenity** to the adjoining property through:

Overshadowing:

The retaining wall is low-height and does not generate any meaningful shadowing impact. Due to its modest scale and position relative to the sun path, overshadowing is negligible and will not reduce solar access to habitable rooms or private open space on the neighbouring lot.

Visual Bulk:

The wall remains low in overall height and does not present as a dominant feature when viewed from the adjoining lot. Given its height and materials, it will not create a sense of enclosure or bulk.

o Privacy:

A retaining wall does not introduce privacy impacts as it does not contain openings or elevated viewing positions.

2. Be compatible with the use and development of adjoining land:

Retaining walls are common in residential zones to manage level changes and enable safe, functional use of land. The proposed structure is consistent with standard residential development and will not impact the future development potential of the neighbouring property.

3. Allow for adequate separation for maintenance of the wall:

The retaining wall is engineered to be structurally sound without requiring access from the neighbouring property. All maintenance can be carried out from within the subject site, ensuring no reliance on the adjoining land for future works.

Unit 7, 3 Abernant Way, Cambridge, TAS 7170 P 03 6248 4218 E admin@pinnacledrafting.com.au pinnacledrafting.com.au pinnacledrafting.com.au

4. Not cause drainage or stormwater issues:

The retaining wall will incorporate appropriate drainage (e.g., gravel backfill, ag-drain) to ensure water does not concentrate or discharge onto the neighbouring lot. Stormwater will be directed to lawful points of discharge in accordance with council requirements.

The proposal includes a window with a floor level greater than 1.0 m above natural ground level. While this triggers the privacy provisions under the Clarence Planning Scheme 2015, the window complies with the Performance Criteria as it does not cause unreasonable overlooking of the neighbouring non-habitable room window (ensuite) which is also obscure glass.

1. Horizontal Separation Ensures No Unreasonable Overlooking

The subject window is located **1.5 metres horizontally** from the neighbour's window. Although this does not meet the Acceptable Solution of a 3 m setback to a shared boundary or screening, the development **meets the intent** of the Performance Criteria because:

- The two windows are not directly facing each other in a way that allows clear sightlines into the neighbour's habitable room.
- The 1.5 m horizontal offset disrupts direct lines of sight and prevents intrusive overlooking.

2. Window Orientation and Sightlines

The design has been carefully considered to:

- Limit outward views into the neighbour's window through offset positioning.
- Ensure that any view from the subject window is **angled rather than direct**, which significantly reduces privacy impacts.
- Maintain visual separation in accordance with the zone's purpose.

3. Internal Privacy vs External Privacy

The neighbouring window does not lose reasonable privacy because:


- Neither window provides a direct, perpendicular view into the other.
- There is no shared line of sight that would enable views into sensitive internal living spaces.
- The neighbouring ensuite window is obscure

4. No Need for Additional Screening

Due to the horizontal offset and broken sightline, screening is **not required** to achieve the objectives of the Performance Criteria.

The outcome is functionally equivalent to the acceptable solution in terms of privacy protection.

Should you have any questions in regards to the application, please feel free to contact us on
6248 4743 or by email at
Kind Regards,

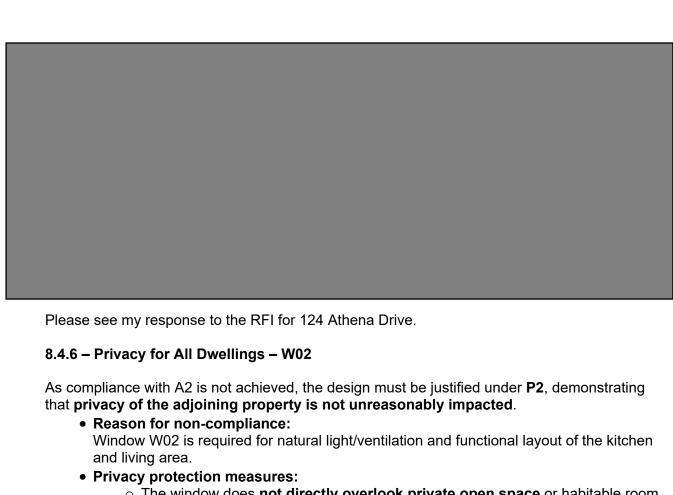

- The window does not directly overlook private open space or habitable room windows of the neighbouring dwelling; the closest window is an obscure glass window of the ensuite (screened and non-habitable room) and has a vertical separation of 1500mm.
- Any potential overlooking is oblique rather than direct;
- Separation of sight lines by fencing and vegetative buffers;
- Differences in floor levels and site topography reduce visibility into neighbouring areas. Natural ground level differences of the steep topography of the blocks, allows for the sight line of W02 to extend over the neighbouring lot rather than into any private open space or habitable room windows.
- Conclusion: Given the steep natural topography, absence of direct sightlines, and
 existing boundary treatments, the proposal maintains reasonable levels of privacy for
 occupants of adjoining dwellings and therefore complies with Performance Criterion P2.

Thank you

Kind regards,



Note: The images provided are artistic representations only and should not be used as references for final colours, finishes, or external/internal features.

124 Athena Drive, Risdon Vale - 7016

Owner(s) or Clients

Building Classification

Designer

Total Floor Area (Combined)

Alpine Area

Other Hazards

(e.g.. High wind, earthquake, flooding, landslip,

Hayden Costello & Lily Castrisios

Jason Nickerson CC6073Y

169.56m²

Deck 51.71m²

N/A

Airport obstacle limitation area, Bushfire-prone areas

Title Reference 185311/87 General Residential Zoning

Land Size

Design Wind Speed

Soil Classification

Climate Zone Corrosion Environment

N3 Low Bushfire Attack Level (BAL) TBA

659m²

A.06

A.07

Electrical Plan

Door & Window Schedule


ID **Sheet Name** Issue A.01 Site Plan DA - 01 A.02 Floor Plan DA - 01 DA - 01 A.03 Elevations A.04 Elevations DA - 01 A.05 Roof Plan DA - 01

DA - 01

DA - 01

Changes List Description of change Issue Date Designer

Document Set ID: 5766072 Version: 1, Version Date: 28/12/2025		
landfill, snow & ice, or other relevant factors)		
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Document Set ID: 5766079 Version: 1, Version Date: 06/12/2025

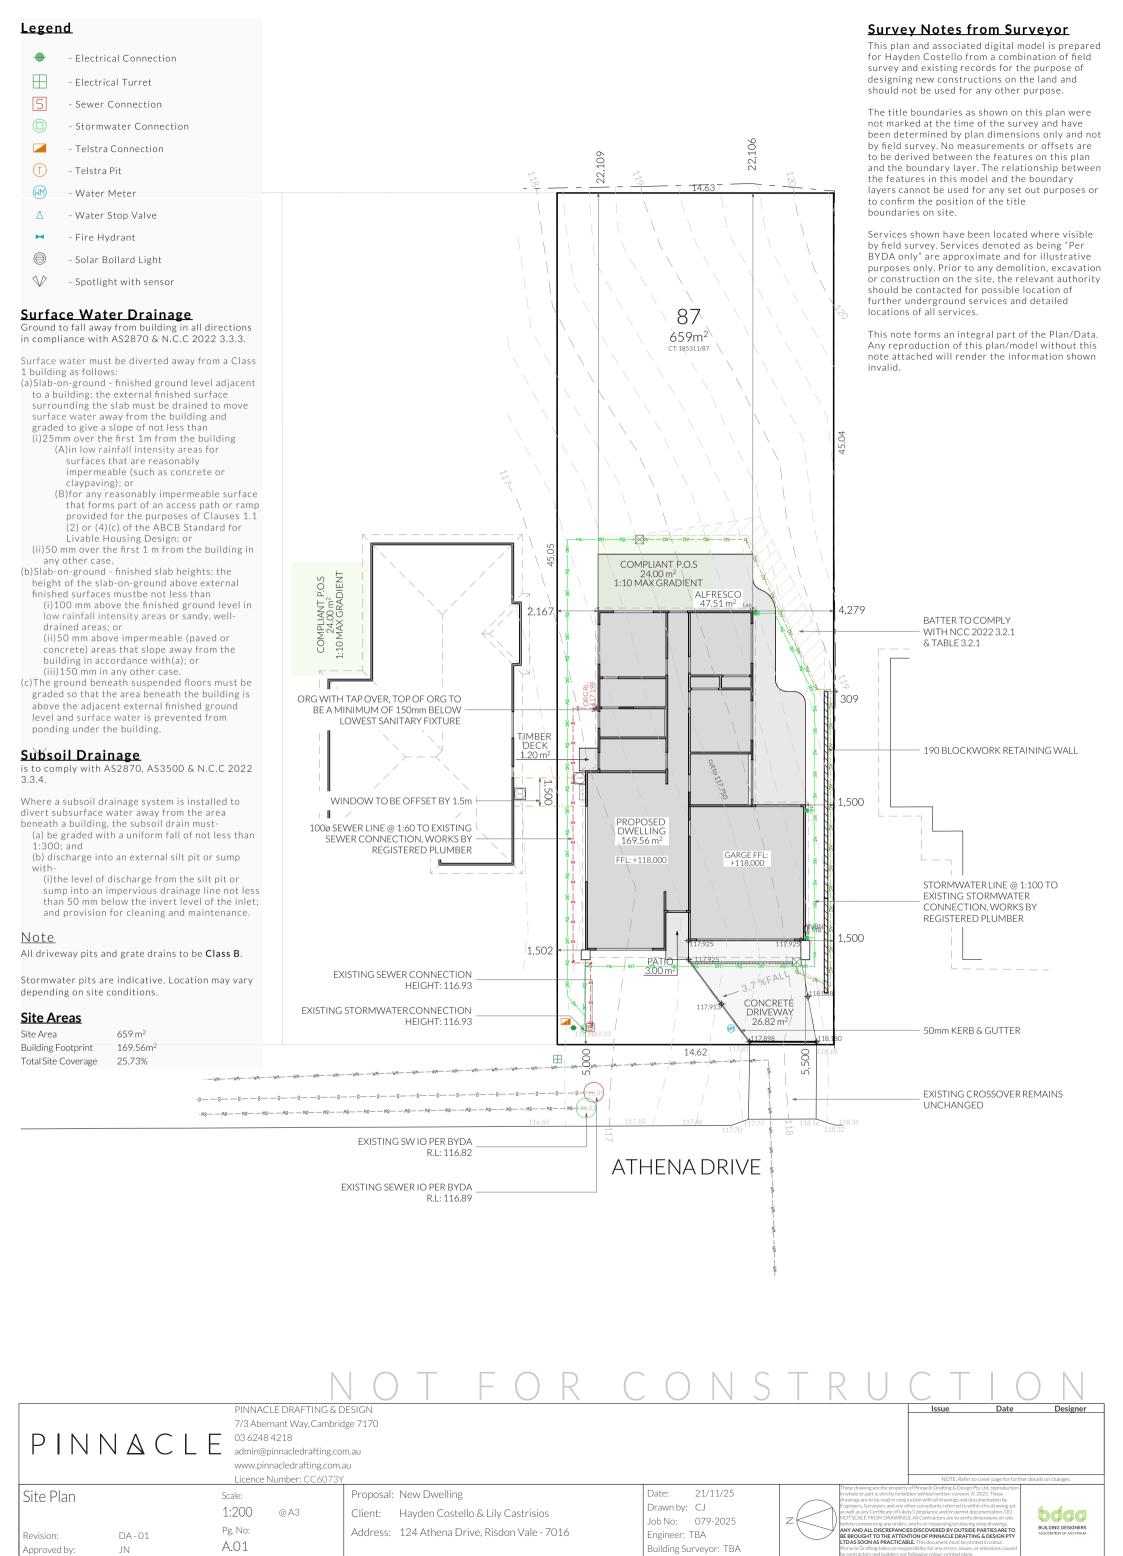

Articulation Joint

(SA) Smoke Alarm

Construction of sanitary compartments 10.4.2 of NCC 2022

The door to a fully enclosed sanitary compartment must -

- open outwards; or
- slide; or
- be readily removable from the outside of the compartment.

unless there is a clear space of at least 1.2 m, measured in accordance with Figure 10.4.2 of NCC 2022 Vol II, between the closet pan within the sanitary compartment and the doorway.

Note: Safe Movement & Egress

Openable windows greater than 4m above the surface below are to be fitted with a device to limit opening or a suitable screen so a 125mm sphere cannot pass through. Except for Bedrooms, where the requirement is for heights above 2m. Refer to clauses 11.3.7 and 11.3.8 of NCC 2022 for further information on suitable protective devices.

Note: Paved Areas

All paths and patios to fall away from dwelling.

Note: Stair Construction

All stairs to be constructed in accordance with NCC Vol II 2022 Part 11.2.2:

Riser: Min 115mm - Max 190mm Going: Min 240mm - Max 355mm

Slope (2R+G): Max 550 - Min 700

For stairways serving non-habitable room used infrequently, refer to table 11.2.2(b).

Landings to comply with Clause 11.2.5 and be a minimum of 750mm deep measured 500mm from the inside edge of the

Slip resistance of treads, nosings and ramps to comply with Clause 11.2.4.

Heights of rooms & other spaces 10.3.1 of NCC 2022

Heights of rooms and other spaces must not be less than; (a)in a habitable room excluding a kitchen - 2.4 m; and (b)in a kitchen - 2.1 m; and

(c)in a corridor, passageway or the like - 2.1 m; and (d)in a bathroom, shower room, laundry, sanitary compartment, airlock, pantry, storeroom, garage, car parking area or the like

(e)in a room or space with a sloping ceiling or projections below the ceiling line within- See NCC directly for these items (f)in a stairway, ramp, landing, or the like - 2.0 m measured vertically above the nosing line of stairway treads or the floor surface of a ramp, landing or the like.

If required onsite, the builder may work within the tolerances of the above as specified within the NCC 2022 Vol II. Builder to contact Pinnacle before undertaking works.

Floor Areas

<u>Total Floor Area</u>	<u>169.56m</u> ²
Patio	3.00m ²
Deck	1.20m ²
Alfesco	47.51m ²

Important Note

Compliant bracing for livable housing standards black dashed line represents location of reinforcement materials.



In accordance with the Livable Housing Provisions, acceptable options for reinforcement material include noggings with a minimum thickness of 25mm or structural grade plywood with a minimum thickness of 12mm.


Required reinforcement of bathroom and sanitary compartment in compliance with Livable Housing Design Standards 2022 Builder to refer to;


Shower - Figure 6.2c

Bath - Figure 6.2a freestanding is exempt under

6.1(1)(b)(ii)

Toilet - Figure 6.2e

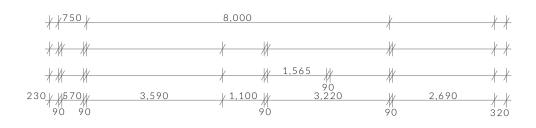

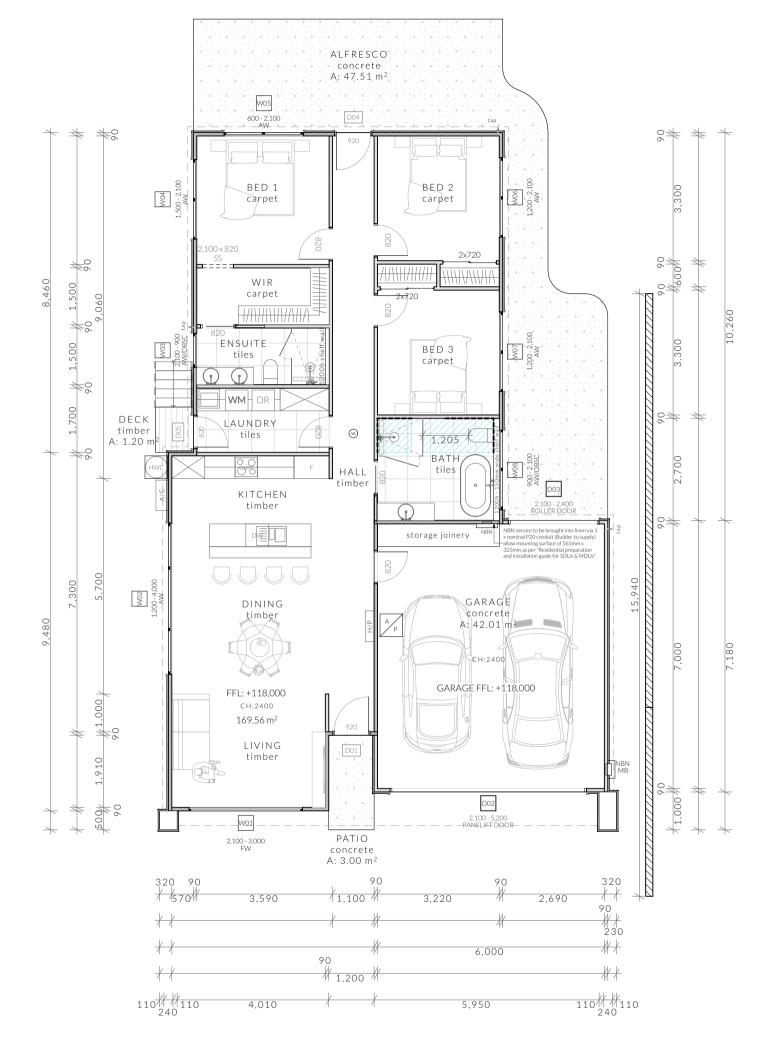

PINNACL

PINNACLE DRAFTING & DESIGN 7/3 Abernant Way, Cambridge 7170 03 6248 4218

admin@pinnacledrafting.com.au www.pinnacledrafting.com.au

Licence Number: CC6073

1:100 @ A3 Pg. No: A.02

Proposal: New Dwelling

Client: Hayden Costello & Lily Castrisios Address: 124 Athena Drive, Risdon Vale - 7016

21/11/25 Date: Drawn by: CJ Job No: 079-2025 Engineer: TBA

Building Surveyor: TBA


IY AND ALL DISCREPANCIES DISCOVERED BY OUTSIDE PARTIES ARE TO BROUGHT TO THE ATTENTION OF PINNACLE DRAFTING & DESIGN PTY BE BROUGHT TO THE ATTENTION TD AS SOON AS PRACTICABLE. T



JN Approved by: Document Set ID: 5766072 Version: 1, Version Date: 08/12/2025

DA-01

Floor Plan

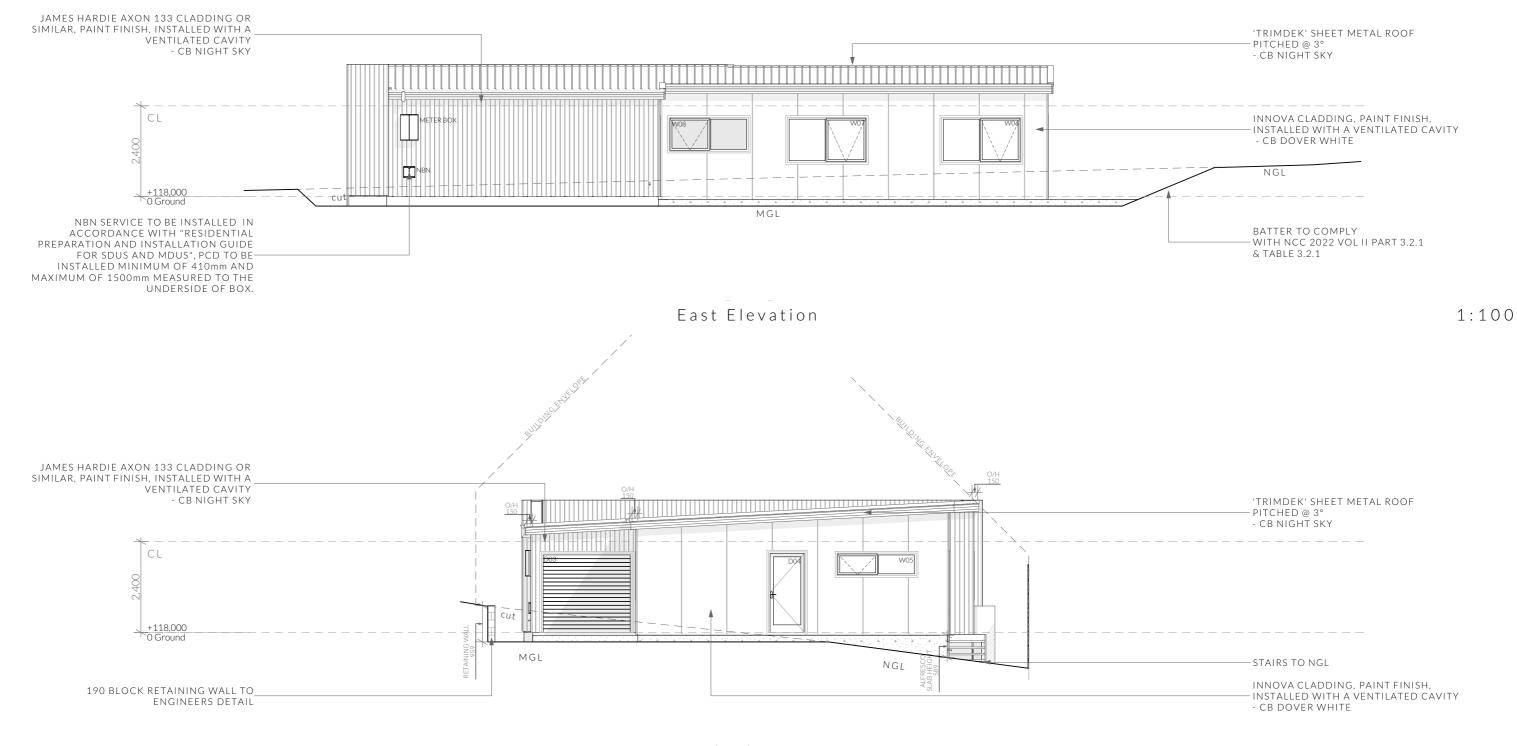

North Elevation

1:100

Clearances between cladding and ground shall comply with Clause 7.5.7 of the NCC 2022 and shall be a minimum clearance of:

100mm in low rainfall intensity areas or sandy, well-drained areas; or 50mm above impermeable areas that slope away from the building; or 150mm in any other case.

Wall cladding must extend a minimum of 50 mm below the bearer or lowest horizontal part of the suspended floor framing.

U.N.O in builders specifications or located in saline environments or if using a glazed finish brick, brickwork is to be installed in stretcher bond pattern with raked joints.

Openable windows greater than 4m above ground level are to be fitted with a device to limit the opening or a suitable screen so a 125mm sphere cannot pass through, and withstand a force of 250N. Except for bedrooms, where the requirement is for heights above 2m.

Riser: Min 115mm - Max 190mm Going: Min 240mm - Max 355mm PINNACLE DRAFTING & DESIGN 7/3 Abernant Way, Cambridge 7170 PINNACLE 03 6248 4218

All stairs to be constructed in accordance with NCC 2022 Vol II Part 11.2.2

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Slope (2R+G): Max 550 - Min 700 Elevations

Revision:

Approved by:

Scale: 1:100 @ A3 Pg. No: A.03

DA - 01

Proposal: New Dwelling Client: Hayden Costello & Lily Castrisios Address: 124 Athena Drive, Risdon Vale - 7016

Date: Drawn by: CJ Job No: 079-2025

Engineer: TBA Building Surveyor: TBA


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West Elevation 1:100

Clearances between cladding and ground shall comply with Clause 7.5.7 of the NCC 2022 and shall be a minimum clearance of:

100mm in low rainfall intensity areas or sandy, well-drained areas; or 50mm above impermeable areas that slope away from the building; or 150mm in any other case.

Wall cladding must extend a minimum of 50 mm below the bearer or lowest horizontal part of the suspended floor framing.

U.N.O in builders specifications or located in saline environments or if using a glazed finish brick, brickwork is to be installed in stretcher bond pattern with raked joints.

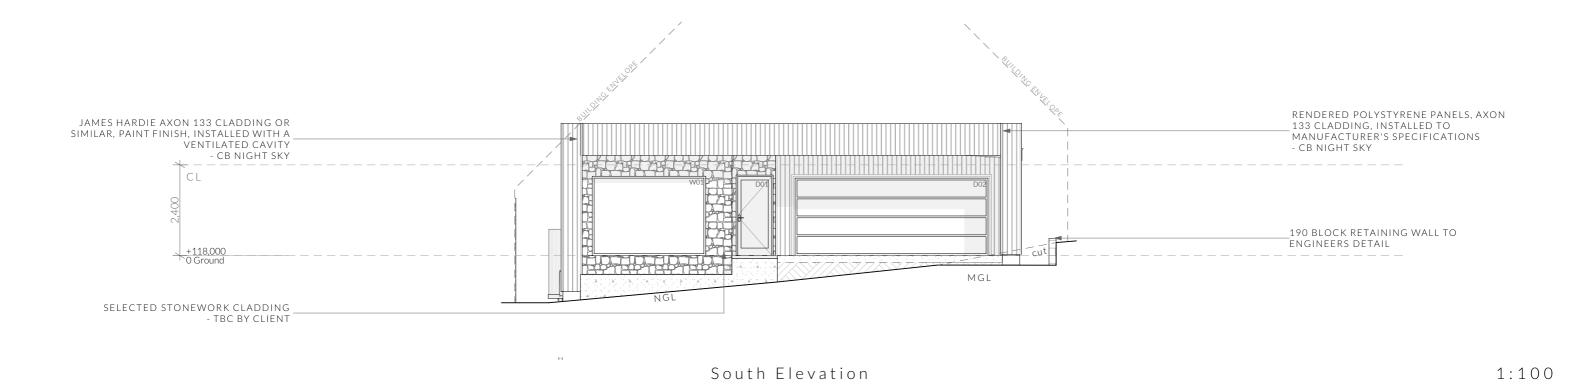Openable windows greater than 4m above ground level are to be fitted with a device to limit the opening or a suitable screen so a 125mm sphere cannot pass through, and withstand a force of 250N. Except for bedrooms, where the requirement is for heights above 2m.

All stairs to be constructed in accordance with NCC 2022 Vol II Part 11.2.2

Riser: Min 115mm - Max 190mm Going: Min 240mm - Max 355mm PINNACLE DRAFTING & DESIGN 7/3 Abernant Way, Cambridge 7170 03 6248 4218 PINNACLE

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Elevations Revision:

Approved by:

DA - 01

Slope (2R+G): Max 550 - Min 700

Scale: 1:100 @ A3 Pg. No: A.04

Proposal: New Dwelling Client: Hayden Costello & Lily Castrisios Address: 124 Athena Drive, Risdon Vale - 7016

Date: Drawn by: CJ Job No: 079-2025

Engineer: TBA Building Surveyor: TBA



Ventilation of roof spaces NCC 2022 Part 10.8.3

A roof must have a roof space that-

(a)is located-

(i)immediately above the primary insulation layer;

(ii)immediately above sarking with a vapour permeance of not less than 1.14 μg/N.s, which is immediately above the primary insulation layer; or

(iii)immediately above ceiling insulation; and (b)has a height of not less than 20 mm; and (c)is either-

(i)ventilated to outdoor air through evenly distributed openings in accordance with Table 10.8.3; or

(ii)located immediately underneath the roof tiles of an unsarked tiled roof.

Stormwater Notes

All gutters, downpipes and rain heads to be designed and installed in compliance with AS3500.3 & NCC 2022 Volume II Part 7.4.

Roofing Cladding

Roof cladding, flashings, cappings, roof sheeting and fixings are to be installed in accordance with NCC 2022 Volume II Part 7.2 for sheet roofing and Part 7.3 for tiled and shingle roofing.

Eaves & Soffit Linings

To comply with NCC 2022 Vol II Part 7.5.5 and where provided, external fibre-cement sheets and linings used as eaves and soffit linings must-


(a)comply with AS/NZS 2908.2 or ISO 8336; and (b)be fixed in accordance with Table 7.5.5 and Figure 7.5.5 using-

(i) 2.8×30 mm fibre-cement nails; or

(ii) No. 8 wafer head screws (for 4.5 mm and 6 mm sheets only); or

(iii) No. 8 self embedding head screws (for 6 mm sheets only)

Refer to table 7.5.5 for trimmer and fastener spacings.

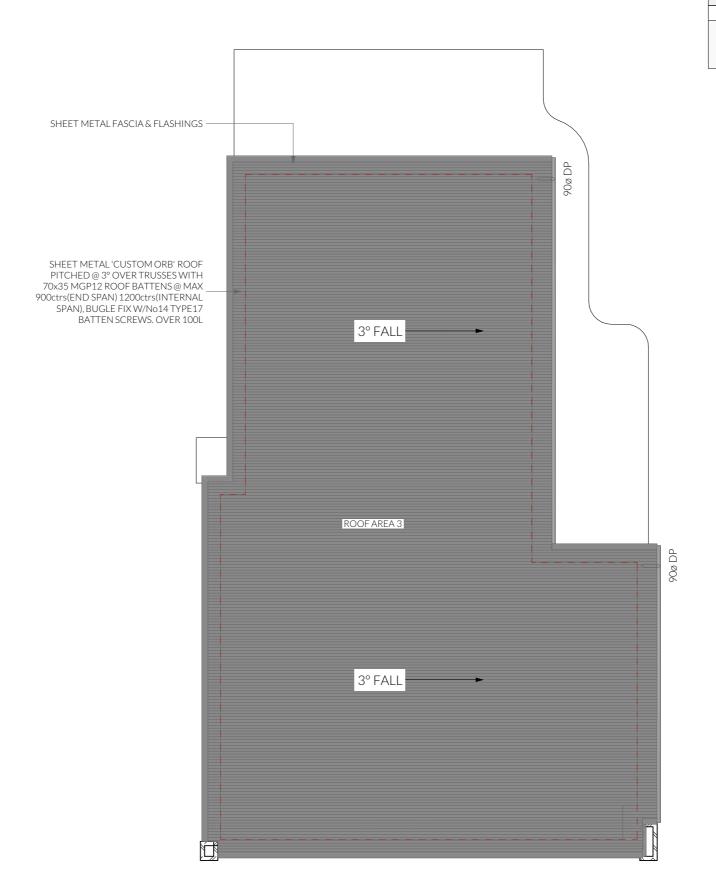

OOF PITCH	VENTILATION OF OPENINGS (TABLE 10.8.3)
<10°	25,000 mm2/m provided at each of two opposing ends

(1)Ventilation openings are specified as a minimum free open area per metre length of the longest horizontal dimension of the roof.

(2)For the purposes of this Table, high level openings are openings provided at the ridge or not more than 900 mm below the ridge or highest point of the roof space, measured vertically.

Parapet cappings

Where a wall cladding is used to form a parapet wall, the cladding must be attached to a supporting frame and have a capping installed that complies with the following:

(a) Cappings must-

- (i)be purpose made, machine-folded sheet metal or equivalent sections of a material compatible with all up and downstream metal roof covering materials in accordance with 7.2.2(2); and
- (ii)extend not less than 50 mm down the sides of the parapet;
- (iii)be separated from the supporting framing by a vapour permeable sarking installed in accordance with (f); and
- (iv)be fixed with either self drilling screws or rivets with rubber washers at intervals of not more than 500 mm that do not penetrate the top of cappings, except at joints and corners.
- (b)The top of the capping must slope a minimum of 5 degrees. (c)Joints in cappings must-
- (i)overlap by not less than 50 mm in the direction of flow; and (ii)be securely fastened at intervals of not more than 40 mm;
- (iii)have sealant installed between laps.
- (d)Fixing for cappings must be compatible with the capping material in accordance with 7.2.2.
- (e)Lead cappings must not be used with prepainted steel or zinc/aluminium steel or on any roof if the roof is part of a drinking water catchment area.
- (f)Sarking must comply with AS 4200.1 and be installed behind all wall cladding where parapets are installed, with-

(i)each adjoining sheet or roll being-

(A)overlapped not less than 150 mr (B)taped together; and

(B)taped together; and sarking fixed to supporting mm centres.

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Revision:

Approved by:

DA - 01 JN 1:100 @ A3 Pg. No: A.05

Scale:

Proposal: New Dwelling
Client: Hayden Costello & Lily Castrisios
Address: 124 Athena Drive, Risdon Vale - 7016

Date: 21/11/25

Drawn by: CJ

Job No: 079-2025

Engineer: TBA

Building Surveyor: TBA

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ELECTRICAL LEGEND - Lower Floor

Symbol	Description	Allowance	Quantity
1,100H ∇ □	DATA- CAT 6 (RJ45) - 1 GANG		2
1,100H Ӌ ™	DATA-TV CONNECTION		1
E	FAN - 3 IN 1 (2 LAMP)	10W (LIGHT)	1
	FAN - 3 IN 1 (4 LAMP)	10W (LIGHT)	1
0	FAN - CEILING - EXHAUST		2
1,800H	GPO - (1) SINGLE		2
2,400H CELLING MOUNTED	GPO - (1) SINGLE (CEILING MOUNTED)		1
300H	GPO - (2) DOUBLE		22
2 2	GPO - (2) DOUBLE (WITH COOKTOP ISOLATOR SWITCH)		1
300H W/PROOF	GPO - WEATHER PROOF DOUBLE		2
$\otimes_{_{R}}$	LIGHT - CEILING - DOWNLIGHT RECESSED	10W	21
	LIGHT - CEILING - LED BATTEN	20W	3
→	LIGHT - CEILING - PENDANT - LED STRIP 1200L	20W (LM)	1
$\overline{\bigotimes}_{W1}$	LIGHT - WALL MOUNTED - TYPE 1	10W	4
1	CAMITCH LICHTA CANIC		4.4

Smoke Alarms Part 9.5 of NCC 2022

Smoke alarms must-

(a) be located in-

(i)a Class 1a building in accordance with 9.5.2 and 9.5.4; and (ii) a Class 1b building in accordance with 9.5.3 and 9.5.4; and

(b)comply with AS 3786, except that in a Class 10a private garage where the use of the area is likely to result in smoke alarms causing spurious signals, any other alarm deemed suitable in accordance with AS 1670.1 may be installed provided that smoke alarms complying with AS 3786 are installed elsewhere in the Class 1 building; and

(c)be powered from the consumer mains source where a consumer mains source is supplied to the building; and be interconnected where there is more than one alarm.

In a Class 1a building, smoke alarms must be located in-

(a) any storey containing bedrooms, every corridor or hallway associated with a bedroom, or if there is no corridor or hallway, in an area between the bedrooms and the remainder of the building; and

(b) each other storey not containing bedrooms.

Smoke alarms required by 9.5.2 and 9.5.3 must be installed on or near the ceiling, in accordance with the following:

(a) Where a smoke alarm is located on the ceiling it must be-

(i)a minimum of 300 mm away from the corner junction of the wall and ceiling; and (ii)between 500 mm and 1500 mm away from the high point and apexes of the ceiling, if the room has a sloping ceiling.

(b)Where (a) is not possible, the smoke alarm may be installed on the wall, and located a minimum of 300 mm and a maximum of 500 mm off the ceiling at the junction with the

Note: Exhaust Fans

Exhaust fans to comply with NCC 2022 Vol 2 Part 10.8.2 and have;

-An exhaust system installed in a kitchen, bathroom, sanitary compartment or laundry must have a minimum flow rate of-

(a)25 L/s for a bathroom or sanitary compartment; and

(b)40 L/s for a kitchen or laundry.

-Exhaust from a kitchen, kitchen range hood, bathroom, sanitary compartment or laundry must discharge directly or via a shaft or duct to outdoor air.

-Where a venting clothes dryer is installed, it must discharge directly or via a shaft or duct to outdoor air.

-An exhaust system that is not run continuously and is serving a bathroom or sanitary compartment that is not ventilated in accordance with 10.6.2(a) must-

(a) be interlocked with the room's light switch; and

(b)include a run-on timer so that the exhaust system continues to operate for 10 minutes after the light switch is turned off.

Note: Lighting

Lighting layout may change, owner to confirm with builder prior to purchase/installation of exact quantity and location of electrical services provided that installation is compliant with AS3000 and artificial lighting allowances do not exceed:

5W/m² in class 1a dwellings


4W/m² to veranda, balcony or the like

3W/m² in a class 10a dwelling associated with the class 1a dwelling

U.N.O - All downlights are to be Insulation Contact (IC) rated.

Preparation for future Solar Installation:

Should the solar design be required for future installation, 2/25mm solarflex (or similar) conduits marked "solar" are to be installed from the meter box to the roof space.

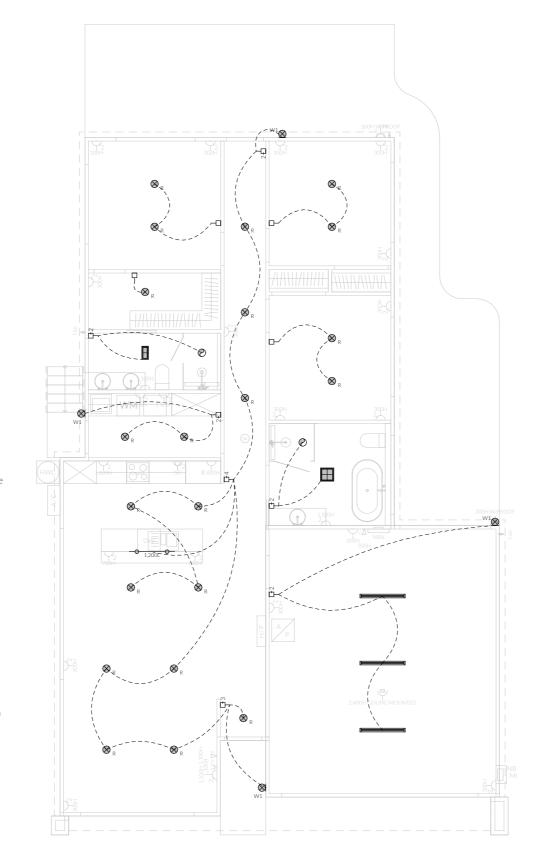

<u>Notes</u> U.N.O ceilings are to be plasterboard.

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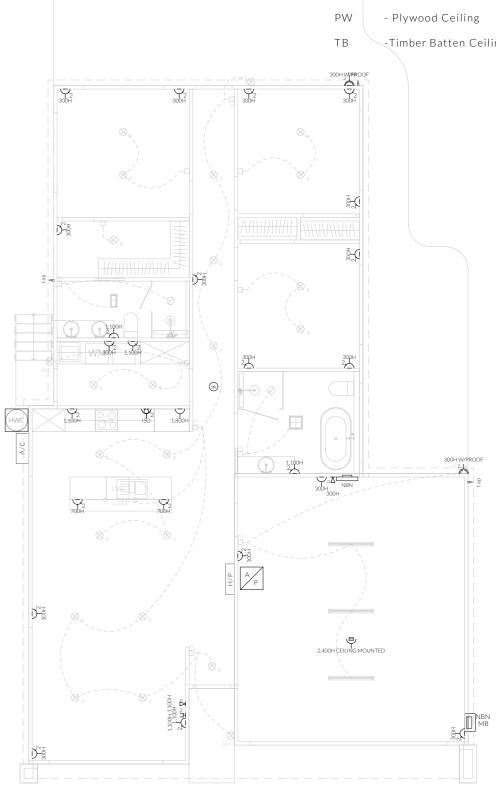
-- Ţ --- Ţ Timer Circuit(as fan note)

- Plasterboard

--р---- Dimmable Circuit

-Timber Batten Ceiling

- Cement Sheet Eaves



Electrical Plan -Lower - Light/Reflected Ceiling

bđđa

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Electrical Plan admin@pinnacledrafting.com.au Revision:

Approved by:

Pg. No: A.06

DA - 01

JN

Scale:

Proposal: New Dwelling Client: Hayden Costello & Lily Castrisios Address: 124 Athena Drive, Risdon Vale - 7016

Drawn by: CJ Job No: 079-2025 Engineer: TBA Building Surveyor: TBA


21/11/25

Date:

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Important note

All windows to be in compliance with **BAL TBA** requirements. Refer to Bushfire Protection Plan.

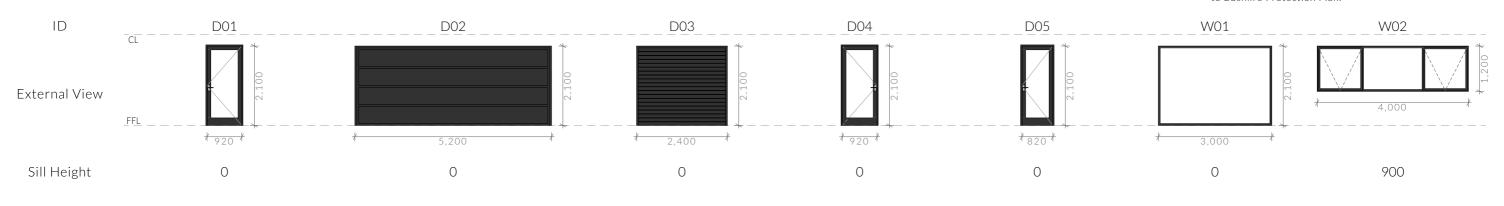

ID _W03_ W04 W05 W06 W07 W08 External View 2,100 FFL ¥ 900 ¥ Sill Height 0 600 1,500 900 900 1,200 OBSCURE OBSCURE Notes

Glazing

Notes

All glazing must comply with Section 8 of NCC Vol II 2022.

- Windows must be installed in accordance with the following:
 (a)Structural building loads must not be transferred to the window assembly.
- (b)A minimum 10 mm gap must be provided between the top of the window assembly and any loadbearing framing or masonry wall element.
- (c) The requirements of (b) may be increased where necessary to allow for frame settlement over wide openings.
- (d) Packing, if provided between each window assembly and the frame, must be-
- (i)located along each side and bottom; and
- (ii) fixed to ensure the sides and bottom of the window assembly remain straight; and
- (iii) clear of any flashing material.

If a door, side panel or panel is capable of being mistaken for a doorway or opening, the glass must be marked to make it readily visible with an opaque band not less than 20 mm in height located so that-

- (a) the upper edge is not less than 700 mm above the floor; and

(b) the lower edge is not more than 1.2 m above the floor. Refer to Part 8.4.7 for exemptions. PINNACLE DRAFTING & DESIGN

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Door & Window Schedule

Revision: www.pinnacledrafting.com.au Approved by: Licence: CC6073Y

DA - 01 JN

Pg. No: A.07

Scale:

Proposal: New Dwelling Client: Hayden Costello & Lily Castrisios

Address: 124 Athena Drive, Risdon Vale - 7016

Date: 21/11/25 Drawn by: CJ Job No: 079-2025 Engineer: TBA

Building Surveyor: TBA

